
# Cameron Prairie National Wildlife Refuge Bunkhouse


LA-27 Bell City, LA 70630

# 100% ISSUED FOR CONSTRUCTION


CONTRACT NUMBER: 140FC123F0003

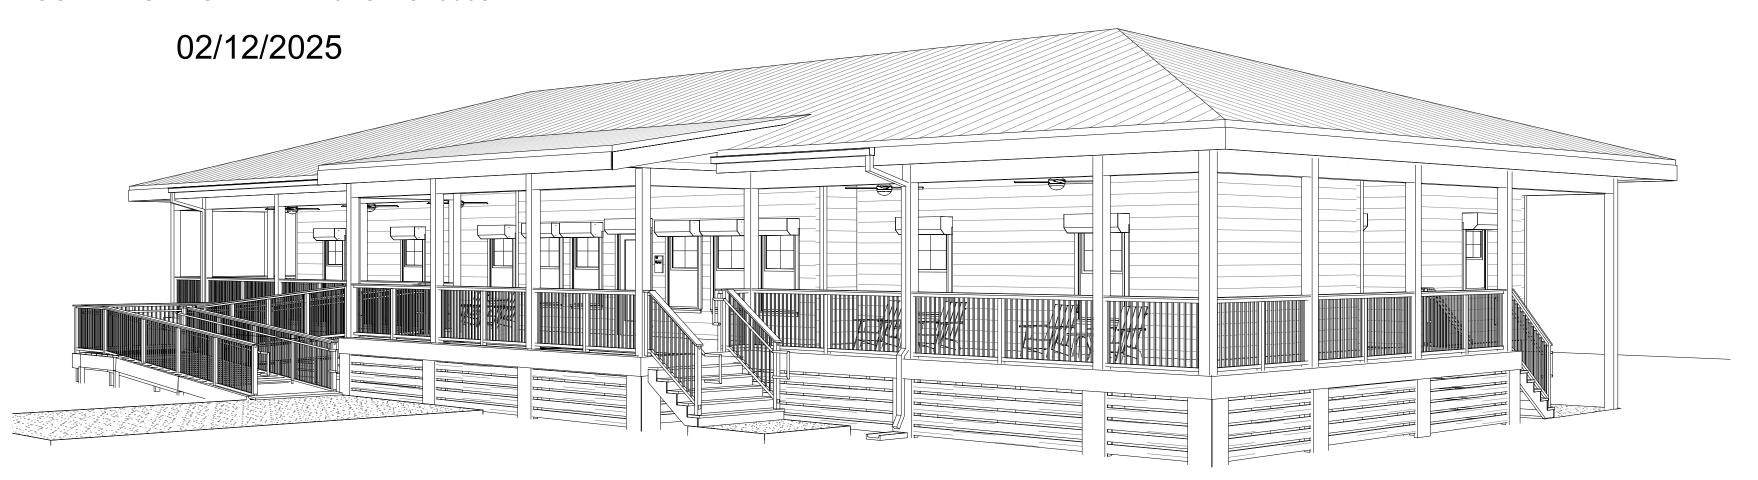

SCOPE OF WORK AREA

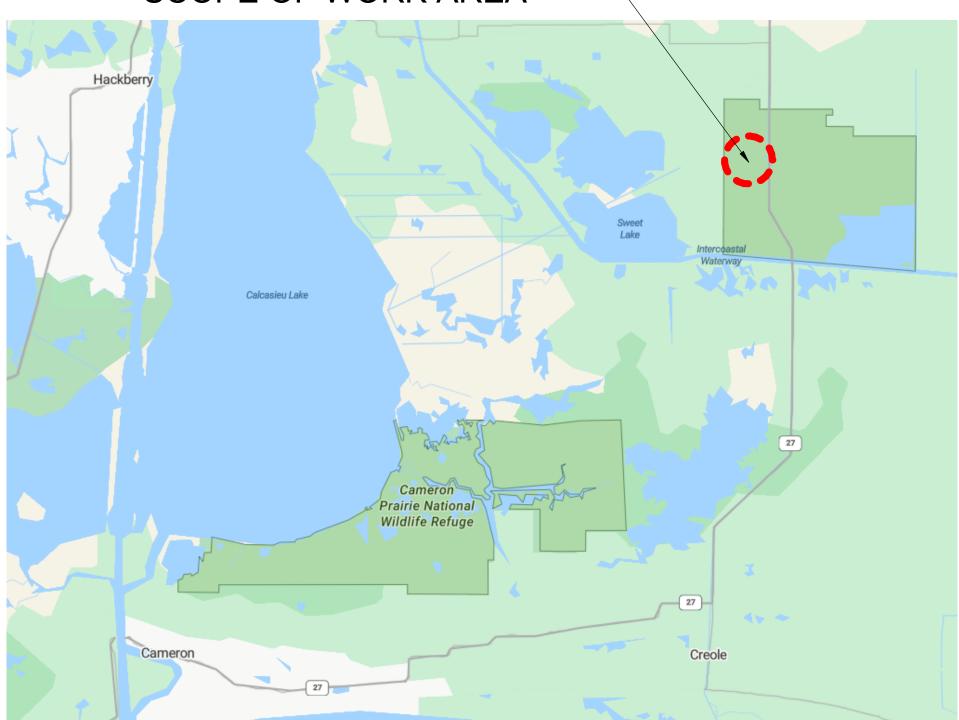

BUNKHOUSE

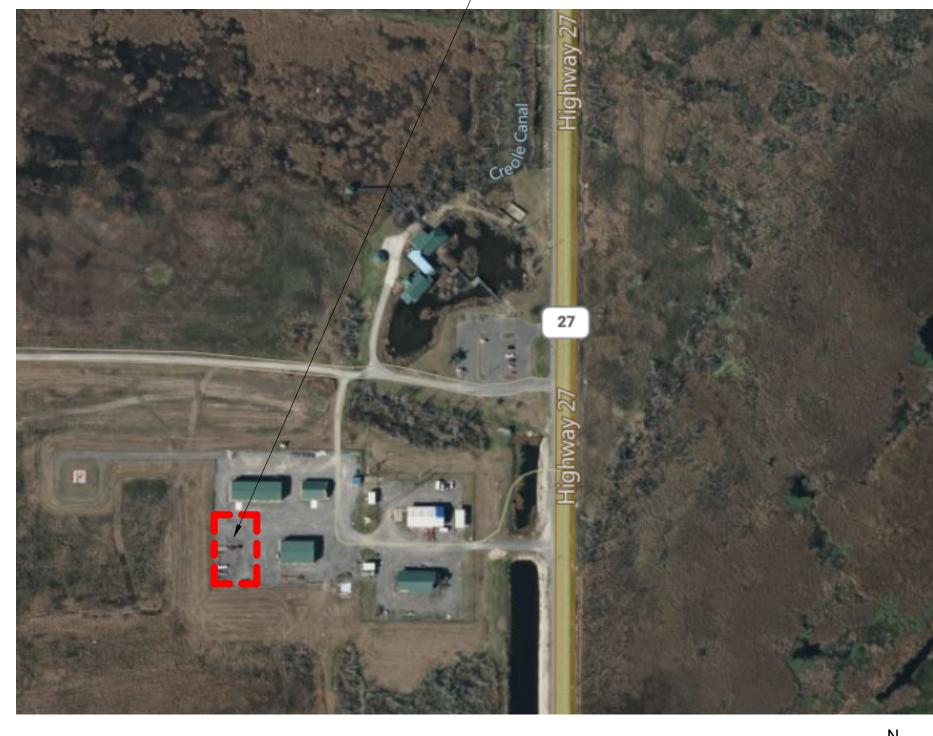

PROJECT VICINITY MAP SCALE: SCALE: N.T.S.

PROJECT LOCATION MAP

SCALE: SCALE: N.T.S.

## **DESIGN TEAM**

SURVEYOR Ballard CLC, Inc. 1009 Bayou Place Alexandria, La. 71303 Phone (318) 445-6571 Fax (318) 448-0257

CIVIL ENGINEER Linfield, Hunter, & Junius, Inc. 3608 18th Street, Suite 200 Metairie, LA 70002 Phone (504) 833-5300 Fax (504) 833-5350

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FIRE PROTECTION ENGINEER
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MECHANICAL ENGINEER
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**Peachtree Corners** Georgia 30092

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CONSULTANT

**CLIENT INFORMATION** 

**PROJECT NAME** 

Cameron Prairie National Wildlife Refuge

Bell City, LA 70630

**DRAWING ISSUE** 

DESIGNED BY: R. ELLIOTT

DRAWN BY: U. MARGULL CHECKED BY: K. KOTELLOS SUBMITTED BY: C. CUSICK 02/12/2025 PROJECT #:

SHEET TITLE

**COVER SHEET** 

G-001

SHEET SHEET NAME NUMBER **GENERAL** G-001 COVER SHEET G-002 SHEET INDEX G-004 **BUILDING CODE SUMMARY** LIFE SAFETY PLAN AIR BARRIER SHEET TOTAL: 5

SURVEYOR						
V-101	TOPOGRAPHIC AND UTILITY SURVEY					
V-102 TOPOGRAPHIC AND UTILITY SURVEY						
SHEET TOTAL: 2						

CIVIL						
C-001	CIVIL ABBREVIATIONS AND LEGEND					
CD101	DEMOLITION PLAN					
CS101	CIVIL SITE & GRADING PLAN					
CG101	GRADING PLAN					
CU101	UTILITY PLAN					
CE101	EROSION AND SEDIMENT CONTROL PLAN					
C-500	CONSTRUCTION DETAILS					
C-501	CONSTRUCTION DETAILS					
C-502	CONSTRUCTION DETAILS					
SHEET TOTAL: 9						

STRUCTURAL						
S-001	GENERAL STRUCTURAL NOTES					
S-002	GENERAL STRUCTURAL NOTES					
S-003	SCHEDULE OF SPECIAL INSPECTIONS & ABBREVIATION KEY					
S-004	WIND LOADING DIAGRAMS					
S-101	FOUNDATION PLAN					
S-111	FIRST FLOOR FRAMING PLAN					
S-121	ATTIC FRAMING PLAN					
S-151	ROOF FRAMING PLAN					
S-201	ELEVATIONS					
S-301	FOUNDATION SECTIONS					
S-311	FLOOR FRAMING SECTIONS					
S-351	ROOF FRAMING SECTIONS					
S-401	ELEVATED MECH. PLATFORM FOUNDATION PLAN & DETAILS					
S-402	ELEVATED MECH. PLATFORM FRAMING PLAN & DETAILS					
S-403	ELEVATED MECH. PLATFORM FRAMING DETAILS					
S-501	STRUCTURAL DETAILS					
S-502	ROOF TRUSS PROFILE					
S-601	SCHEDULES					
S-602	FASTENING SCHEDULES					
SHEET TOTAL: 19						

A-001	GENERAL NOTES, ABBREVIATIONS & SYMBOLS						
A-002	TYPICAL MOUNTING HEIGHTS & LOCATIONS						
A-002 A-004	MANEUVERING CLEARANCES						
A-005	PARTITION TYPES & DETAILS						
A-101	FLOOR PLAN						
A-111	ATTIC PLAN						
A-131	REFLECTED CEILING PLAN						
A-151	ROOF PLAN						
A-201	EXTERIOR ELEVATIONS						
A-202	EXTERIOR ELEVATIONS						
A-301	BUILDING SECTIONS						
A-351	WALL SECTIONS						
A-401	ENLARGED FLOOR PLANS						
A-431	INTERIOR ELEVATIONS						
A-432	INTERIOR ELEVATIONS						
A-471	VERTICAL CIRCULATION PLANS						
A-481	STAIR PLANS & SECTIONS						
A-501	PLAN & SECTION DETAILS						
A-511	ROOF SECTION DETAILS						
A-561	MILLWORK SECTIONS						
A-601	DOOR & WINDOW SCHEDULES, ELEVATIONS & DETAILS						
A-611	DOOR & WINDOW DETAILS						
SHEET T	OTAL: 22						

<b>INTERIO</b>	RS
I-101	INTERIOR FINISH PLAN
I-601	FINISH SCHEDULE & GENERAL NOTES
IF-101	FURNITURE PLAN
IG-101	SIGNAGE PLAN
IG-601	SIGNAGE SCHEDULE
SHEET T	OTAL: 5

FIRE PROTE	ECTION			
FA101	FIRE ALARM FLOOR PLAN			
FX101	FIRE SUPPRESSION FLOOR PLAN			
SHEET TOTAL: 2				
· ·				

PLUMBIN	IG					
P-001	PLUMBING GENERAL NOTES, ABBREVIATIONS, AND LEGENDS					
PW101	PLUMBING WASTE AND VENT PLAN LEVEL 1					
P-101	PLUMBING SUPPLY PLAN LEVEL 1					
P-501	PLUMBING DETAILS					
P-601	PLUMBING SCHEDULES					
P-901	WASTE AND VENT RISER DIAGRAM					
P-902	DOMESTIC WATER RISER DIAGRAM					
SHEET T	OTAL: 7					

<b>MECHANI</b>	CAL
M-001	MECHANICAL GENERAL NOTES AND DESIGN CRITERIA
M-002	MECHANICAL ABBREVIATIONS AND LEGENDS
MH101	MECHANICAL HVAC FLOOR PLAN
MH102	MECHANICAL HVAC ROOF PLAN
M-301	MECHANICAL SECTIONS
M-501	MECHANICAL DETAILS
M-502	MECHANICAL DETAILS
M-503	MECHANICAL DETAILS
M-601	MECHANICAL SCHEDULES
M-602	MECHANICAL SCHEDULES
SHEET TO	DTAL: 10

ELECTRI	CAL
E-001	ELECTRICAL GENERAL NOTES AND ABBREVIATIONS
E-002	ELECTRICAL LEGEND
E-101	LIGHTING PLAN
E-102	LIGHTING PLAN - ATTIC
E-111	POWER PLAN
E-121	MECHANICAL EQUIPMENT POWER PLAN
E-501	ELECTRICAL DETAILS
E-601	ELECTRICAL FEEDER SCHEDULE AND ONE-LINE DIAGRAM
E-611	LUMINAIRE AND MECHANICAL EQUIPMENT SCHEDULES
E-621	PANELBOARD SCHEDULES
	PANELBOARD SCHEDULES OTAL: 10

**EOR/AOR SEAL** 

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CONSULTANT

**CLIENT INFORMATION** 

US Fish & Wildlife Service

PROJECT NAME

Cameron Prairie National Wildlife Refuge Bunkhouse


LA-27 Bell City, LA 70630

DRAWING ISSUE

DESIGNED BY: R. ELLIOTT DRAWN BY: U. MARGULL CHECKED BY: K. KOTELLOS SUBMITTED BY: C. CUSICK 02/12/2025 PROJECT #: 1220834

SHEET TITLE

SHEET INDEX

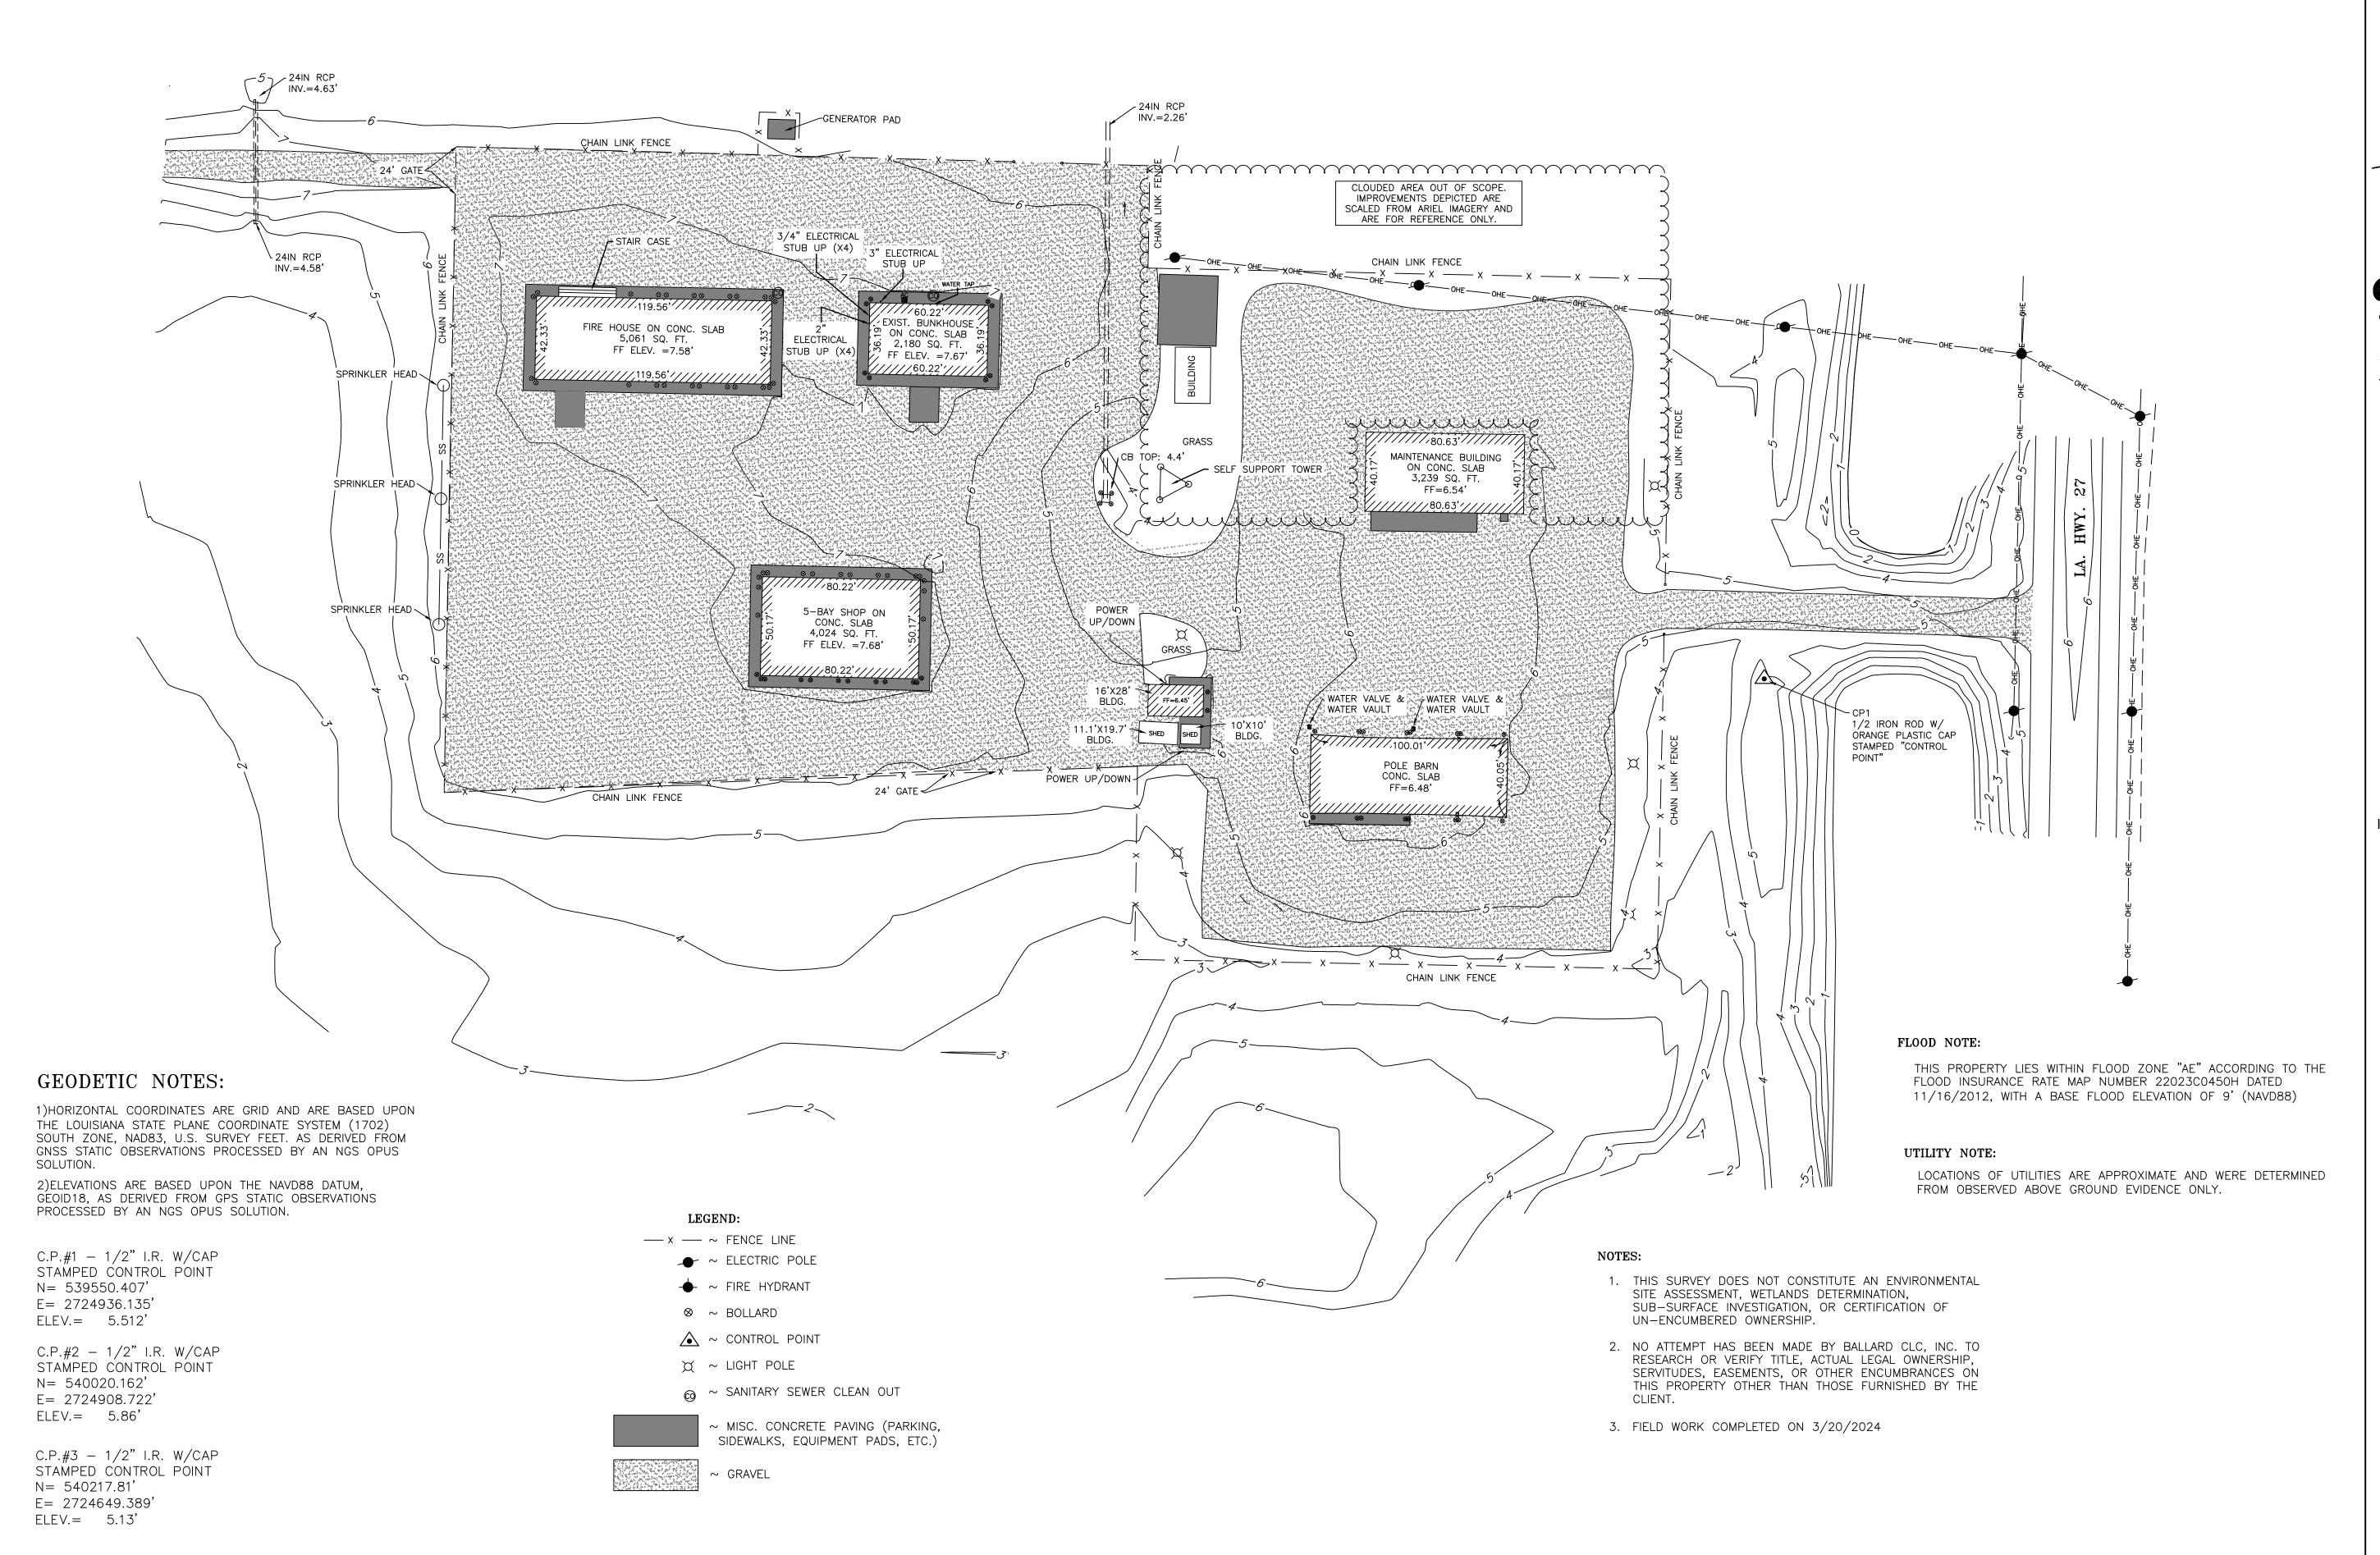

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CLC, Inc.

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PROJECT NAME

Cameron Prairie National Wildlife Refuge Bunkhouse

LA-27 BELL CITY, LOUISIANA 70630 IN SECTION 28, T12S-R7W CAMERON PARISH

DRAWING ISSUE

L

NOIL

DESIGNED BY:

DRAWN BY:

CHECKED BY:

SUBMITTED BY:

DATE OF PLAT:

L. BROOM

C. CUSICK

12/04/2024

FINAL FIELD DATE: 3/20/2024


PROJECT #: 1220834
SHEET TITLE

TOPOGRAPHIC AND UTILITY SURVEY

SHEET NUMBER

ORIGINAL SHEET SIZE: 24" X 36"


SCALE: 1/4" = 10'-0"

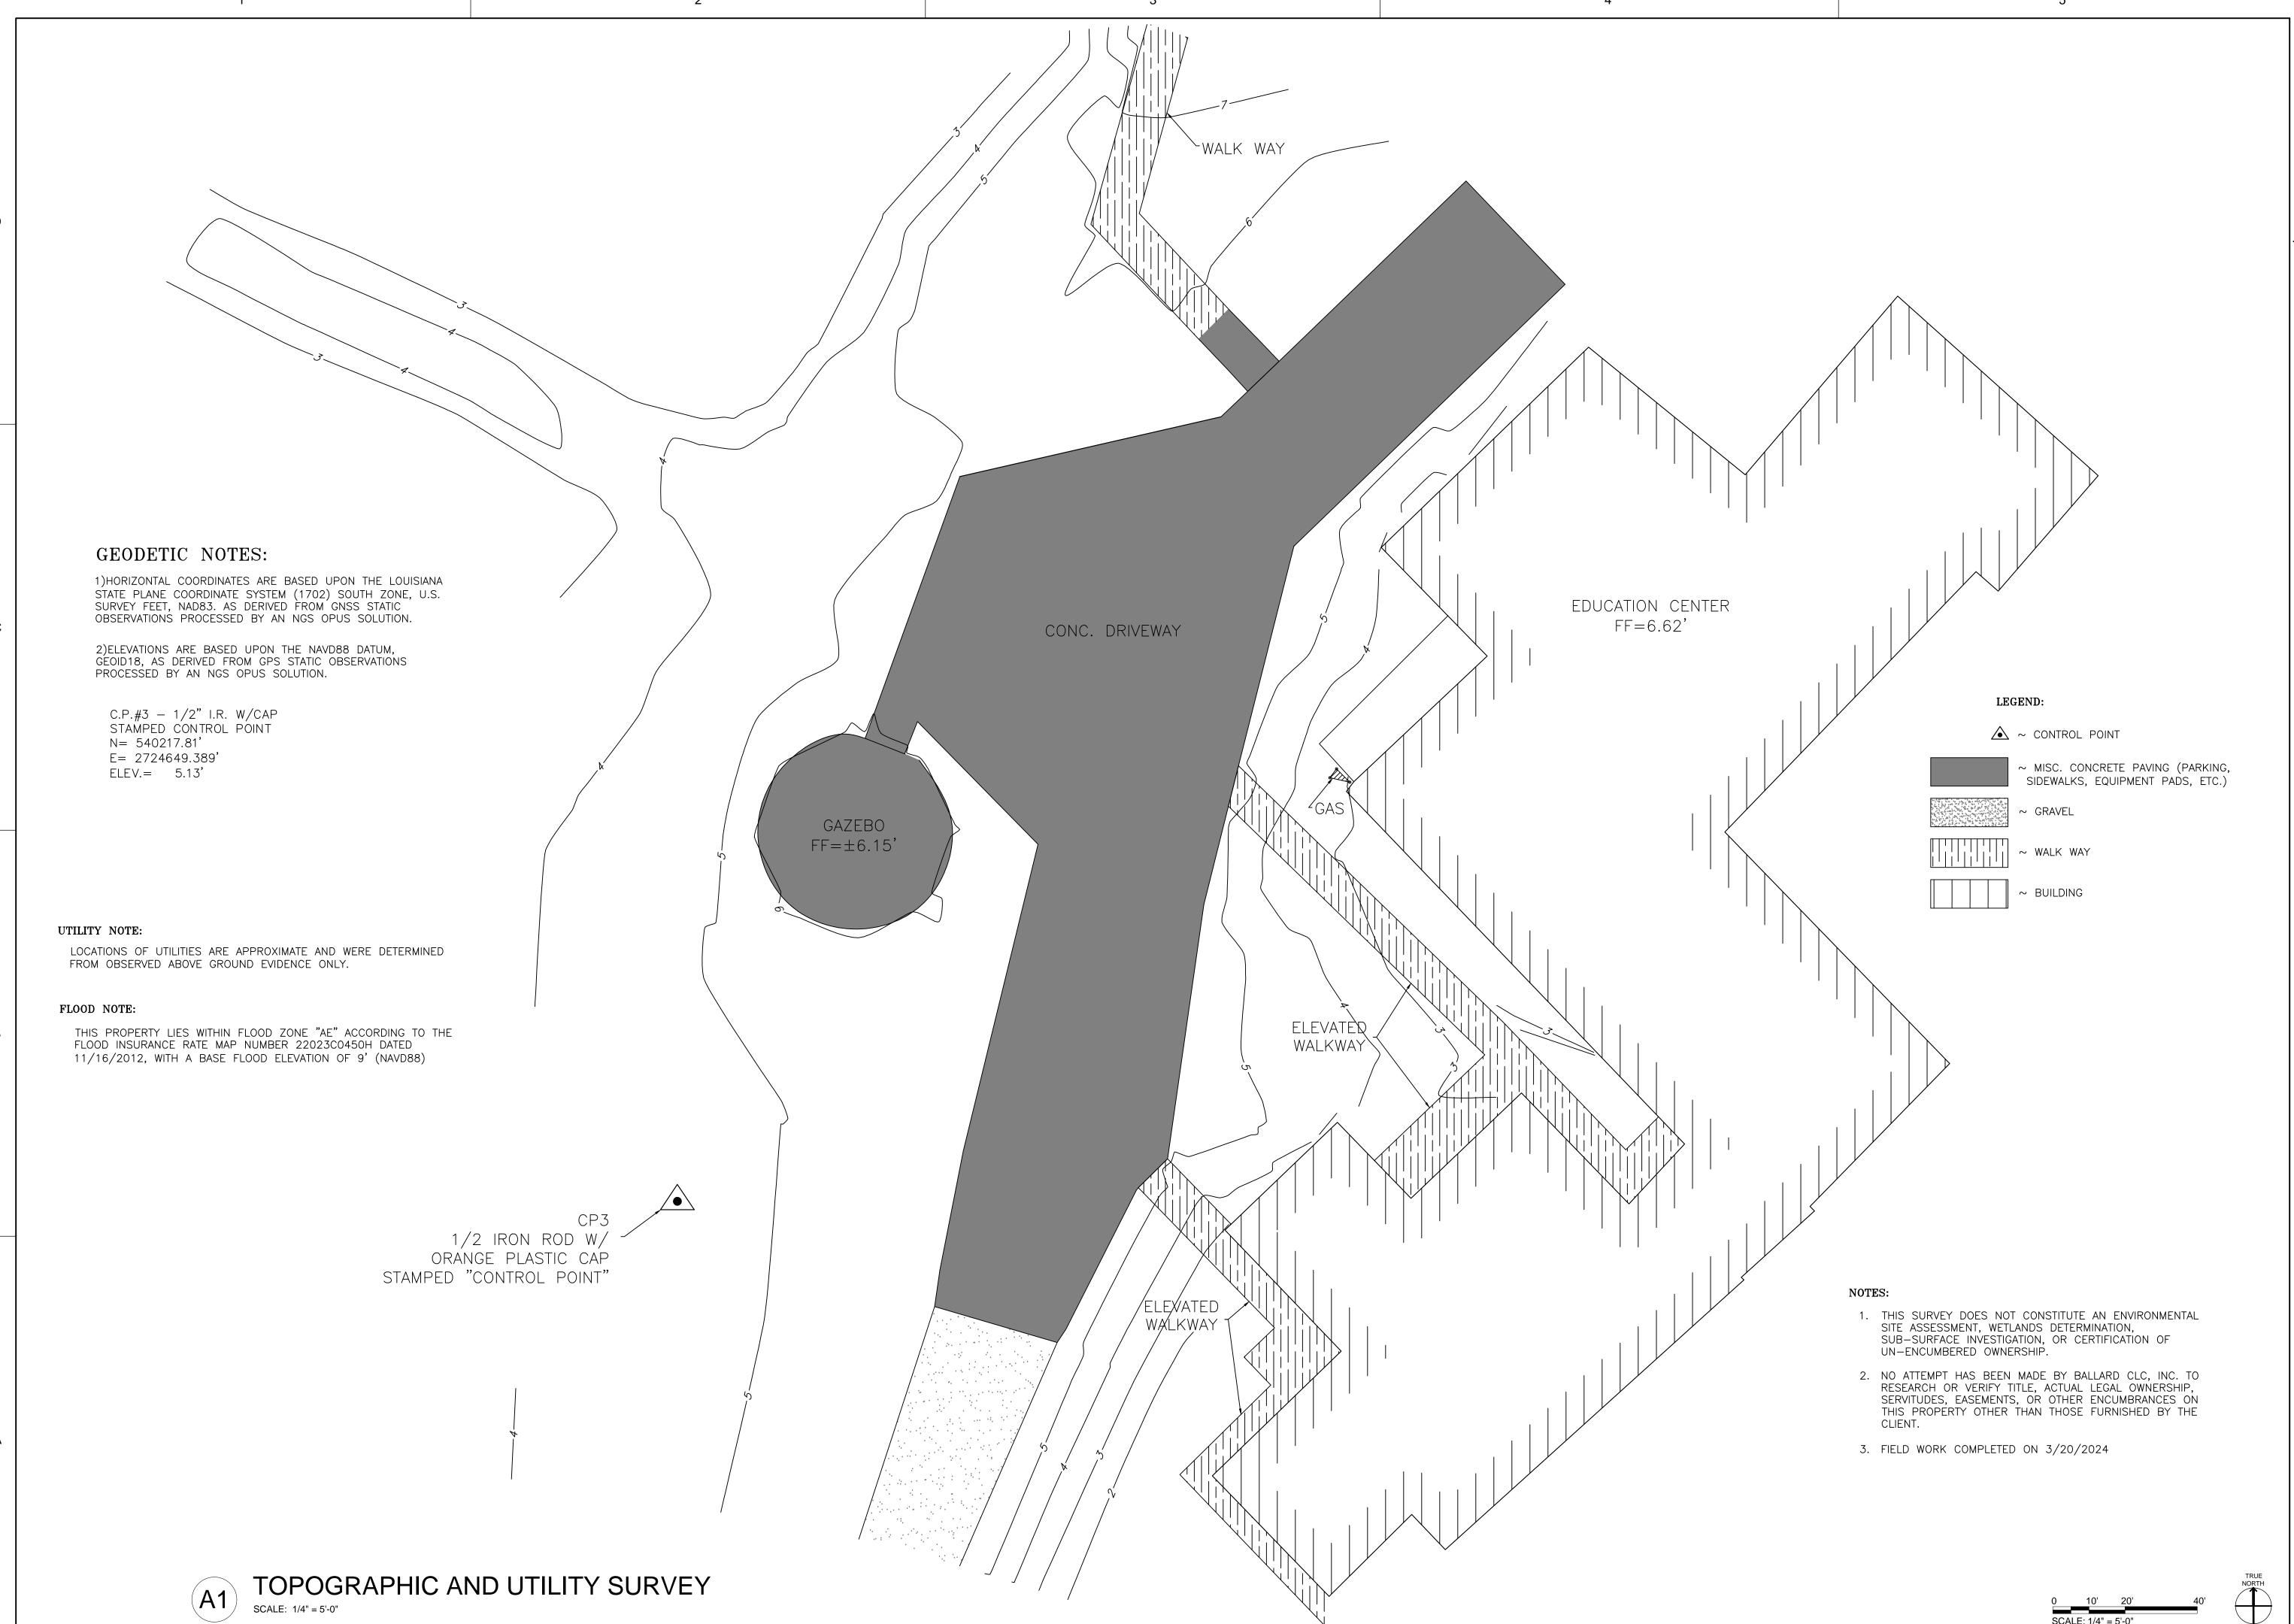

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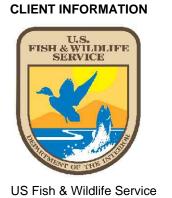
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el: (318) 445-65/1 Fax: (318) 448-025



PROJECT NAME

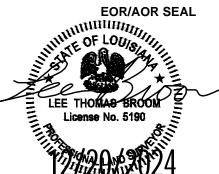Cameron Prairie National Wildlife Refuge Bunkhouse

LA-27 BELL CITY, LOUISIANA 70630 IN SECTION 28, T12S-R7W CAMERON PARISH

DRAWING ISSUE

DATE

RIPTION

~

DESIGNED BY:

DRAWN BY: E. CAMPNEY
CHECKED BY: L. BROOM
SUBMITTED BY: C. CUSICK
DATE OF PLAT: 12/04/2024
FINAL FIELD DATE: 3/20/2024

PROJECT #: 1220834

SHEET TITLE

TOPOGRAPHIC AND UTILITY SURVEY

SHEET NUMBER

### PROJECT INFORMATION

PROJECT NAME: FWS - CAMERON PRAIRIE NATIONAL WILDLIFE REFUGE BUNKHOUSE PROJECT LOCATION: BELL CITY, LA; CALCASIEU PARISH

DEMOLITION OF EXISTING BUNKHOUSE IS BY GOVERNMENT AND NOT IN SCOPE. REFER TO CIVIL SHEET CD101 FOR ADDITIONAL INFORMATION.

PROJECT SCOPE: CONSTRUCT A NEW BUNKHOUSE. PROJECT INCLUDES BEDROOMS, LIVING/COMMON AREA, RESIDENTIAL KITCHEN, RESTROOMS, (2) EFFICIENCY APARTMENTS, LAUNDRY AND UTILITY ROOM. PROJECT ALSO INCLUDES NEW GRAVEL PARKING AND DRIVE WITH CONCRETE HANDICAP PARKING PAD. CONSTRUCTION TO CONSIST OF WOOD FRAMING, METAL ROOF, CEMENT BOARD SIDING, INSULATED WINDOWS AND DOORS WITH LOW-E GLAZING, HURRICANE SHUTTERS, HARDWARE, AND UTILITIES FOR A FULLY FUNCTIONAL FACILITY.

### **LIST OF APPLICABLE CODES**

LOUISIANA UNIFORM STATE CONSTRUCTION CODE INTERNATIONAL BUILDING CODE (IBC), 2021 WITH AMENDMENTS
INTERNATIONAL FIRE CODE (IFC), 2021 WITH AMENDMENTS
INTERNATIONAL PLUMBING CODE (IPC), 2021 WITH AMENDMENTS
INTERNATIONAL MECHANICAL CODE (IMC), 2021 WITH AMENDMENTS
NATIONAL ELECTRICAL CODE (NEC), 2023
INTERNATIONAL ENERGY CONSERVATION CODE (IECC), 2021
NATIONAL FIRE PROTECTION ASSOCIATION (NFPA) 101: LIFE SAFETY CODE (LSC), 2021
2010 ADA - ABA ACCESSIBILITY GUIDELINES TITLE II
ANSI/ASHRAE/IESNA 90.1 - 2019

### OCCUPANCY CLASSIFICATION (IBC CHAPTER 3):

OCCUPANCY CLASSIFICATION (302): R3

MIXED OCCUPANCY (508): N/A

### **OCCUPANCY CLASSIFICATION (LSC CHAPTER 6):**

OCCUPANCY CLASSIFICATION (6.1): CH 26 LODGING & ROOMING HOUSES

MIXED OCCUPANCY (6.1.14.1): N/A

### **GENERAL BUILDING HEIGHT & AREAS (IBC CHAPTER 5):**

ALLOWABLE HEIGHT - FEET (TABLE 504.3):

RESIDENTIAL (R3): 40'-0" ACTUAL = 21'-9"

ALLOWABLE HEIGHT - STORIES (TABLE 506.2):

RESIDENTIAL (R3): 3 STORY ACTUAL = 1 STORY

ALLOWABLE AREA PER STORY (TABLE 506.2):

RESIDENTIAL (R3): UL SF ACTUAL = 3515 SF

ALLOWABLE AREA FRONTAGE INCREASE (506.3.3): NOT REQUIRED

ALLOWABLE AREA TOTAL (506.2.4): UNLIMITED

### TYPES OF CONSTRUCTION (IBC CHAPTER 6):

TYPE OF CONSTRUCTION (TABLE 601): V-B SPRINKLERED

FIRE RESISTANCE (TABLE 601):

STRUCTURAL FRAME COLUMNS, GIRDERS, TRUSSES

(NOT REQUIRED WHEN > 20' ABOVE FLOOR) **0 HOURS** 

BEARING WALLS EXTERIOR

EXTERIOR 0 HOURS INTERIOR 0 HOURS

NONBEARING WALLS AND PARTITIONS

EXTERIOR (TABLE 601)  $X \ge 30$  0 HOURS INTERIOR (TABLE 601) 0 HOURS

FLOOR CONSTRUCTION 0 HOURS

N/A

STAIR ENCLOSURE

ELEVATOR SHAFT N/A

FIRE PROTECTION SYSTEMS (IBC CHAPTER 9):

AUTOMATIC SPRINKLER SYSTEM (903.2.8) REQUIRED / PROVIDED

STANDPIPE SPRINKLER SYSTEM (905) NOT REQUIRED / NOT PROVIDED

NOT REQUIRED / NOT PROVIDED

PORTABLE FIRE EXTINGUISHERS (906) REQUIRED / PROVIDED

FIRE ALARM & DETECTION (907) REQUIRED / PROVIDED

MEANS OF EGRESS (LSC CHAPTER 7):

MASS NOTIFICATION SYSTEM (917)

MAXIMUM FLOOR AREA ALLOWABLE / OCCUPANT (TABLE 7.3.1.2)

RESIDENTIAL BOARD & CARE: 200 SF/P GROSS

ASSEMBLY LESS-CONCENTRATED USE: 15 SF/P GROSS FIRE PARTITIONS:

708.3 1HR FIRE RATING 20MIN DOOR PER T716.1.2

OCCUPIED AREA

RESIDENTIAL R3:

2821 SF

2821 / 200 = 15 OCCUPANTS

LESS-CONCENTRATED ASSEMBLY: 694 SF 694 / 15 = 47 OCCUPANTS

**EGRESS WIDTH** 

LEVEL COMPONENTS AND RAMPS (TABLE 7.3.3.1)

0.2 \* 63 = **12.6" MINIMUM 60" PROVIDED** 

NUMBER OF EXITS (7.4.1.1): NOT LESS THAN 2 3 PROVIDED

COMMON PATH OF TRAVEL

(IBC 1006.2.2.6) MAXIMUM COMMON PATH EGRESS TRAVEL DISTANCE= 125 FT

TRAVEL DISTANCE= 125 FT 38'-7"

DEAD ENDS

(IBC 1020.5) DEAD ENDS = 20 FT **N/A** 

TRAVEL DISTANCE TO EXITS

(IBC 1017.2) EXIT ACCESS TRAVEL DISTANCE = 125 FT 48 FT

**CORRIDOR RATING** 

RESIDENTIAL (IBC 708.3) 1 HOURS

PLUMBING SYSTEMS (IBC CHAPTER 19):

PLUMBING FIXTURE CALCULATIONS ARE BASED ON IBC OCCUPANT LOAD (IBC CHAPTER 10)

MAXIMUM FLOOR AREA ALLOWABLE / OCCUPANT (TABLE 1004.5)

RESIDENTIAL APT: 2 UNITS

RESIDENTIAL: 2812 SF/P GROSS

OCCUPIED AREA OCCUPANT LOAD

RESIDENTIAL APT: 2 UNITS 1 PER UNIT RESIDENTIAL: 2812 GSF / 200 GSF= 14.06 OCCUPANTS

TOTAL = 2812 GSF TOTAL = 15 OCCUPANTS

PLUMBING FIXTURES (TABLE 2902.1) REQUIRED PROVIDED

WATER CLOSETS

RESIDENTIAL APT- 1 PER DWELLING 2
BOARDING HOUSE NON-TRANSIENT 1 PER 10 2

**LAVATORIES** 

RESIDENTIAL APT- 1 PER DWELLING 2
BOARDING HOUSE NON-TRANSIENT 1 PER 10 2
TOTAL 4

**DRINKING FOUNTAINS** 

RESIDENTIAL APT-

BOARDING HOUSE NON-TRANSIENT 1 PER100

TOTAL

WASHER DRYER

RESIDENTIAL APT- 1 PER 20 1
BOARDING HOUSE NON-TRANSIENT -

KITCHEN SINKS

RESIDENTIAL APT- 1 PER DWELLING

BOARDING HOUSE NON-TRANSIENT

2

**TOTAL** 

SERVICE SINKS

 RESIDENTIAL APT 

 BOARDING HOUSE NON-TRANSIENT
 1
 1

 1
 1
 1

 1
 1
 1

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EOR/AOR SEAL

CONSULTANT

CLIENT INFORMATION

U.S.
FISH & WILDLIFE
SERVICE

PROJECT NAME

US Fish & Wildlife Service

Cameron Prairie National Wildlife

Refuge Bunkhouse

LA-27 Bell City, LA 70630

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DRAWING ISSUE


DESIGNED BY: R. ELLIOTT
DRAWN BY: U. MARGULL

SHEET TITLE

CHECKED BY: K. KOTELLOS
SUBMITTED BY: C. CUSICK
DATE: 02/12/2025
PROJECT#: 1220834

BUILDING CODE SUMMARY

SHEET NUMBER

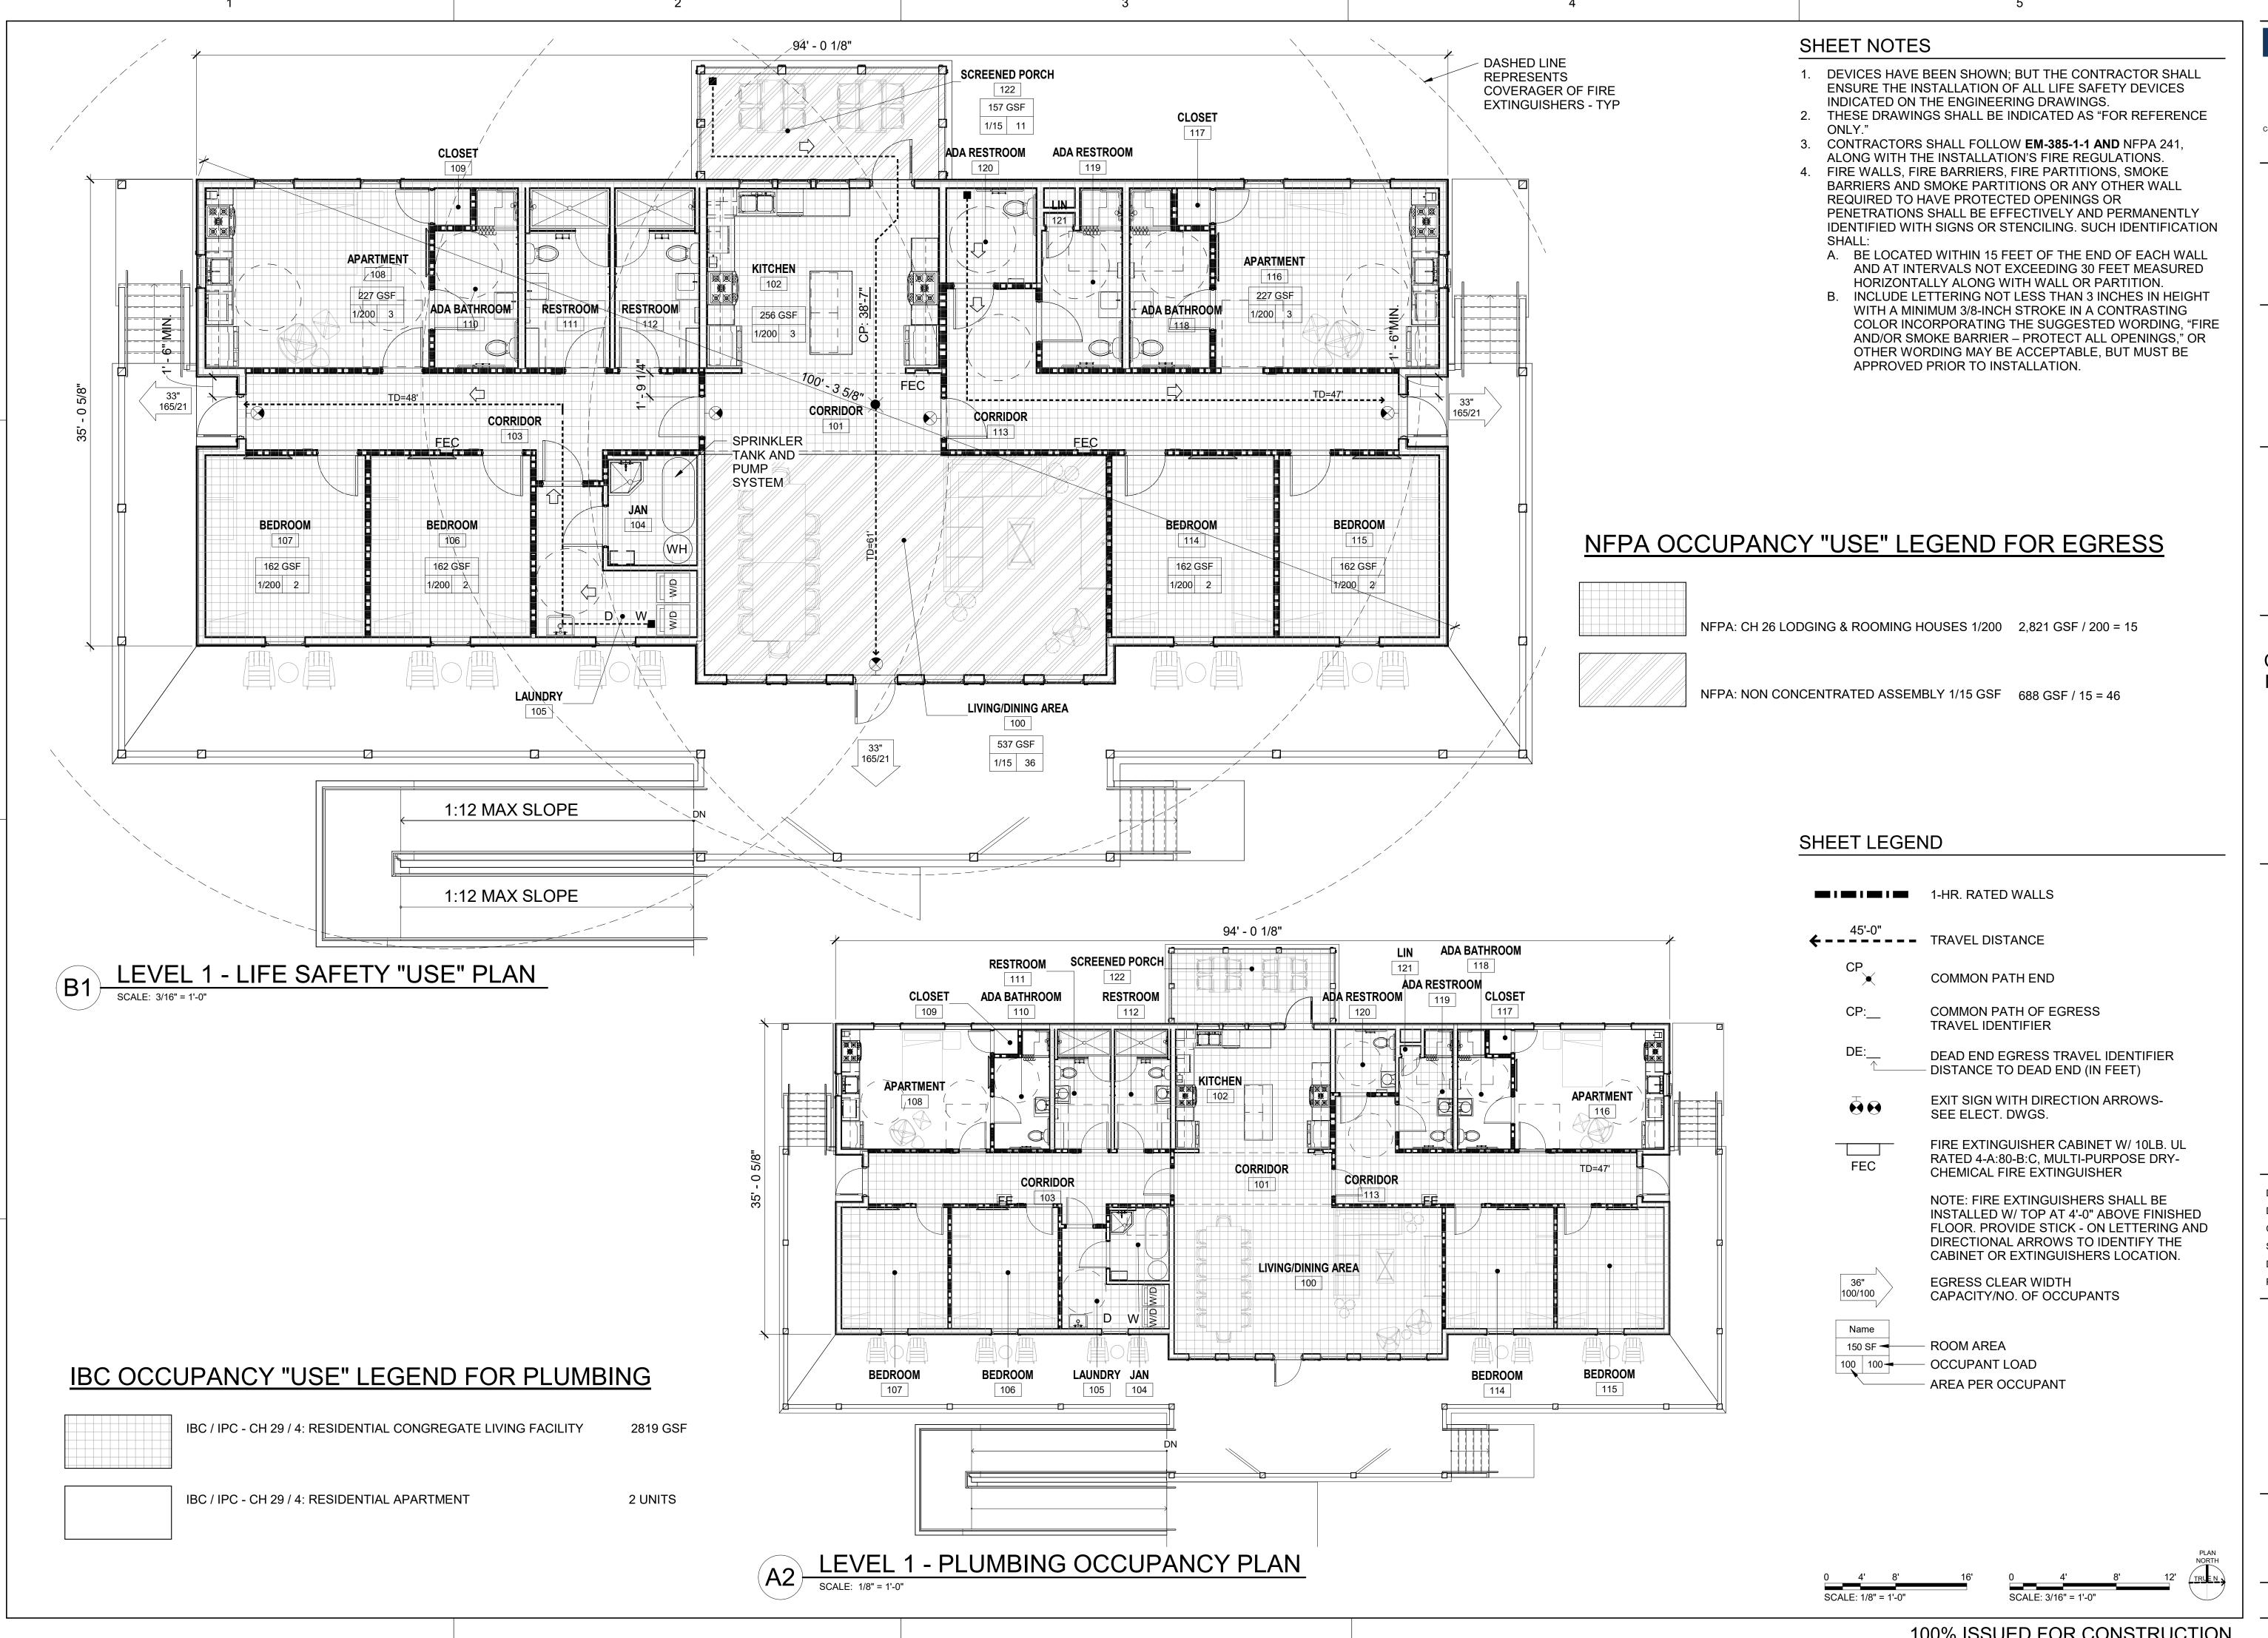

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CONSULTANT

**CLIENT INFORMATION** 

US Fish & Wildlife Service

**PROJECT NAME** 

Cameron Prairie National Wildlife Refuge Bunkhouse

> LA-27 Bell City, LA 70630

**DRAWING ISSUE** 

DESIGNED BY: R. ELLIOTT DRAWN BY: U. MARGULL CHECKED BY: K. KOTELLOS SUBMITTED BY: C. CUSICK 02/12/2025 1220834 PROJECT #:

SHEET TITLE

LIFE SAFETY PLAN

SHEET NUMBER G-101

### SHEET NOTES

----- PERIMETER OF AIR BARRIER


BUILDING SPACE ENCLOSED BY AIR BARRIER SYSTEM THAT IS CONTINUOUS AND CONNECTED ACROSS THE SIX FACES OF THE BUILDING ENVELOPE MEETING THE REQUIREMENTS OF SPECIFICATION SECTION 07 27 10.00 10 & UFC 3-101-01 3-6 (APPENDIX A-5.4)

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PROJECT NAME

Cameron Prairie National Wildlife Refuge Bunkhouse

> LA-27 Bell City, LA 70630

> > DRAWING ISSUE

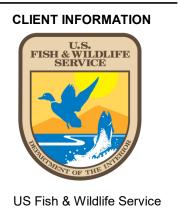RIPTION

DESIGNED BY: R. ELLIOTT


DRAWN BY: U. MARGULL
CHECKED BY: K. KOTELLOS
SUBMITTED BY: C. CUSICK
DATE: 02/12/2025
PROJECT#: 1220834

AIR BARRIER

SHEET TITLE

AIR BARRIER

G-121

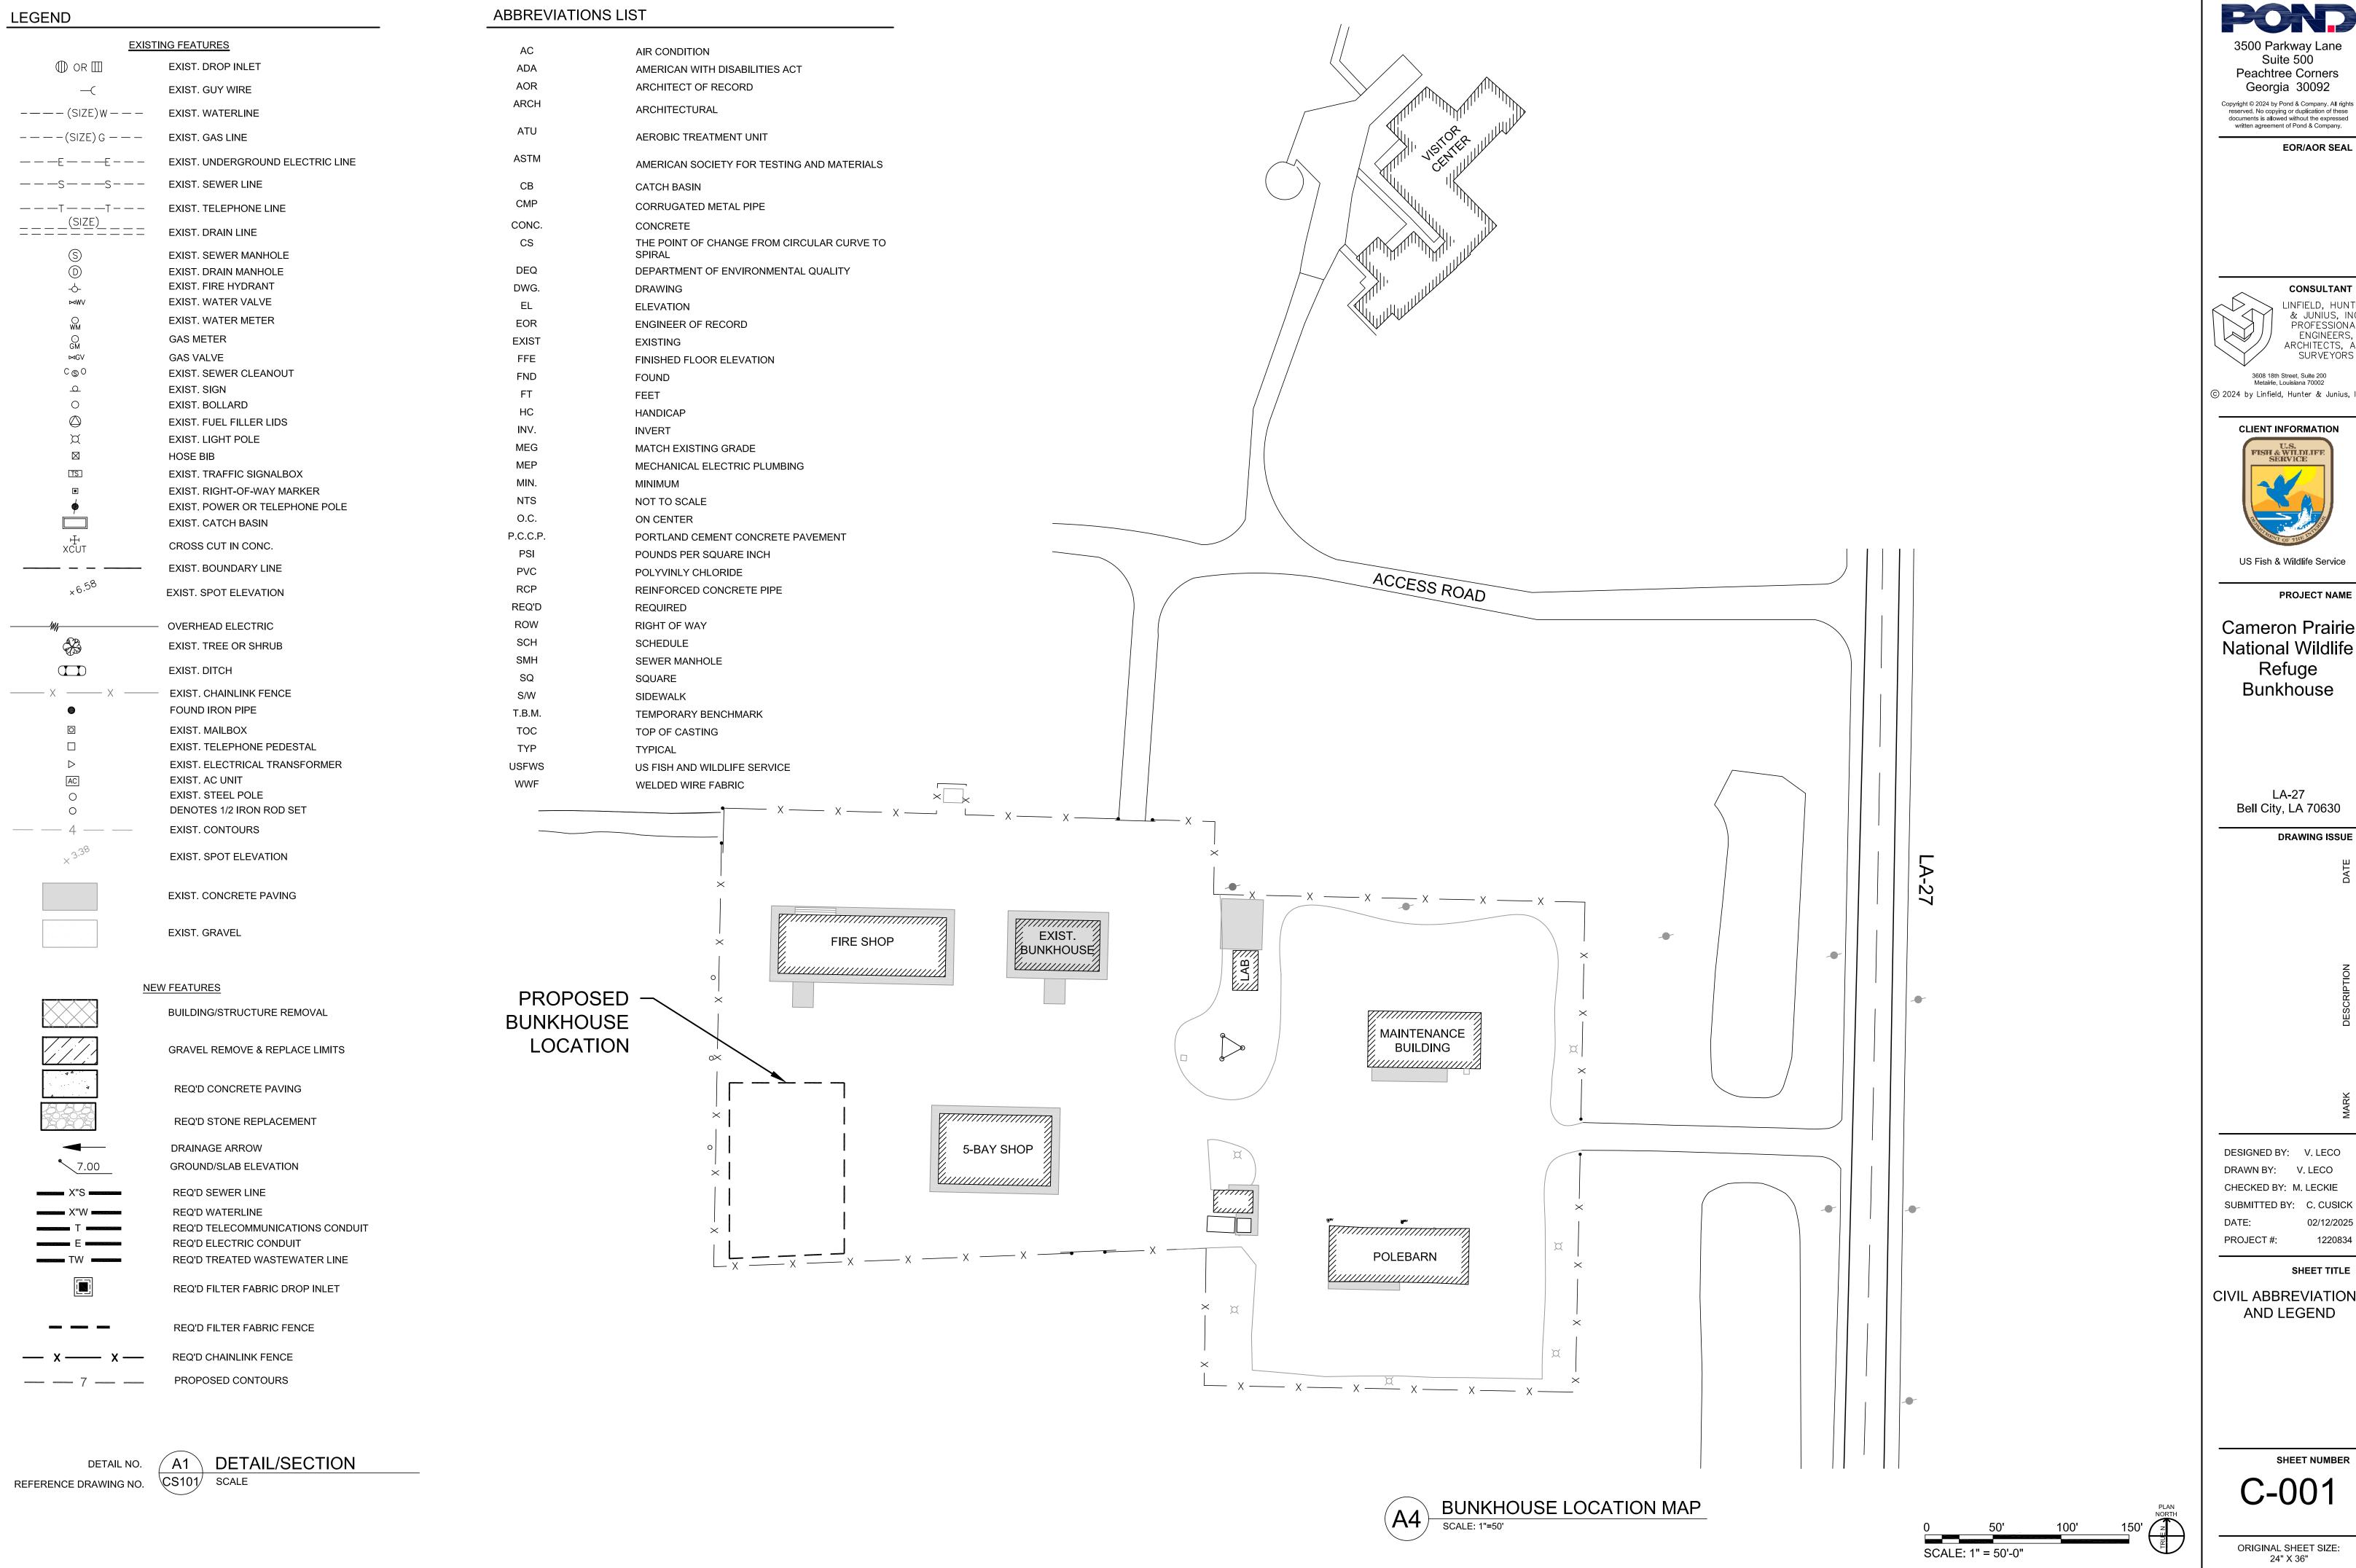

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US Fish & Wildlife Service

PROJECT NAME

Cameron Prairie National Wildlife Refuge Bunkhouse

> LA-27 Bell City, LA 70630

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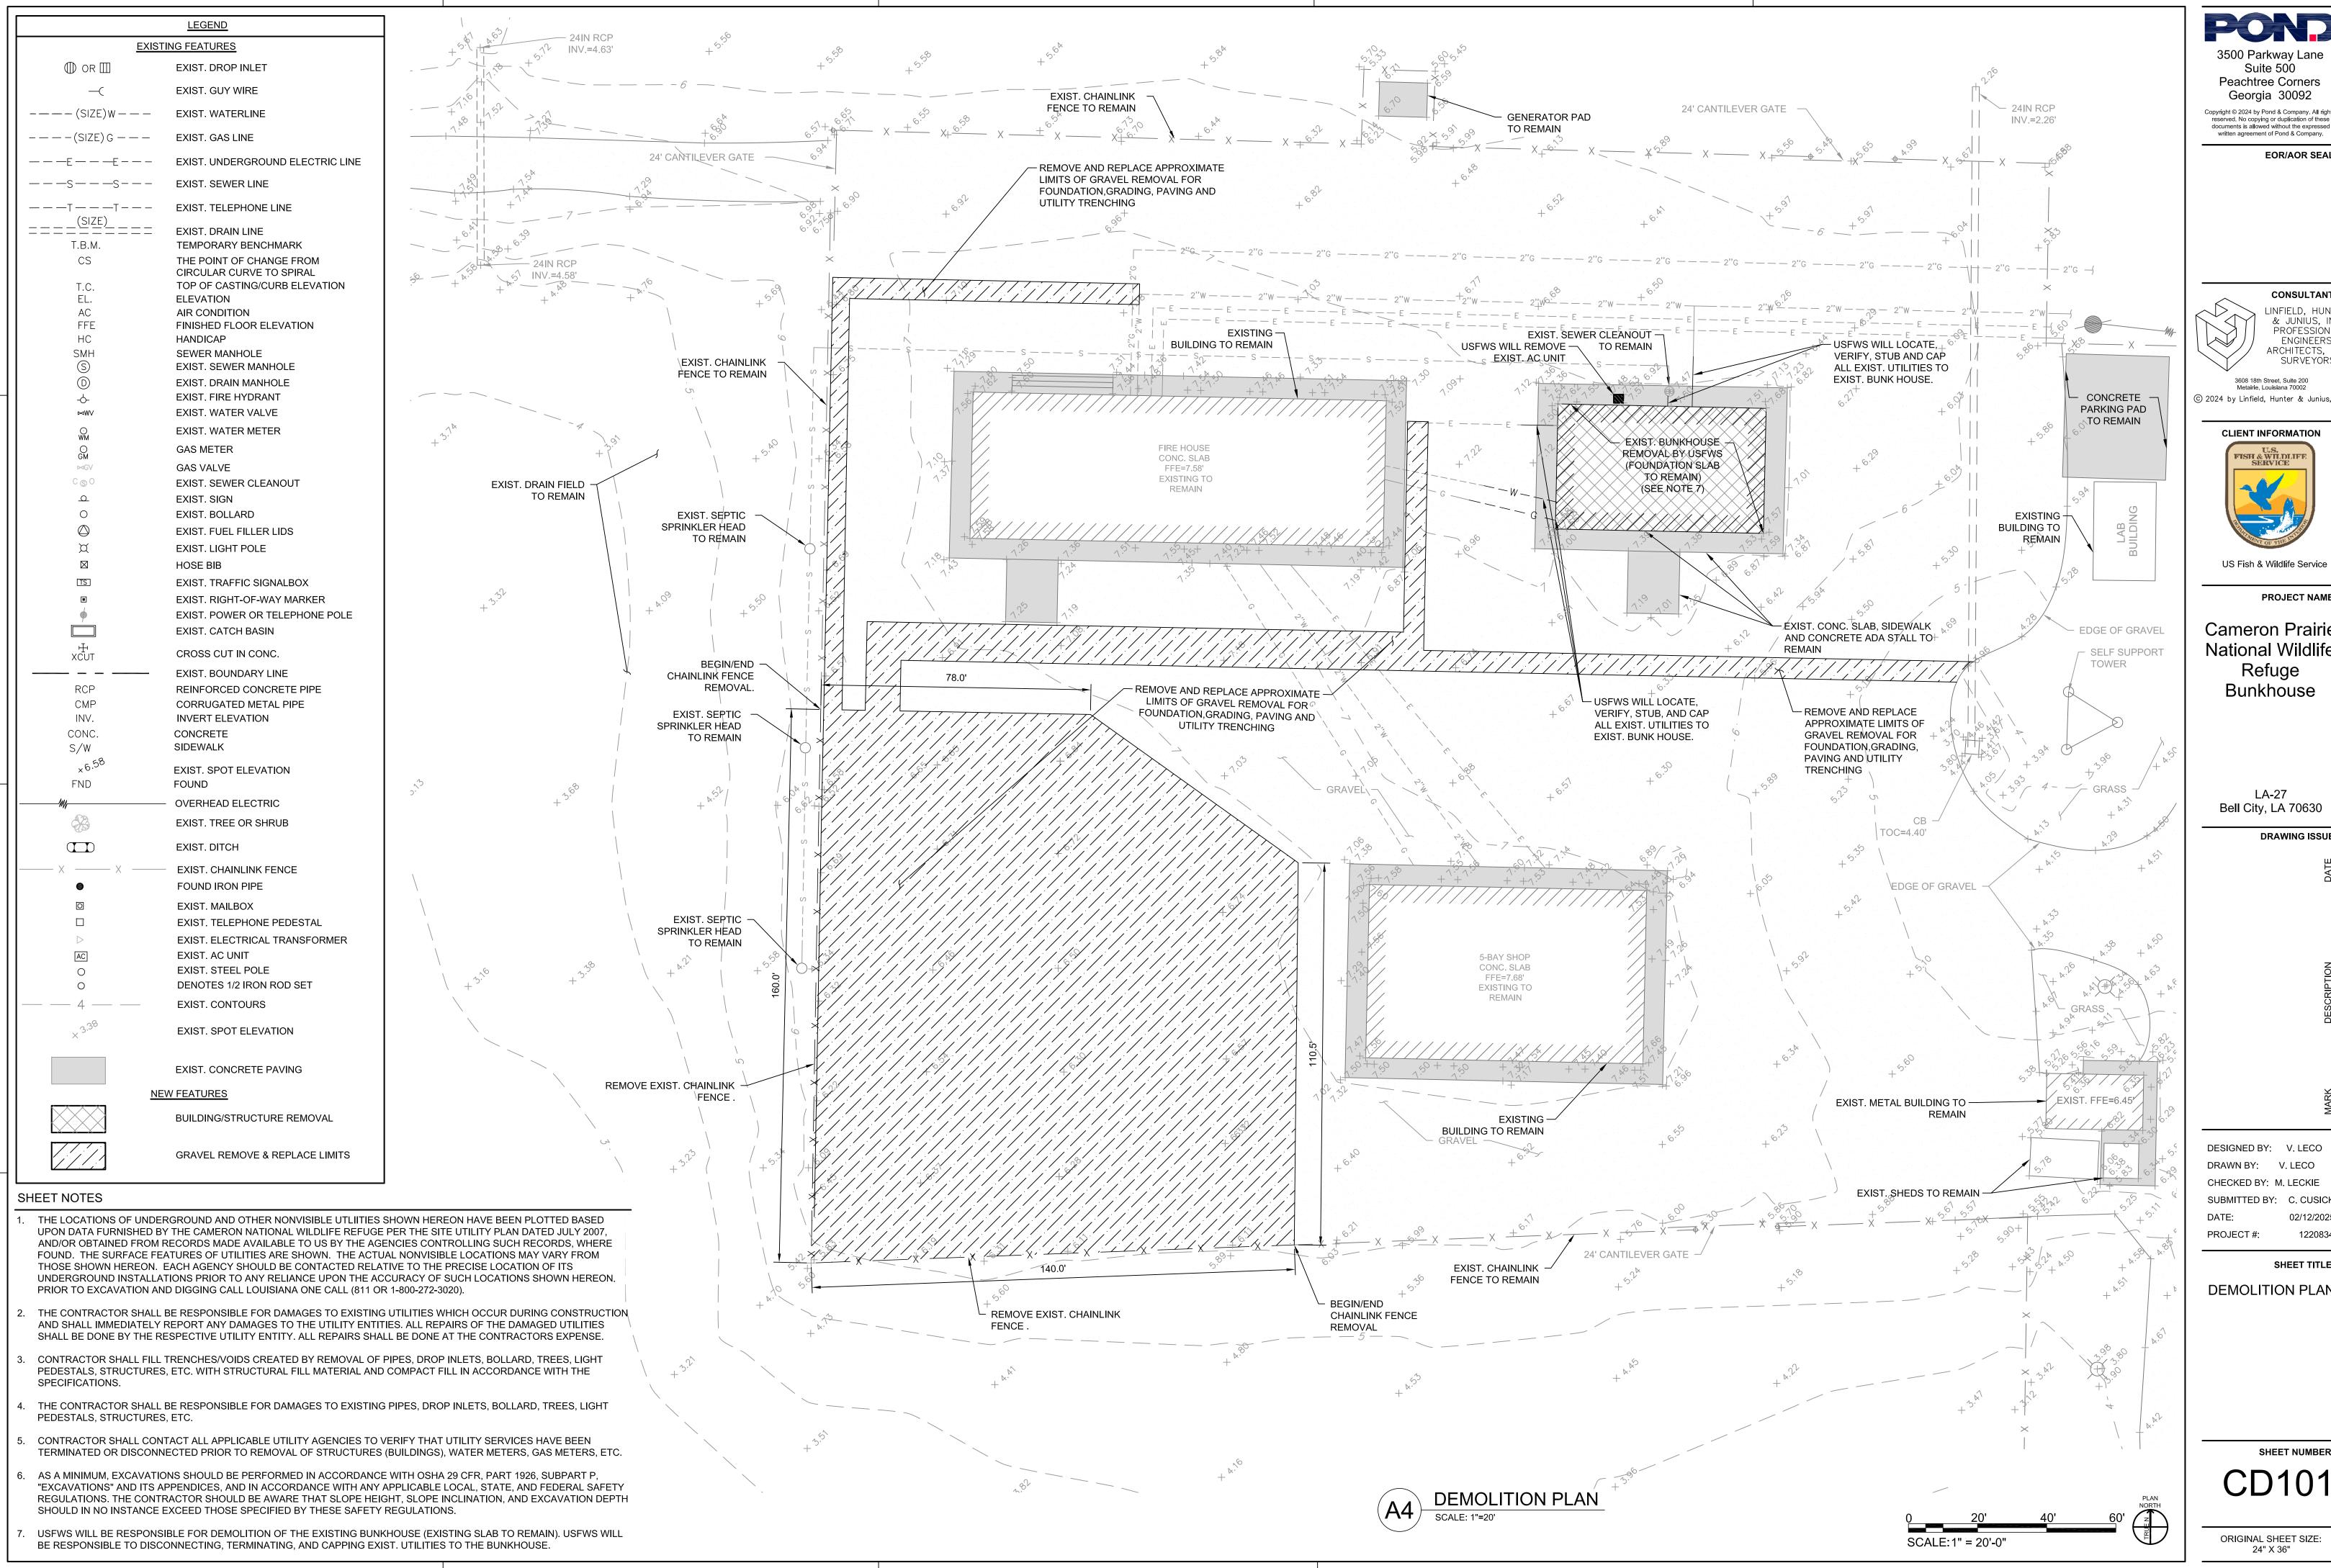
DESIGNED BY: V. LECO DRAWN BY: V. LECO CHECKED BY: M. LECKIE SUBMITTED BY: C. CUSICK 02/12/2025

SHEET TITLE

CIVIL ABBREVIATIONS AND LEGEND

SHEET NUMBER

ORIGINAL SHEET SIZE:



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**PROJECT NAME** 

Cameron Prairie National Wildlife Refuge Bunkhouse

LA-27 Bell City, LA 70630

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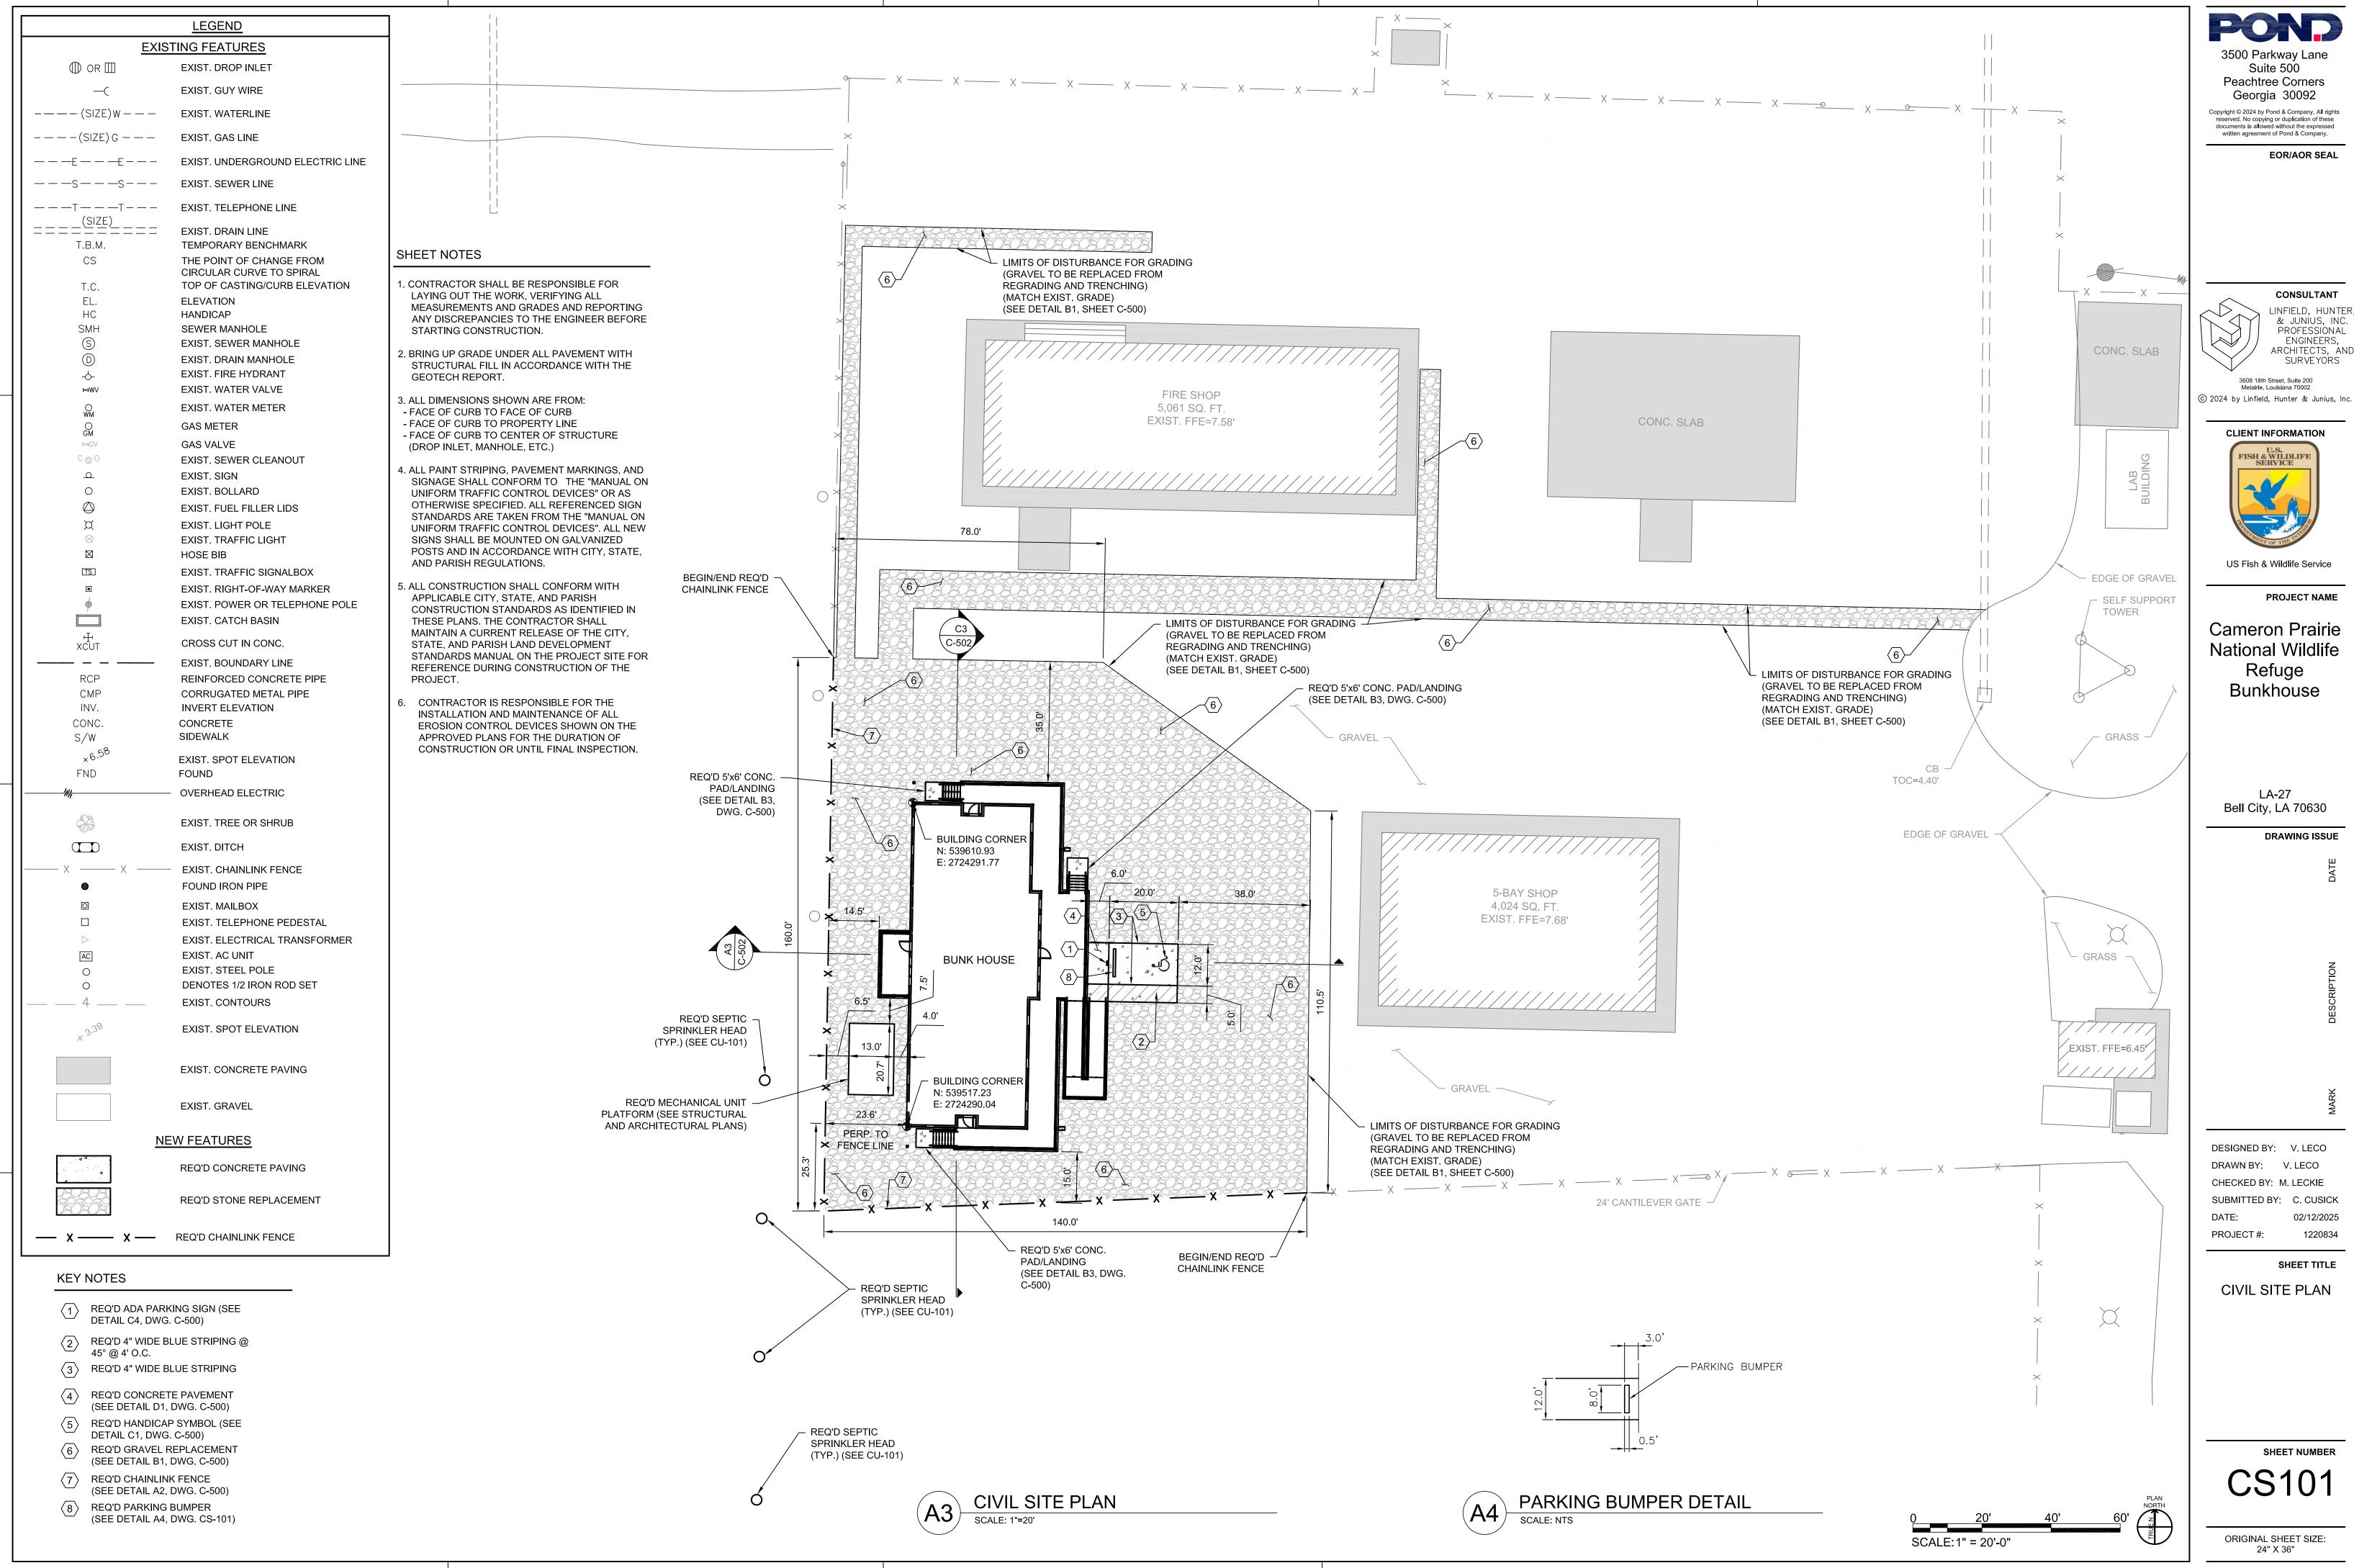
DESIGNED BY: V. LECO DRAWN BY: V. LECO CHECKED BY: M. LECKIE SUBMITTED BY: C. CUSICK 02/12/2025

SHEET TITLE

1220834

DEMOLITION PLAN

SHEET NUMBER



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**CLIENT INFORMATION** U.S. FISH & WILDLIFI SERVICE

US Fish & Wildlife Service

PROJECT NAME

Cameron Prairie National Wildlife Refuge Bunkhouse

> LA-27 Bell City, LA 70630

**DRAWING ISSUE** 


DESIGNED BY: V. LECO DRAWN BY: V. LECO CHECKED BY: M. LECKIE SUBMITTED BY: C. CUSICK 02/12/2025 PROJECT #: 1220834


SHEET TITLE

CIVIL SITE PLAN

SHEET NUMBER

CS101

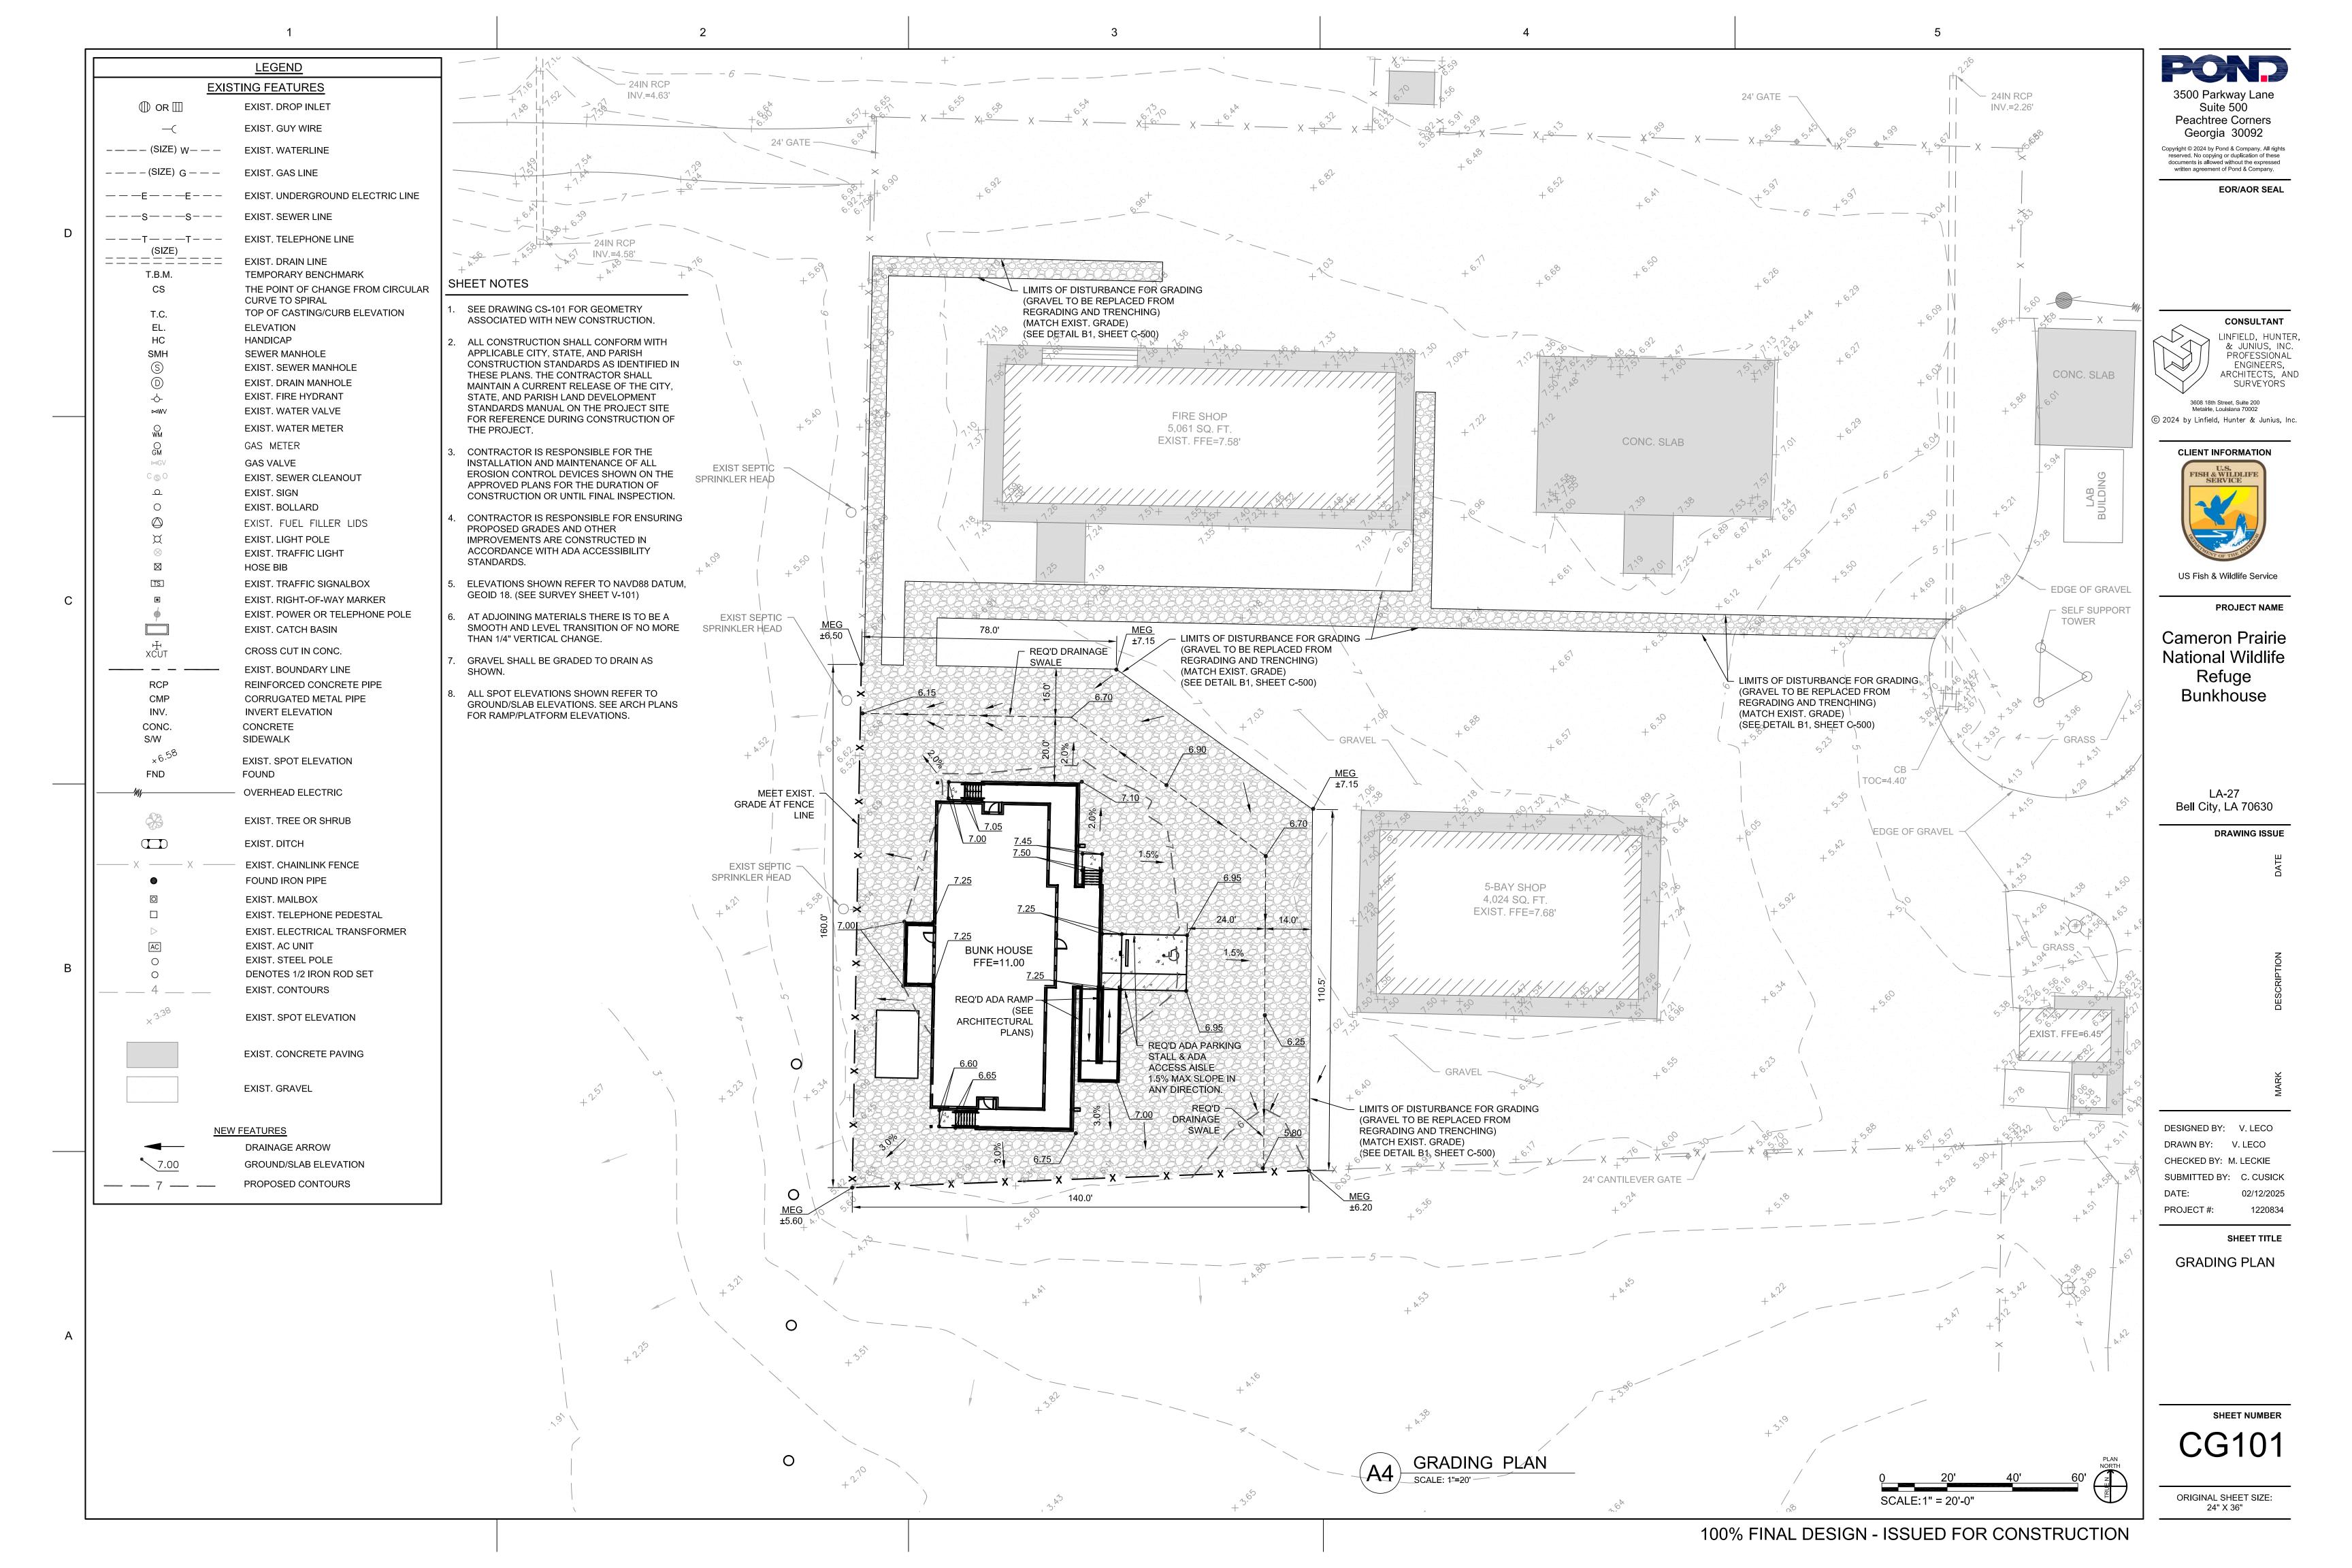

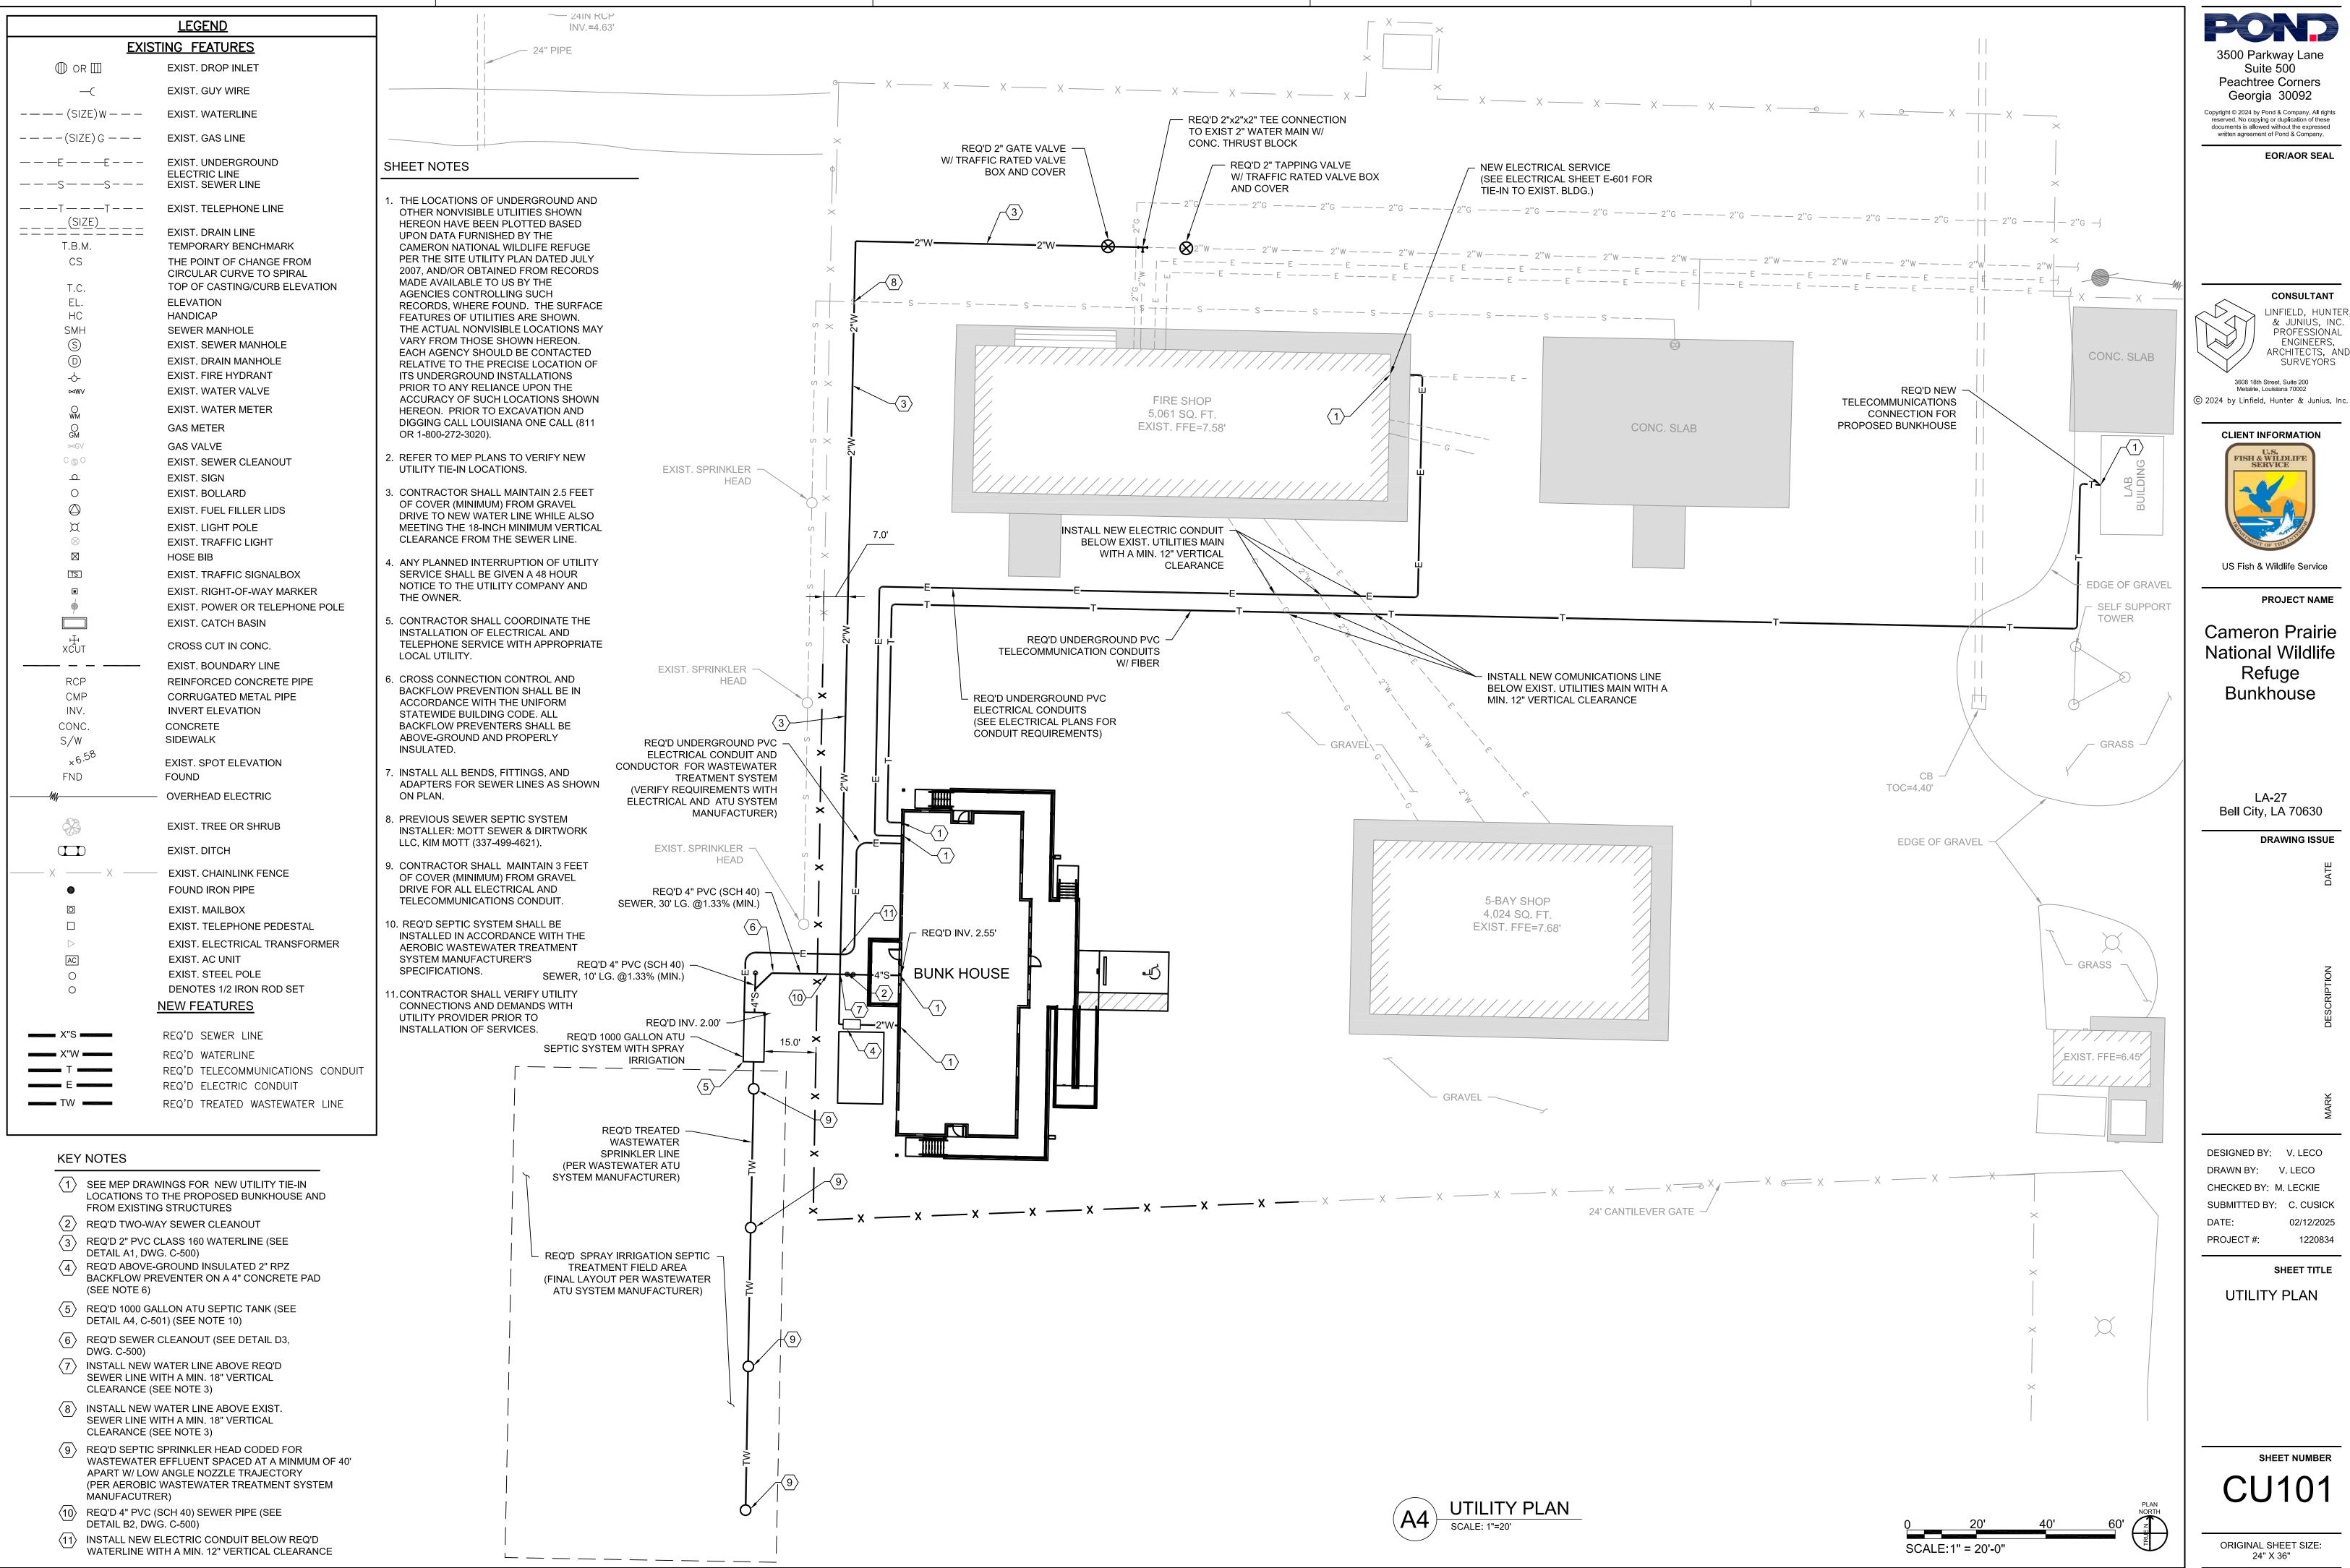

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3608 18th Street, Suite 200

**CLIENT INFORMATION** U.S. FISH & WILDLIFI SERVICE

US Fish & Wildlife Service

PROJECT NAME

Cameron Prairie National Wildlife Refuge Bunkhouse


Bell City, LA 70630

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DESIGNED BY: V. LECO DRAWN BY: V. LECO CHECKED BY: M. LECKIE SUBMITTED BY: C. CUSICK 02/12/2025 1220834

SHEET TITLE

UTILITY PLAN

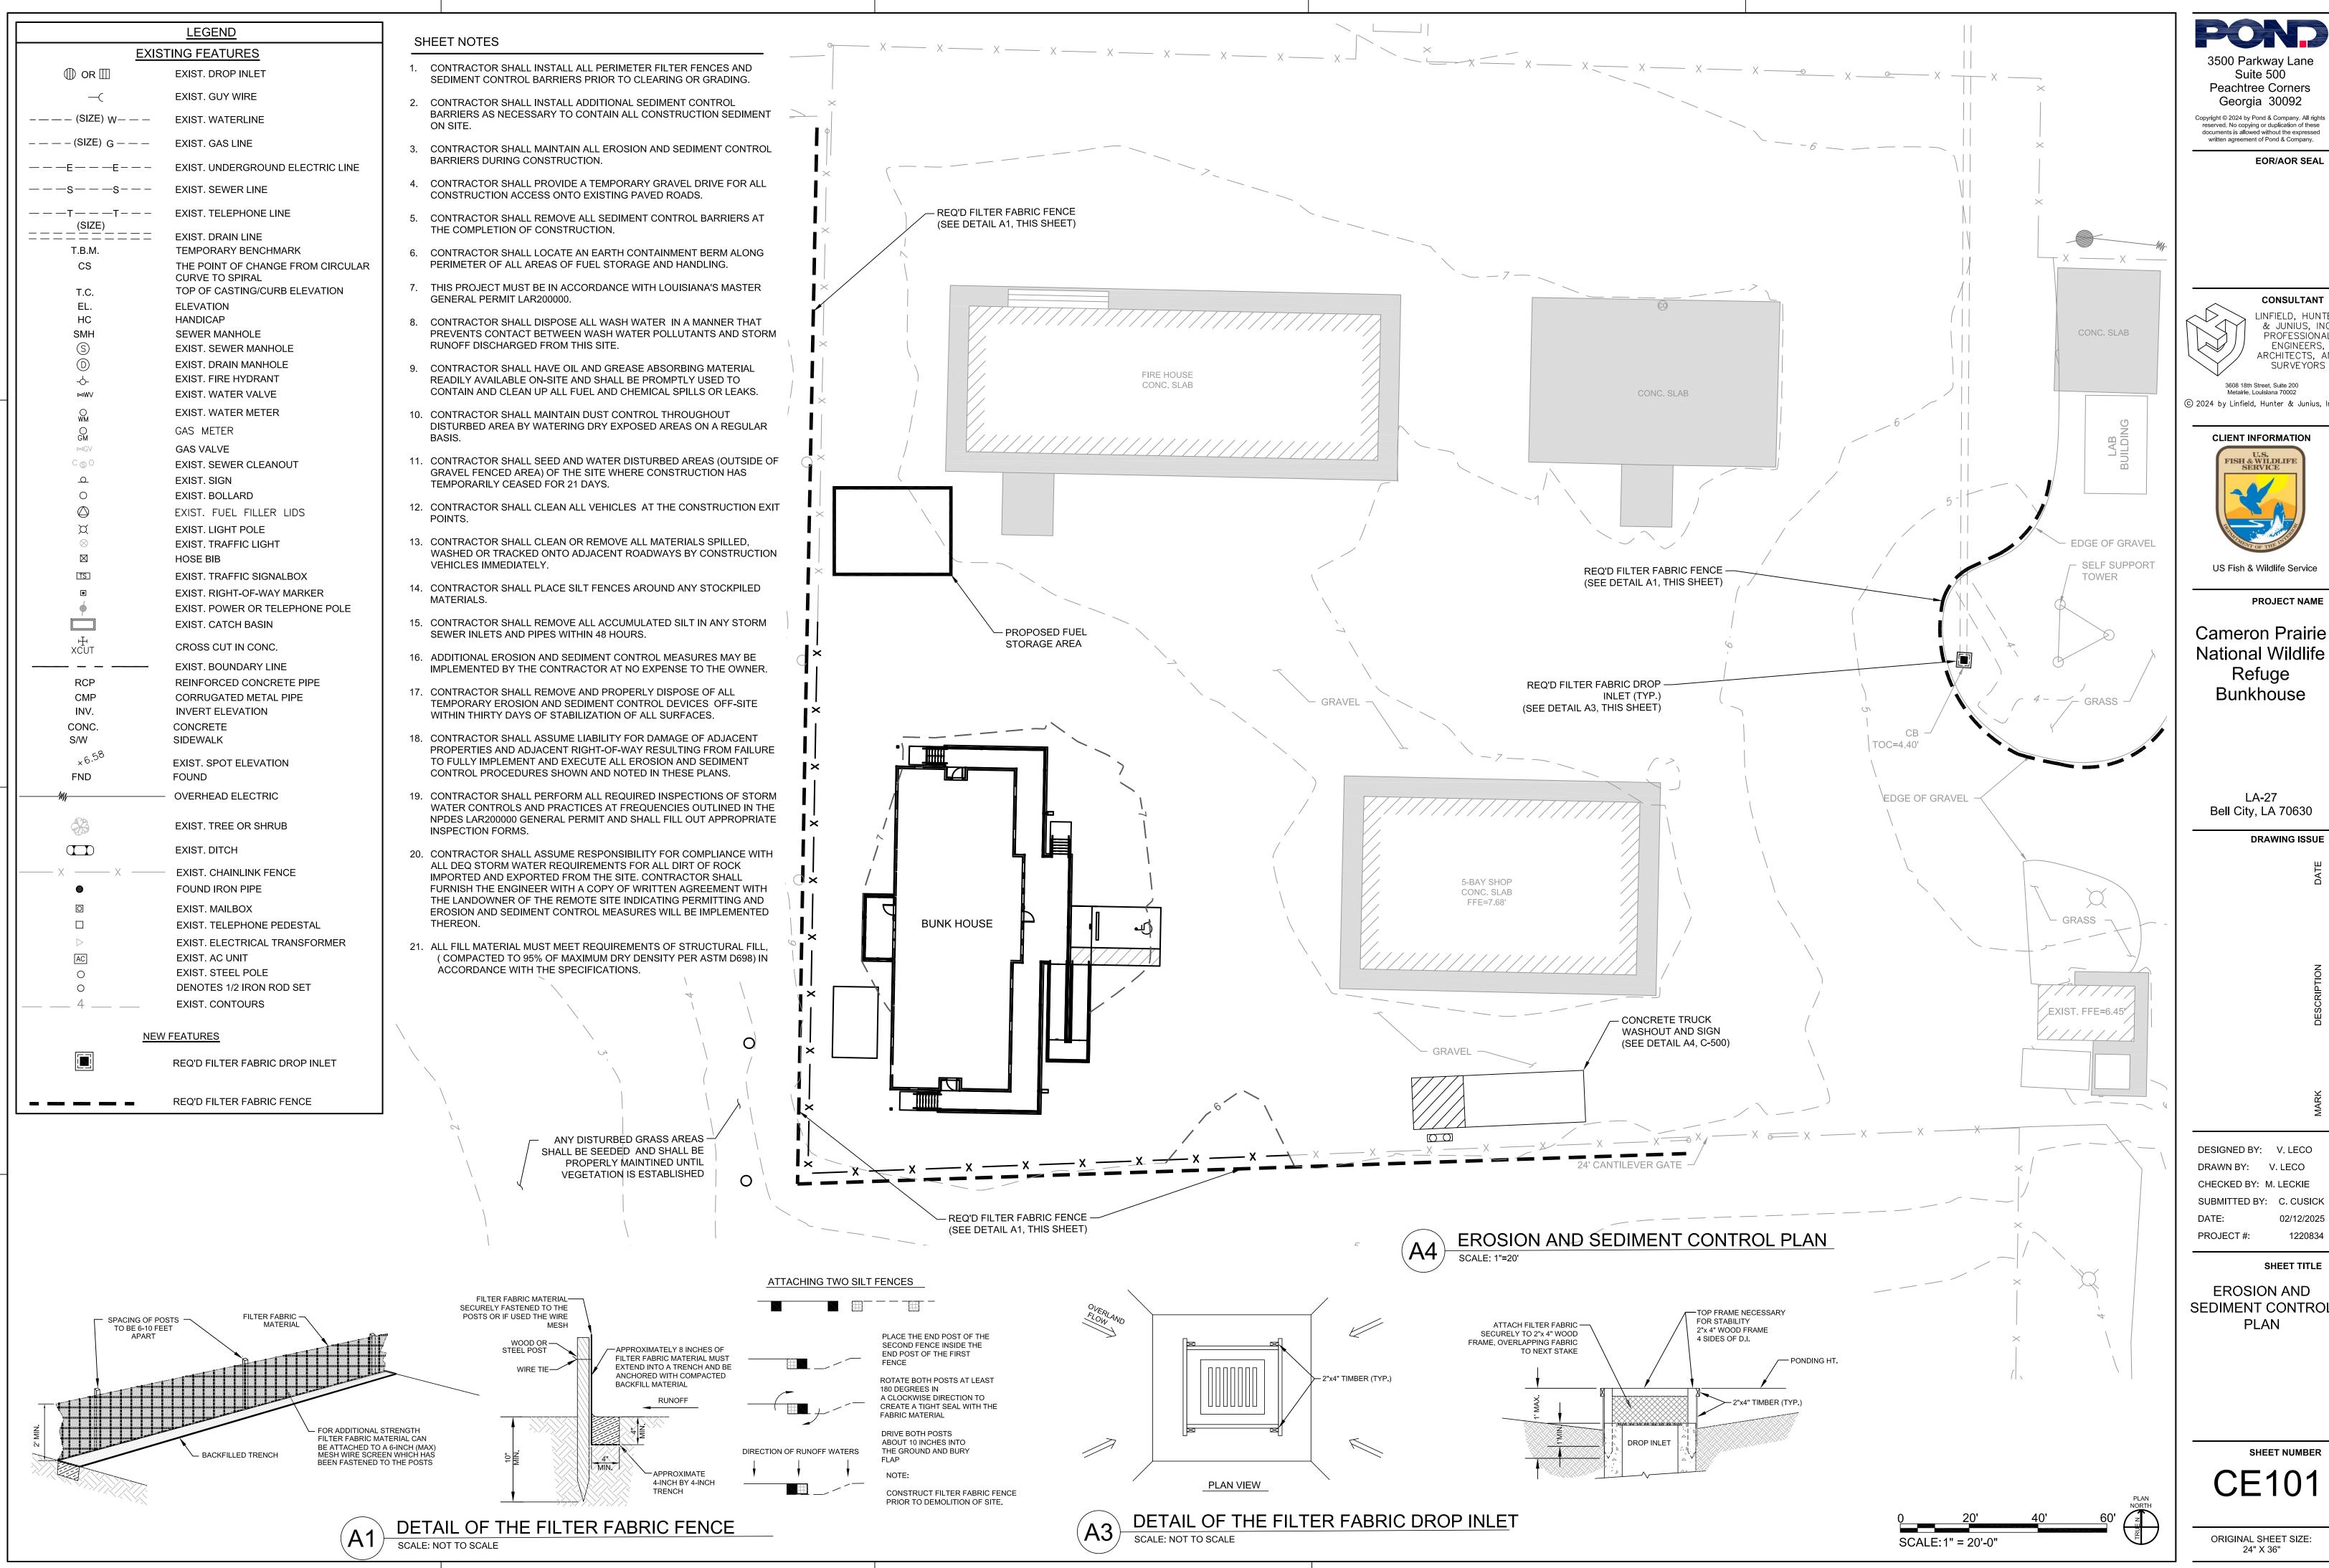

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LA-27

Refuge


DRAWING ISSUE

DESIGNED BY: V. LECO DRAWN BY: V. LECO CHECKED BY: M. LECKIE SUBMITTED BY: C. CUSICK 02/12/2025 PROJECT #: 1220834

SHEET TITLE

**EROSION AND** SEDIMENT CONTROL PLAN

> SHEET NUMBER **CE101**

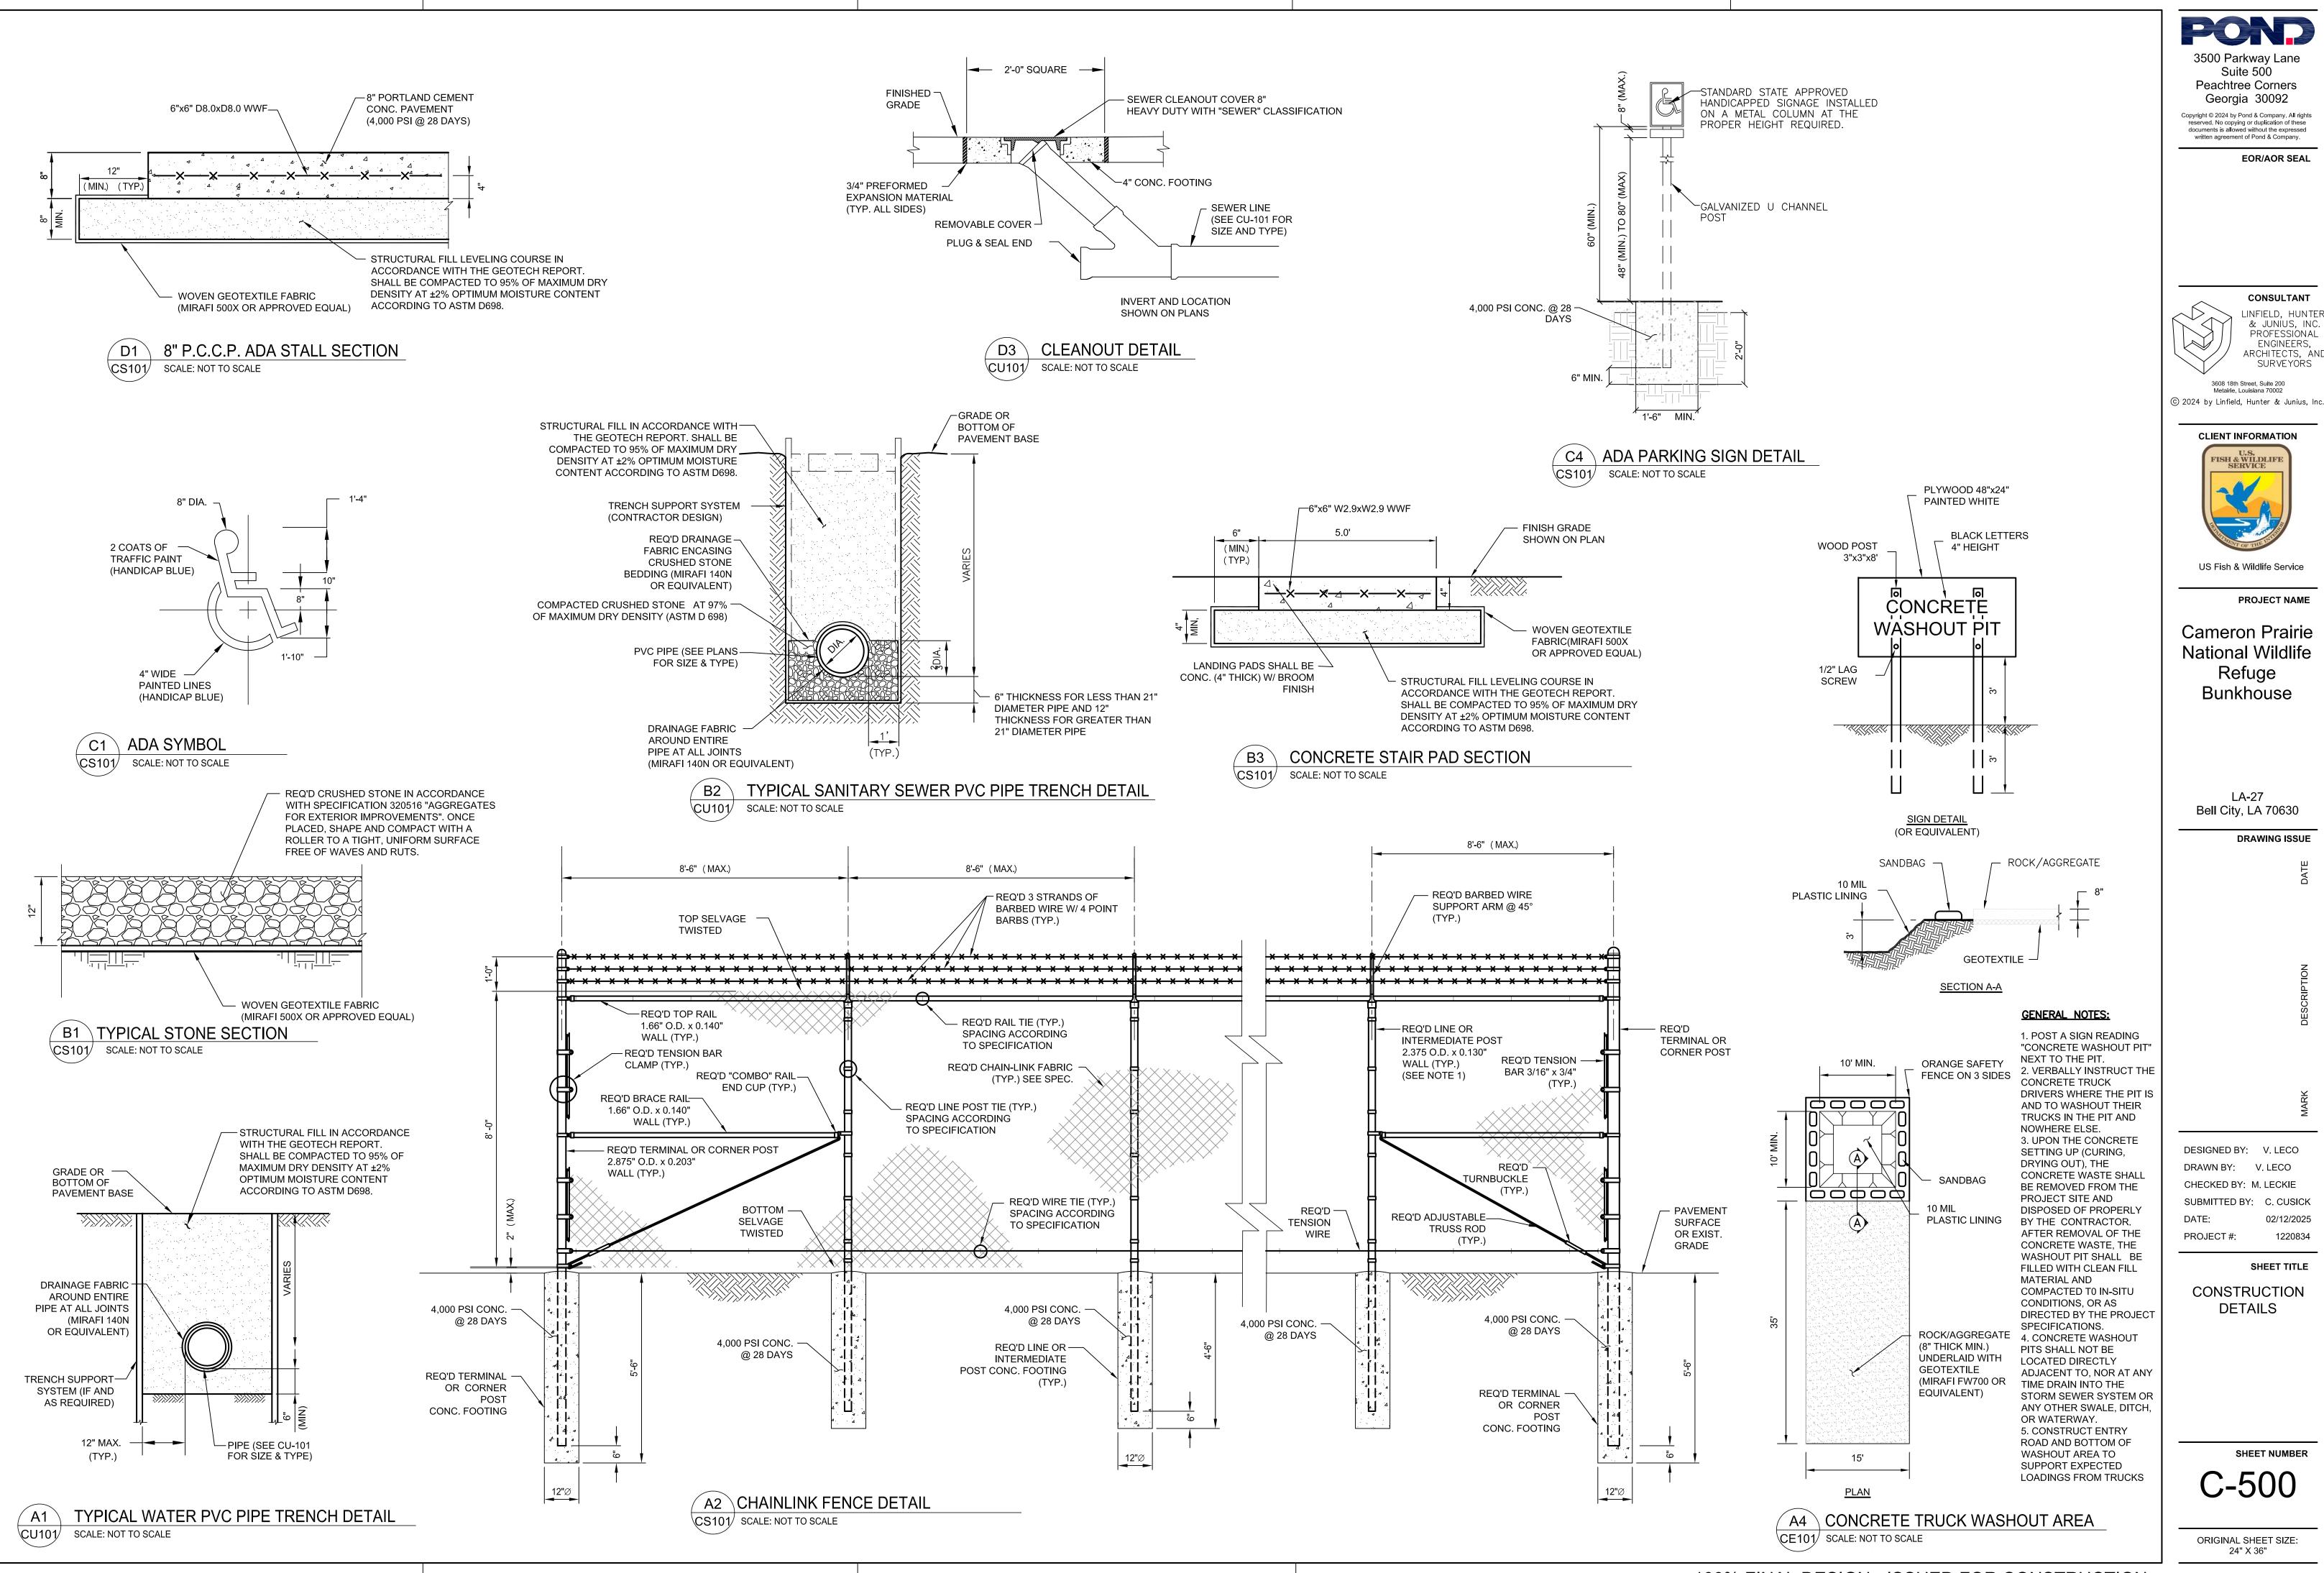

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3608 18th Street, Suite 200 Metairie, Louisiana 70002

CLIENT INFORMATION U.S. FISH & WILDLIFI SERVICE

US Fish & Wildlife Service

PROJECT NAME

Cameron Prairie National Wildlife Refuge Bunkhouse

> LA-27 Bell City, LA 70630

**DRAWING ISSUE** 


DESIGNED BY: V. LECO DRAWN BY: V. LECO CHECKED BY: M. LECKIE SUBMITTED BY: C. CUSICK 02/12/2025

SHEET TITLE

1220834

CONSTRUCTION DETAILS

SHEET NUMBER C-500

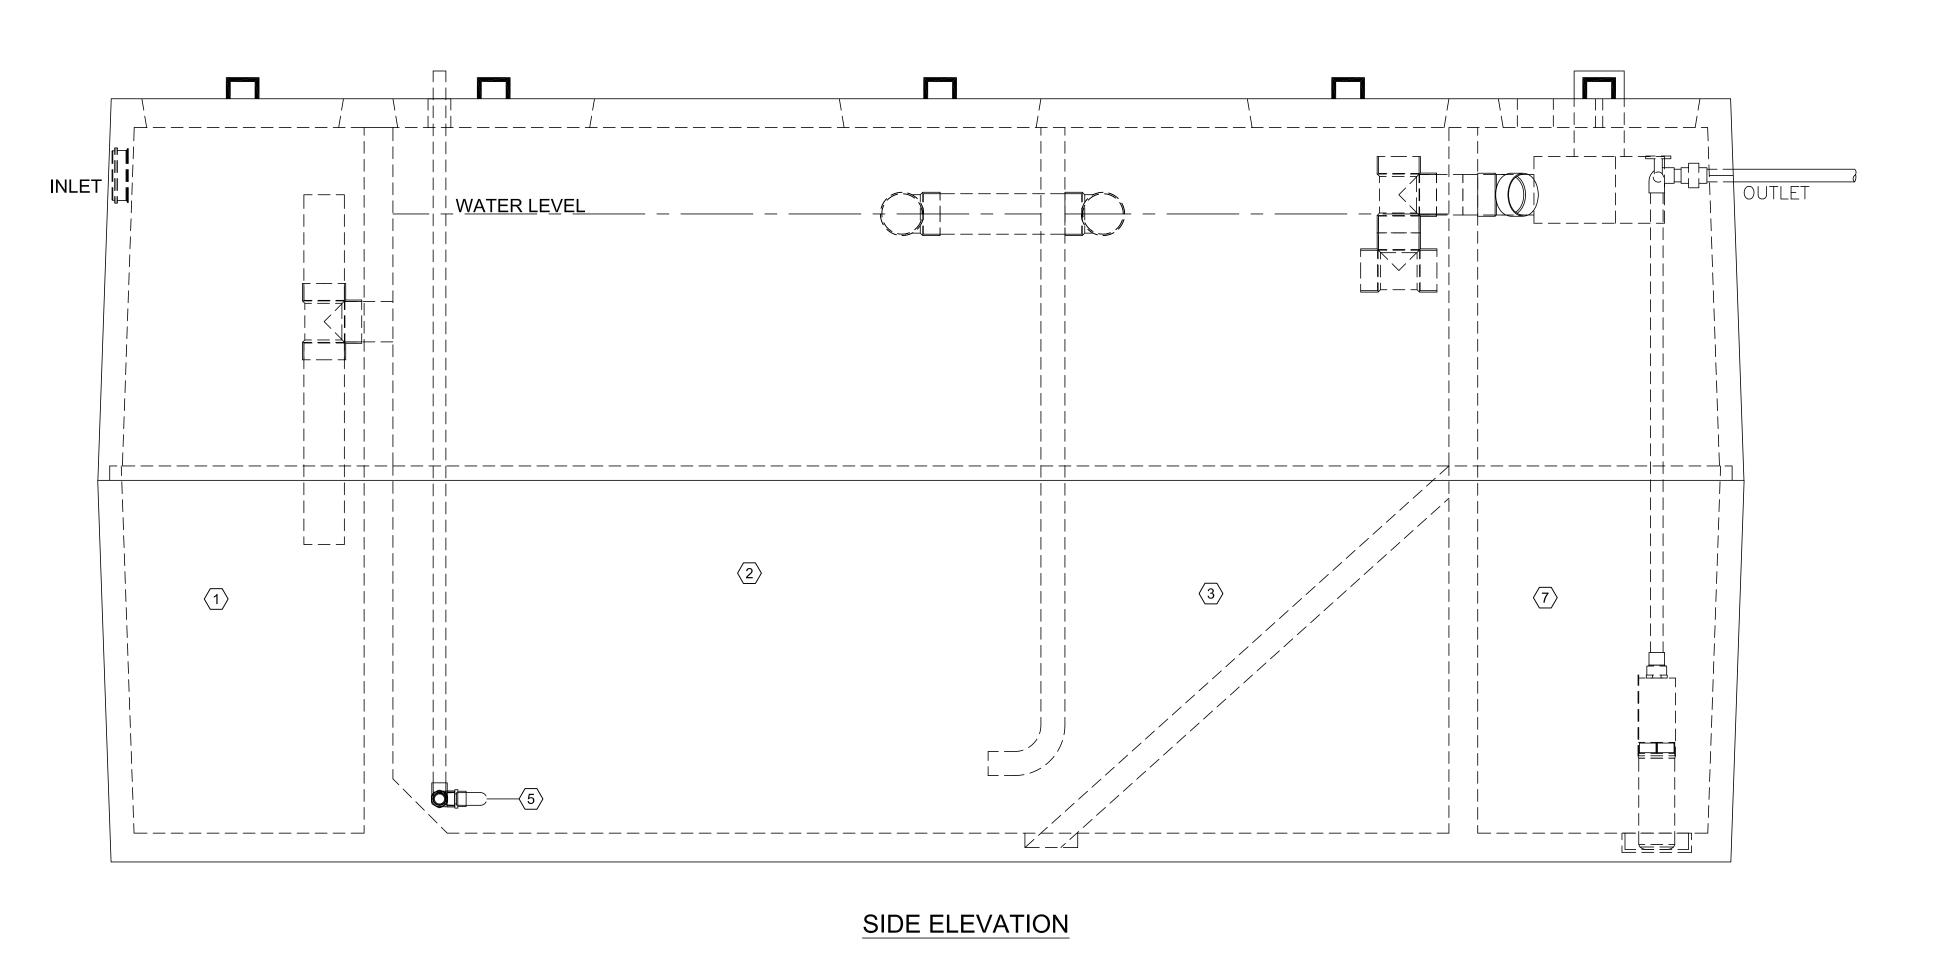


\*OPTIONAL SKIMMER

**PLAN VIEW** 

DIFFUSER

ACCESS

LIDS

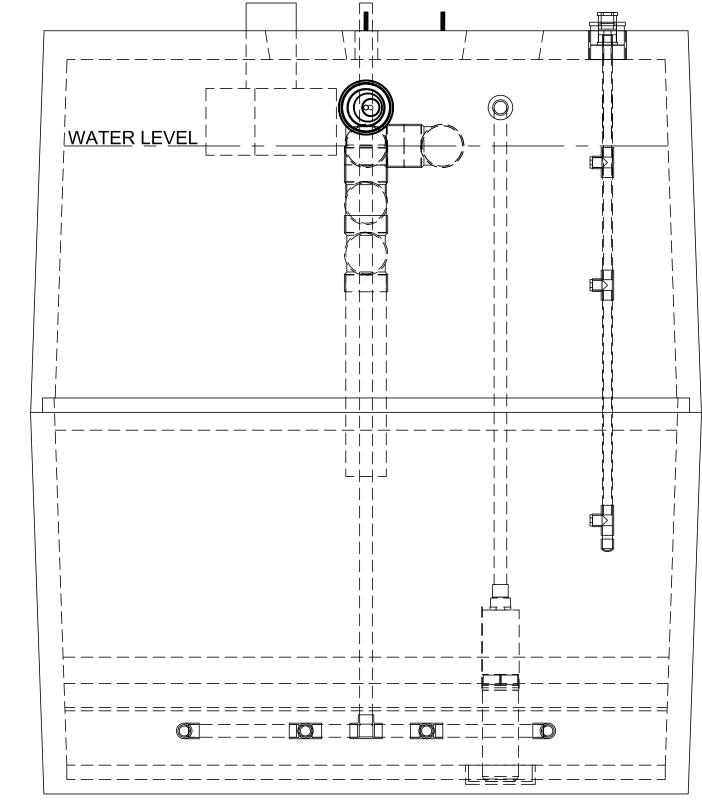

### FRONT ELEVATION

### **KEY NOTES**

- PRETREATMENT TANK WHERE ANAEROBIC DIGESTION OCCURS AND STORAGE FOR NON-BIODEGRADEABLE MATERIALS.
- AERATION CHAMBER WHERE AIR IS INTRODUCED INTO SEWAGE FOR
- CLARIFIER A STILL CHAMBER WHERE SOLIDS SETTLE OUT AND THE CLEAR EFFLUENT RISES.
- AIR LINEAR AIR BLOWER LONG LIFE, EFFICIENT LINEAR BLOWER WHICH COMPRESSED ATMOSPHERIC AIR AND UNDER PRESSURE DELIVERS IT TO THE TANK. MAY BE REMOTELY MOUNTED UP TO 50' FROM SYSTEM. MUST MAINTAIN 1/8" SLOPE TOWARDS TANK FOR DRAINAGE.
- DIFFUSER BAR FORCES AIR INTO THE WATER
- AERATION LINE DELIVERS THE AIR FROM THE PUMP TO THE MANIFOLD. INCLUDING CHECK VALVE.
- PUMP CHAMBER CHAMBER TO HOUSE A PUMP TO ACTIVELY MOVE WASTEWATER

NOTE: PACKAGE WASTEWATER TREATMENT SYSTEM SHOWN IS SCHEMATIC AND INTENDED TO CONVEY GENERAL MINIMUM REQUIREMENTS, INFORMATION AND ARRANGEMENT. ACTUAL SYSTEM PROVIDED MAY DIFFER BUT SHALL HAVE A MINIMUM TREATMENT CAPACITY OF 1000 GALLONS PER DAY AND SHALL MEET ALL REQUIREMENTS OF PART XIII OF THE LOUISIANA SANITARY CODE AS APPLICABLE FOR PACKAGED WASTEWATER TREATMENT SYSTEMS. SYSTEM SHALL BE INSTALLED PER THE MANUFACTURER'S SPECIFICATIONS.

ALARM


CHLOR.

/STANDARD

ACCESS

LIDS

SKIMMER

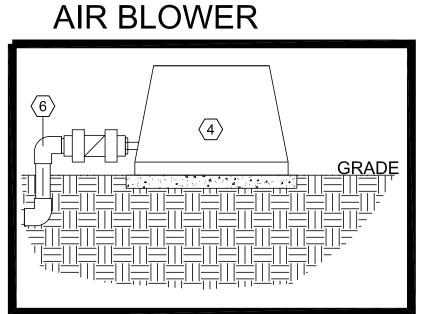

PACKAGED WASTEWATER TREATMENT SYSTEM

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**EOR/AOR SEAL** 

CONSULTANT LINFIELD, HUNTER, & JUNIUS, INC. PROFESSIONAL ENGINEERS, ARCHITECTS, AND SURVEYORS

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US Fish & Wildlife Service

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> LA-27 Bell City, LA 70630

> > DRAWING ISSUE

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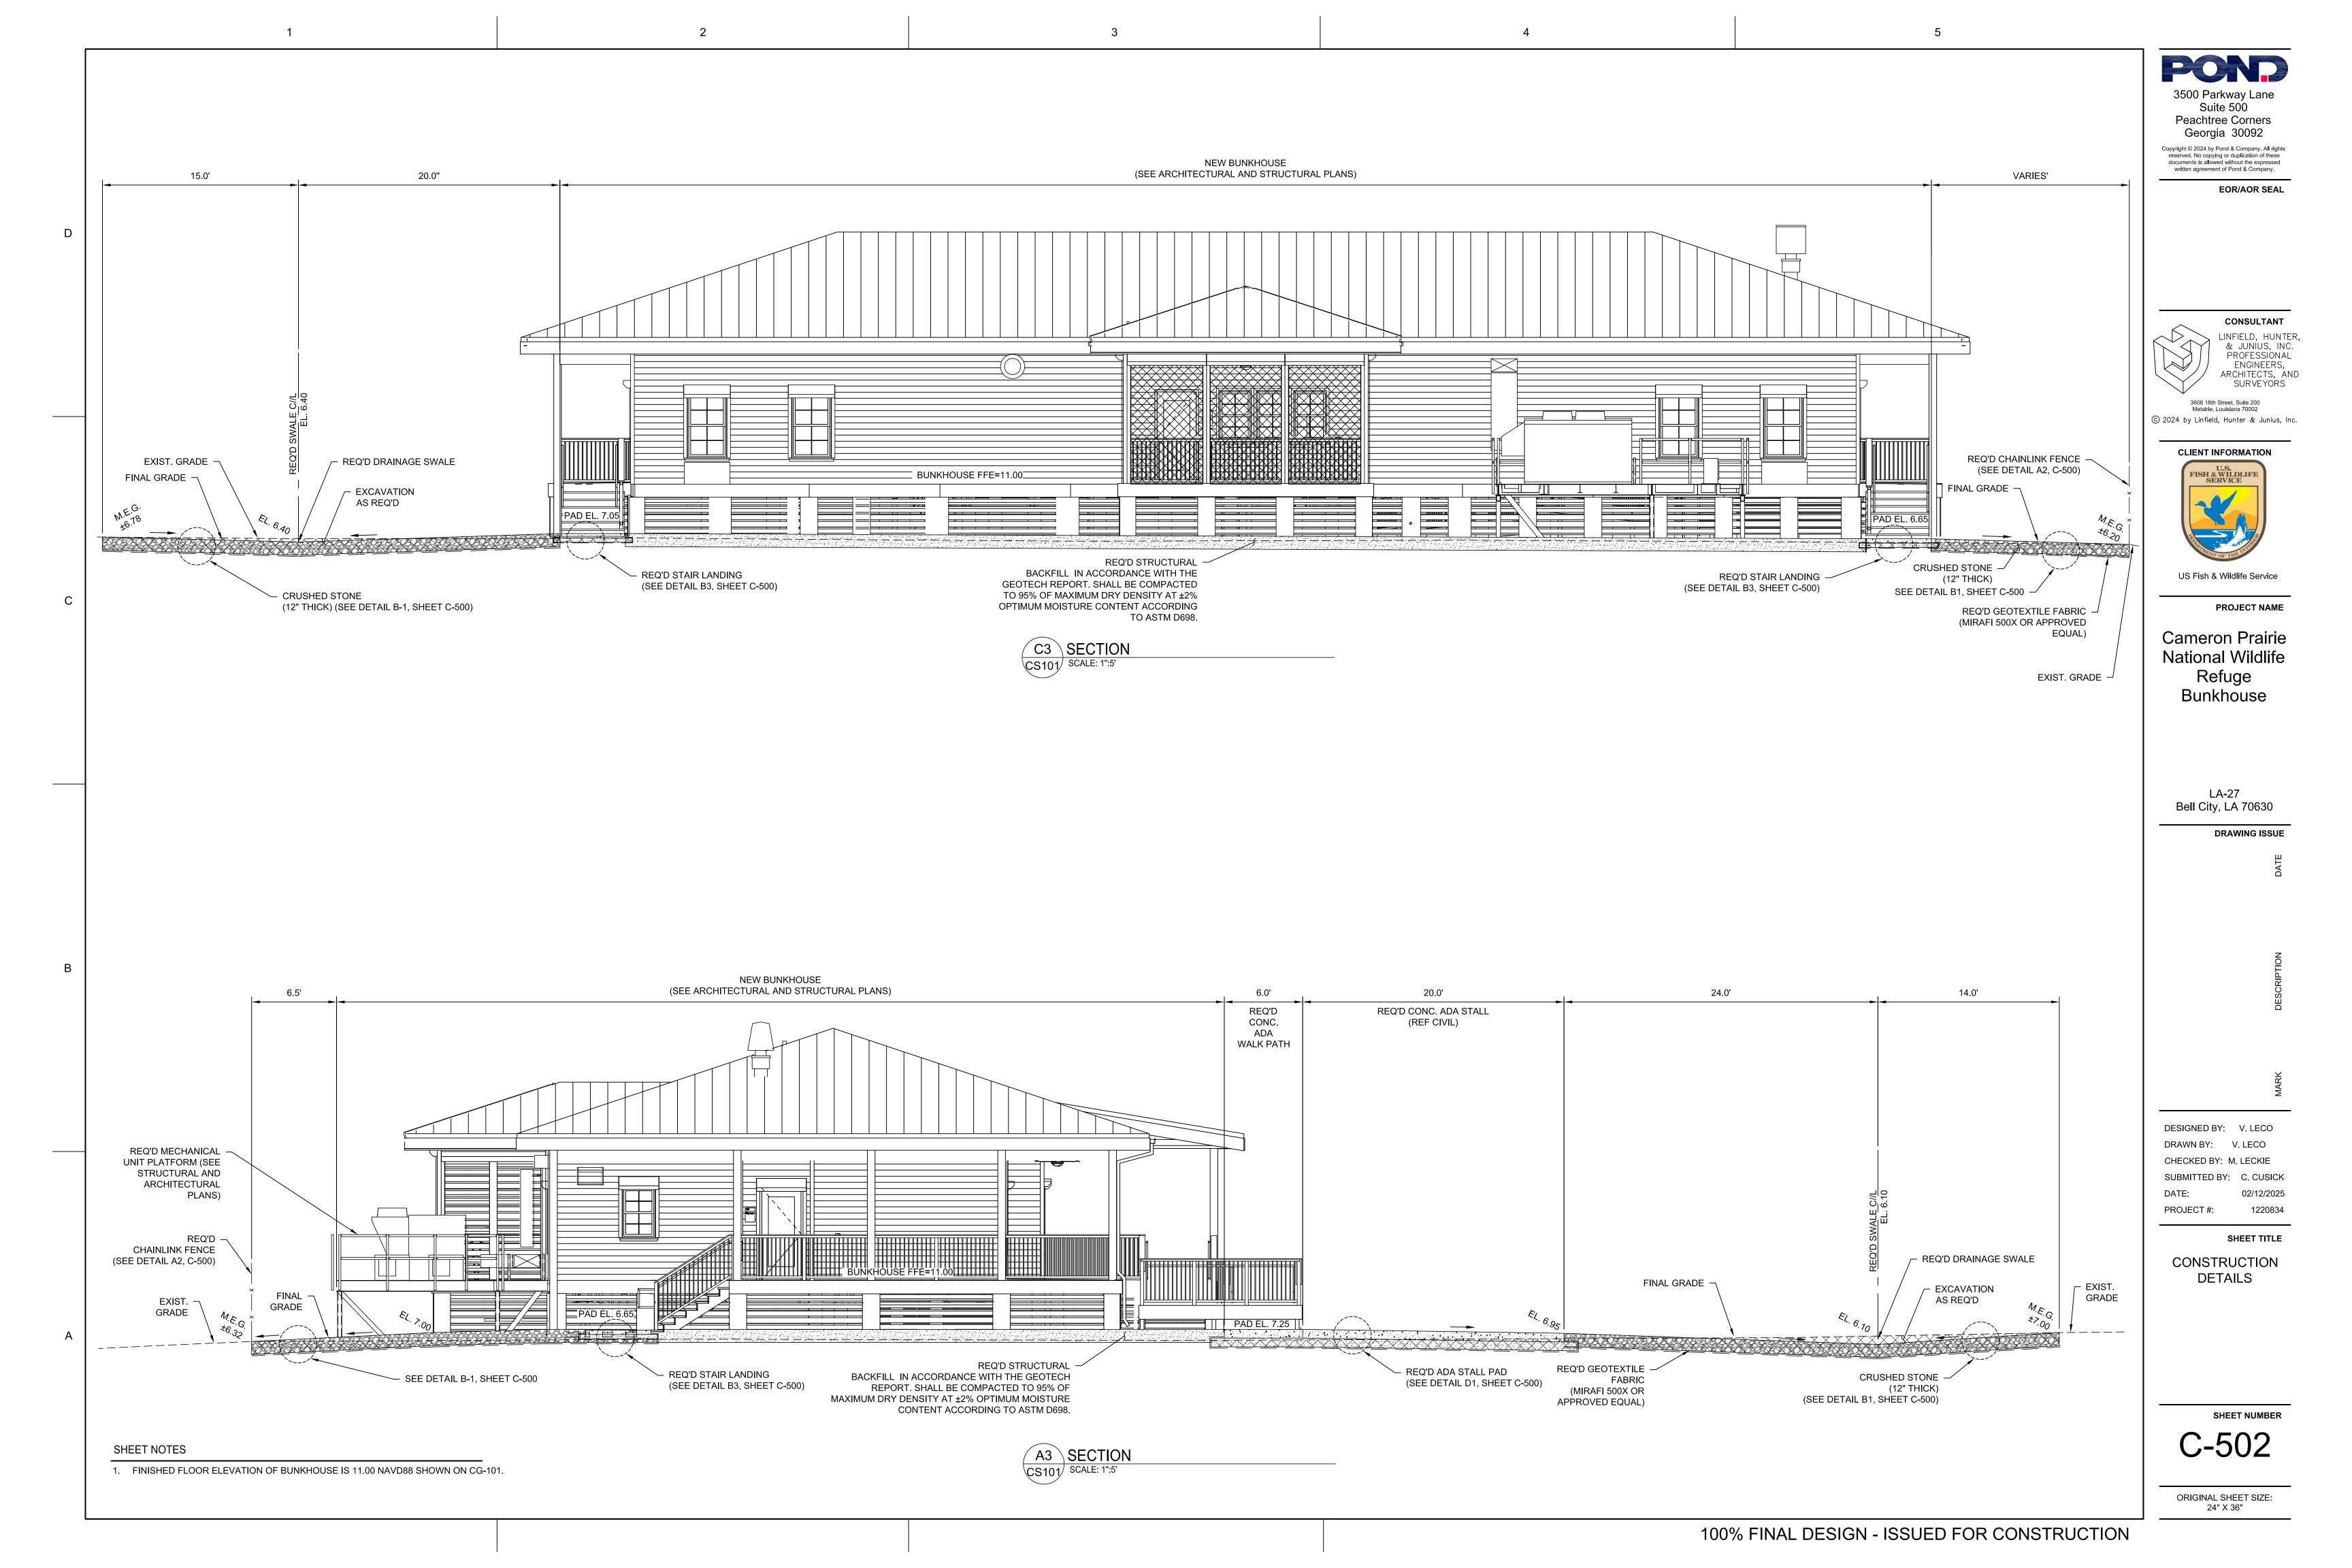
02/12/2025

SHEET TITLE CONSTRUCTION DETAILS

SHEET NUMBER

ORIGINAL SHEET SIZE: 24" X 36"

100% FINAL DESIGN - ISSUED FOR CONSTRUCTION



### GENERAL STRUCTURAL NOTES:

### A. <u>GENERAL</u>

- 1. THE CONTRACTOR SHALL REVIEW ALL SUBMITTALS BEFORE THEY ARE PROVIDED TO THE OWNER AND STRUCTURAL ENGINEER. THE CONTRACTOR'S REVIEW SHALL BE DOCUMENTED WITHIN THE SUBMITTAL. THE OWNER AND STRUCTURAL ENGINEER RESERVE THE RIGHT TO REJECT SUBMITTALS THAT HAVE NOT BEEN FIRST REVIEWED BY THE CONTRACTOR. THE ACCURACY AND COMPLETENESS OF THE SUBMITTALS IS THE SOLE RESPONSIBILITY OF THE CONTRACTOR, INCLUDING ALL ERRORS AND OMISSIONS. IN ADDITION, THE CONTRACTOR IS SOLELY RESPONSIBLE FOR ALL MEANS, METHODS, AND SEQUENCING OF CONSTRUCTION.
- 2. THE GENERAL CONTRACTOR AND ALL SUBCONTRACTORS SHALL BE EXPERIENCED AND QUALIFIED TO PERFORM THE TYPE OF CONSTRUCTION REQUIRED TO COMPLETE THE WORK PRESCRIBED BY THE CONTRACT DOCUMENTS. THE CONTRACT DOCUMENTS WERE PREPARED AS A COMPLETE SET OF PROJECT DRAWINGS AND SPECIFICATIONS. IT IS THE GENERAL CONTRACTOR'S RESPONSIBILITY TO COORDINATE ALL INFORMATION PROVIDED IN THE CIVIL, ARCHITECTURAL, INTERIOR, MECHANICAL, ELECTRICAL, PLUMBING, AND FIRE PROTECTION DRAWINGS AND SPECIFICATIONS. THE CONTRACTOR SHALL NOTIFY THE OWNER AND ARCHITECT/ENGINEER IMMEDIATELY OF ANY CONFLICTS, OMISSIONS, OR DISCREPANCIES. THIS COORDINATION SHALL BE PERFORMED BEFORE THE PROCUREMENT OF MATERIALS AND/OR FABRICATION OF ANY PROJECT COMPONENTS.
- 3. WHERE SECTION IS SHOWN AND DETAILED, OTHER SECTIONS OF SIMILAR CONDITION SHALL BE DETAILED THE SAME OR OPPOSITE HAND, WHETHER SPECIFICALLY NOTED OR NOT.
- 4. CONTRACTOR SHALL VERIFY EXISTING DIMENSIONS, ELEVATIONS, AND SITE CONDITIONS BEFORE BEGINNING CONSTRUCTION. NOTIFY ENGINEER OF RECORD OF ANY DISCREPANCIES.
- 5. COORDINATE SIZES AND LOCATIONS OF ALL FLOOR AND ROOF PENETRATIONS WITH PLUMBING, MECHANICAL, AND ARCHITECTURAL REQUIREMENTS.
- 6. ENGINEER'S APPROVAL MUST BE SECURED FOR ALL SUBSTITUTIONS. SUCH APPROVAL MAY ALSO BE WITHHELD AT THE SOLE DISCRETION OF THE ENGINEER.
- 7. THE STRUCTURES HAVE BEEN DESIGNED IN ACCORDANCE WITH THE PROVISIONS OF THE FOLLOWING:
  - a. LOUISIANA STATE UNIFORM CONSTRUCTION CODE (ADOPTED JAN. 1, 2023)
  - b. INTERNATIONAL BUILDING CODE, 2021 EDITION (IBC 2021).
  - c. AMERICAN SOCIETY OF CIVIL ENGINEERS, "MINIMUM DESIGN LOADS FOR BUILDINGS AND OTHER STRUCTURES," 2016 EDITION (ASCE 7-16).
  - d. ASCE 24-14 FLOOD RESISTANT DESIGN AND CONSTRUCTION
- 8. THE CONTRACTOR SHALL PROVIDE TEMPORARY SHORING AND BRACING REQUIRED TO ERECT AND HOLD THE STRUCTURE IN PROPER ALIGNMENT UNTIL PERMANENT SUPPORTS AND LATERAL BRACING ARE IN PLACE.
- 9. DO NOT SCALE DRAWINGS, USE DIMENSIONS.
- 10. DESIGN LOADS USED IN THE DESIGN OF THE STRUCTURAL SYSTEMS IN THIS PROJECT ARE AS FOLLOWS:

0 psf

RISK CATEGORY	
	RISK CATEGORY

b. DEAD LOAD:

ROOF (NOT INCLUDING FRAMING SELF WT.) 20 ps

c. <u>LIVE LOAD:</u>

ROOF 20 psf (REDUCIBLE)
PRIVATE ROOMS 40 psf
PUBLIC ROOMS AND CORRIDORS 100 psf

ATTIC 60 psf STAIRS 100 psf

d. ROOF SNOW LOAD:

GROUND SNOW LOAD,  $p_g$ 

e. <u>WIND DESIGN CRITERIA:</u> EXPOSURE CATEGORY

BASIC WIND SPEED, V 137 mph (FACTORED, ULTIMATE LOAD) 106 MPH (UNFACTORED, SERVICE LOAD)

INTERNAL PRESSURE COEFFICIENT,  $GC_p$  ± 0.18

WIND-BORNE DEBRIS REGION NO (> 1mi FROM COAST)

### SEISMIC DESIGN CRITERIA:

 $S_{D1}$  (LONG PERIOD (1.0 SECOND)) 0.081 g SITE CLASS CLASS D

SEISMIC DESIGN CATEGORY

LATERAL FORCE RESISTING SYSTEM

LIGHT FRAME WALLS WITH SHEAR PANELS AND STEEL

ROD BRACING BETWEEN PILES (STEEL NOT SPECIFICALLY

DETAILED FOR SEISMIC RESISTANCE)

IMPORTANCE FACTOR, Ie

RESPONSE MODIFICATION COEFFICIENT, R 3 SEISMIC RESPONSE COEFFICIENT,  $C_s$  0.029

ANALYSIS PROCEDURE: EQUIVALENT LATERAL FORCE SEISMIC BASE SHEAR, V 12.0 K

g. <u>FLOOD DESIGN CRITERIA</u>:

FLOOD ZONE AE
BASE FLOOD ELEVATION (BFE) 9ft
ELEVATION OF THE LOWEST FLOOR 11ft

h. RAIN LOAD

RAIN INTENSITY (1 HR, 100 YR) 4.81 IN/HR

11. ALL VERTICAL ELEVATIONS ARE BASED ON THE CONTROL ELEVATION FROM SURVEY BY OTHERS.

### B. **FOUNDATION**

- FOUNDATIONS FOR THIS STRUCTURE HAVE BEEN DESIGNED IN ACCORDANCE WITH THE RECOMMENDATIONS IN THE GEOTECHNICAL ENGINEERING REPORT, PREPARED BY ARDAMAN & ASSOCIATES DATED APRIL. 19, 2023, AND ENTITLED "REPORT ADDENDUMN #1, PROPOSED BUNKHOUSE, EDUCATION BUILDING, AND POLE BARN AT CAMERON PRAIRIE NWR" (COMPANY # 23-84-2806).
- 2. FOUNDATIONS AND EARTH RETAINING STRUCTURES HAVE BEEN DESIGNED FOR A MAXIMUM ALLOWABLE SOIL BEARING PRESSURE OF 2000 psf.
- 3. REFER TO THE GEOTECHNICAL REPORT AND SPECIFICATION SECTION 31 20 00 FOR REQUIREMENTS FOR REMOVAL OF UNSATISFACTORY MATERIAL UNDER FOOTINGS, SLABS, AND FOUNDATIONS AND FOR THE BACKFILLING, COMPACTION, AND TESTING OF SATISFACTORY MATERIAL TO REPLACE IT. REFER TO GEOTECHNICAL REPORT FOR ALL ADDITIONAL PREPARATION REQUIREMENTS. WHERE THERE IS A CONFLICT, THE MORE STRINGENT REQUIREMENT SHALL APPLY BETWEEN THE SPECIFICATION AND THE GEOTECHNICAL REPORT.
- 4. PRIOR TO PLACING FOUNDATION CONCRETE, AND AFTER COMPACTION OF SUBGRADE, ALL FOUNDATION EXCAVATIONS SHALL BE INSPECTED AND TESTED BY A QUALIFIED GEOTECHNICAL TECHNICIAN. TESTING SHALL INCLUDE IN PLACE DENSITY TESTING, WHICH WILL REQUIRE ESTABLISHING THE OPTIMUM MOISTURE CONTENT OF THE SUBGRADE. IF THE SUBGRADE HAS LESS THAN THE STATED ALLOWABLE BEARING CAPACITY (SEE NOTE 2 ABOVE) THE WEAK SUBGRADE SHALL BE REMOVED, RECOMPACTED, AND RETESTED UNTIL IT IS SATISFACTORY AT NO ADDITIONAL COST TO THE OWNER. CONCRETE PLACEMENT SHALL NOT PROCEED UNTIL THE SUBGRADE MEETS THE MINIMUM DENSITY REQUIREMENTS OF SPECIFICATION SECTION 31 20 00 AND THE GEOTECHNICAL REPORT. WHICHEVER IS MORE STRINGENT.
- 5. NO UNBALANCED BACKFILLING SHALL BE DONE AGAINST CONCRETE OR MASONRY WALLS UNLESS WALLS ARE SECURELY BRACED AGAINST OVERTURNING, EITHER BY TEMPORARY CONSTRUCTION BRACING OR BY PERMANENT CONSTRUCTION.
- 6. WATER SHALL NOT BE ALLOWED TO ACCUMULATE IN EXCAVATIONS.

### C. CAST-IN-PLACE CONCRETE

- 1. CAST-IN-PLACE CONCRETE FOR THIS PROJECT SHALL COMPLY WITH THE AMERICAN CONCRETE INSTITUTE (ACI) "BUILDING CODE REQUIREMENTS FOR REINFORCED CONCRETE AND COMMENTARY" ACI 318-19 AND ACI 318R-19.
- CONCRETE SHALL HAVE LOW PERMEABILITY. REFERENCE PROJECT SPECIFICATION SECTION 03 30 00 "CAST-IN-PLACE CONCRETE."
- 3. CONCRETE SHALL HAVE THE FOLLOWING PROPERTIES:

AREA	f'c (28 DAYS)	AIR CONTENT	MAX. W/C RATIO	MAX. SLUMP
FOUNDATIONS, PEDESTALS, AND SLABS-ON-GRADE	4,000 psi	< 3%	0.45	4" ± 1"

- 4. ALL EXPOSED CONCRETE EDGES SHALL HAVE 3/4" CHAMFER, WHETHER SPECIFICALLY NOTED OR NOT.
- 5. TYPICAL SLAB FINISH SHALL BE BROOM FINISH FOR EXTERIOR SLABS AND INTERIOR WET SLABS AND STEEL TROWEL FINISH FOR INTERIOR DRY SLABS.
- A. ALL ANCHOR RODS SHALL BE BLACK STEEL. (EXTERIOR ANCHOR BOLTS SHALL BE HOT-DIPPED GALVANIZED.)
- 6. CONCRETE FORMWORK SHALL COMPLY WITH ACI 347, LATEST EDITION. CONTRACTOR SHALL BE RESPONSIBLE FOR THE DESIGN OF ALL FORMWORK.
- 7. DURING AND IMMEDIATELY AFTER PLACING, CONCRETE SHALL BE THOROUGHLY COMPACTED BY SPADING OR MECHANICAL VIBRATING TO PROVIDE DENSE CONCRETE FREE OF HONEYCOMBING.
- DIRECTLY AFTER FORMS HAVE BEEN REMOVED, ALL EXPOSED TIE WIRES AND STAPLED ENDS SHALL BE REMOVED FROM CONCRETE SURFACES TO BE EXPOSED. CUT TIES FLUSH WITH FINISHED SURFACES FOR ALL OTHER CONCRETE. RUB SMOOTH OR CUT OFF FINS AND ROUGH PLACES. REMOVE ALL LOOSE CONCRETE AND OTHER IRREGULARITIES. PATCH AND FILL VOIDS WITH BONDING AGENT AS REQUIRED.
- 9. ROUGHEN ALL CONSTRUCTION JOINTS TO A MINIMUM OF 1/4" AMPLITUDE UNLESS NOTED OTHERWISE.
- 10. USE WATERPROOFING HYDROPHILIC ADMIXTURE IN CONCRETE FOR SUMP PITS.
- 11. LIMIT FLYASH CONTENT TO 20% MAX (BY MASS)
- 12. MAXIMUM COARSE AGGREGATE SIZE SHALL BE 3/4 INCH.

### D. TIMBER PILES:

- 1. TIMBER PILES SHALL BE PRESSURE TREATED CONFORMING TO AMERICAN WOOD PRESERVERS ASSOCIATION AWPA C3.
- 2. PILES SHALL BE CLASS "B" SOUTHERN PINE WITH MINIMUM COMPRESSIVE STRENGTH PARALLEL TO GRAIN OF 1250 psi CONFORMING TO ASTM D25 LATEST EDITION AND NATIONAL FOREST PRODUCTS ASSOCIATION "NATIONAL DESIGN SPECIFICATIONS".
- 3. PILES SHALL BE CLEAN PEELED, ONE-PIECE MINIMUM BUTT 12" AND MINIMUM TIP 7". PILE SHOES SHALL CONFORM TO FEDERAL SPECIFICATIONS RR-S-33L.
- 4. PILE TIP SHALL BE MINIMUM 40 FEET BELOW GROUND SURFACE.
- 5. ALLOWABLE COMPRESSION LOAD SHALL BE 22 KIPS; ALLOWABLE TENSION LOAD SHALL BE 22 KIPS; ALLOWABLE LATERAL LOAD SHALL BE 5 KIPS.
- 6. PILES SHALL BE INSTALLED PER THE REFERENCED SOILS REPORT.

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Peachtree Corners Georgia 30092

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CONSULTANT

CLIENT INFORMATION



US Fish & Wildlife Services

PROJECT NAME

Cameron Prairie
National Wildlife
Refuge Bunkhouse

LA-27 Bell City, LA 70630

DRAWING ISSUE

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SHEET TITLE

DESIGNED BY: D. SKULLY
DRAWN BY: D.SKULLY
CHECKED BY: W. HAYNES
SUBMITTED BY: C.CUSICK
DATE: 02/12/2025
PROJECT #: 1220834

GENERAL STRUCTURAL

NOTES

S-001

**SHEET NUMBER** 

- REINFORCING STEEL SHALL CONFORM TO ASTM A615 SUPPLEMENT SI, GRADE 60, OF DOMESTIC MANUFACTURER
- REINFORCEMENT SHALL BE FABRICATED TO SHAPES AND DIMENSIONS SHOWN AND SHALL CONFORM TO THE REQUIREMENTS OF CRSI AND ACI 318. REINFORCEMENT SHALL BE COLD BENT UNLESS OTHERWISE AUTHORIZED. BENDING MAY BE ACCOMPLISHED IN THE FIELD OR AT THE MILL. BARS SHALL NOT BE FIELD BENT WITHOUT THE APPROVAL OF THE ENGINEER.
- 3. REINFORCEMENT SHALL BE FREE FROM LOOSE RUST AND SCALE, DIRT, OIL, OR OTHER DELETERIOUS COATING THAT COULD REDUCE BOND WITH THE CONCRETE.
- 4. NO SPLICES OF REINFORCEMENT SHALL BE PERMITTED EXCEPT AS DETAILED OR AUTHORIZED. MAKE BARS CONTINUOUS AROUND CORNERS WITH CORNER BARS. WHERE PERMITTED. SPLICES MADE BY CONTACT LAPS SHALL BE CLASS "B" TENSION LAPS.
- 5. TENSION AND COMPRESSION REINFORCEMENT SPLICE LENGTHS IN CONCRETE SHALL BE DETERMINED AS FOLLOWS:

BAR SIZE	#3	#4	#5	#6	#7	#8	#9	#10	#11
TOP BAR SPLICE SIZE	28"	37"	47"	56"	81"	93"	105"	118"	131"
BOTTOM BAR SPLICE SIZE	22"	29"	36"	43"	63"	72"	81"	91"	101"

- a. TOP BARS ARE HORIZONTAL BARS WITH MORE THAN 12" OF CONCRETE CAST BELOW THE BARS.
- b. THE TABLE ABOVE IS BASED ON A CONCRETE COVER AT LEAST EQUAL TO THE BAR DIAMETER AND A CENTER TO CENTER BAR SPACING AT LEAST EQUAL TO 3 TIMES THE BAR DIAMETER. MULTIPLY THE ABOVE LENGTHS BY 1.5 WHERE THESE CONDITIONS DO NOT EXIST.
- WHERE HOOKS ARE SHOWN, PROVIDE STANDARD 90 DEGREE HOOKS IN ACCORDANCE WITH CRSI AND ACI 318, UNLESS NOTED OTHERWISE.
- WHERE REQUIRED, PROVIDE DOWELS TO MATCH SIZE AND SPACING OF VERTICAL REINFORCING FROM FOUNDATION. DOWELS SHALL HAVE STANDARD 90 DEGREE HOOKS.
- MINIMUM CONCRETE REINFORCING COVER REQUIREMENTS

EXPOSURE	CONST. TYPE	BAR SIZE	MINIMUM COVER
CONCRETE CAST AGAINST EARTH:	ALL	ALL	3"
FORMED CONCRETE EXPOSED TO EARTH OR WEATHER:	WALLS, SLABS	ALL	2"
FORMED CONCRETE NOT EXPOSED TO WEATHER OR IN CONTACT WITH GROUND:	WALLS, SLABS	#11 BAR AND SMALLER	2"

- ALL REINFORCING STEEL AND EMBEDDED ITEMS SUCH AS ANCHOR RODS AND WELD PLATES SHALL BE PLACED TO PREVENT DISPLACEMENT BEYOND PERMITTED TOLERANCES.
- 10. DETAIL BARS IN ACCORDANCE WITH "ACI DETAILING MANUAL-2004," PUBLICATION SP-66, ACI 318, AND ACI 315, OR LATEST EDITIONS.
- 11. PROVIDE ACCESSORIES NECESSARY TO PROPERLY SUPPORT REINFORCING AT POSITIONS SHOWN ON PLANS.
- 12. WELDING OF REINFORCEMENT IS NOT PERMITTED.
- WOOD TRUSSES
- 1. DESIGN, FABRICATE AND INSTALL METAL PLATE CONNECTED WOOD TRUSSES ACCORDING TO THE TRUSS PLATE INSTITUTE STANDARD TPI 1-2014 AND THE NATIONAL DESIGN SPECIFICATION FOR WOOD STRUCTURES, 2018 EDITION WITH SUPPLEMENT.
- TRUSS DESIGN AND FABRICATION SHALL BE THE RESPONSIBILITY OF THE TRUSS MANUFACTURER.
- ROOF TRUSSES SHALL BE DESIGNED FOR THE FOLLOWING SUPERIMPOSED LOADS. TRUSS LOADS SHALL BE IN COMBINATION PER THE REFERENCED BUILDING CODE IN NOTE A.4.

TOP CHORD	

DEAD=15 PSF BOTTOM CHORD DEAD=10 PSF LIVE=20 PSF

LIVE=20 PSF (LIVE LOAD IN ATTIC = 60 PSF)

SEE A1/S-151 AND WIND PRESSURE DIAGRAM ON S-004 FOR ADDITIONAL LOADS REQUIRED FOR DESIGN. THE TRUSSES AND THEIR CONNECTIONS ABOVE SHEAR WALL LOCATIONS ARE REQUIRED TO BE DESIGNED TO TRANSFER LATERAL FORCES FROM THE ROOF DIAPHRAGM INTO THE SHEAR WALLS. SEE DRAWING FOR LOAD TRANSFER REQUIRMENTS.

- 4. TRUSS MANUFACTURER SHALL PROVIDE PLACEMENT PLANS SEALED BY A PROFESSIONAL ENGINEER REGISTERED IN THE STATE OF THE PROJECT SHOWING TRUSS QUANTITY AND TYPE, DEPTHS, SPANS, CONNECTION DETAILS, SPECIAL LOADING CONDITIONS, PERMANENT AND TEMPORARY BRACING, AND BRIDGING.
- 5. TRUSS MANUFACTURER SHALL ALSO PROVIDE DESIGN CALCULATIONS SEALED BY PROFESSIONAL ENGINEER REGISTERED IN THE STATE OF THE PROJECT SHOWING DESIGN VALUES, CHORD AND WEB SIZES AND GRADES, METAL PLATE SIZES WITH JOINT LOCATION, AXIAL FORCE, TRUSS CONFIGURATION AND JOINT DEFLECTION.
- 6. MAXIMUM TRUSS SPACING SHALL BE 2'-0" O.C
- 7. PROVIDE BOTTOM CHORD BRACING AS SHOWN IN DETAIL A1/S-311
- PROVIDE 2x6 BLOCKING CONTINUOUS EACH SIDE AT RIDGE, AT PERIMETER, AND AS REQUIRED PER DRAWINGS
- 9. BRACE ROOF TRUSSES TO PROVIDE STABILITY DURING AND AFTER ERECTION

### G. TIMBER FRAMING

- 1. ALL TIMBER SHALL COMPLY WITH THE NATIONAL DESIGN SPECIFICATION FOR WOOD STRUCTURES, 2018 EDITION WITH SUPPLEMENT
- 3. ALL TIMBER SHALL BE CONNECTED USING PRE-MANUFACTURED ATTACHMENTS TO WALLS AND
- 4. TIMBER SHALL BE SOUTHERN YELLOW PINE NO. 2 GRADE OR BETTER. REFERENCE SPECIFICATION SECTION 061000 FOR ADDITIONAL REQUIREMENTS
- 5. TYPICAL EXTERIOR WALL STUDS SHALL BE 2x6 AT 12" O.C ATTACHED TO TOP AND BOTTOM PLATES WITH SIMPSON A34 (OR EQUAL) GALVANIZED PLATE ANGLES. TYPICAL INTERIOR LOAD BEARING WALLS SHALL BE 2x4 AT 16" O.C. ATTACHED TO TOP AND BOTTOM PLATES WITH SIMPSON A34 (OR EQUAL) GALVANIZED PLATE ANGLES.
- 6. ALL LOAD BEARING WALLS SHALL BE BLOCKED AT MID-HEIGHT UNLESS SHOWN OTHERWISE.
- 7. BRACE STUD WALLS UNTIL ALL WOOD DECKING, ROOF TRUSSES, AND SHEAR WALLS ARE IN PLACE.
- 8. INSTALL BEAMS WITH CROWN UP.
- 9. USE WATER-BORNE PRESSURE TREATED. WOLMANIZED WOOD FOR ALL LUMBER EXPOSED TO WEATHER OR IN CONTACT WITH MASONRY OR CONCETE
- 10. ALL HARDWARE AND FASTENERS EXPOSED TO PRESSURE TREATED WOOD OR THE ENVIRONMENT SHALL BE G185 COATED, HOT-DIP GALVANIZED PER ASTM A153, OR STAINLESS
- 11. REFER TO IBC 2021 TABLE 2304.10.2 FOR MINIMUM FASTENING REQUIREMENTS.
- H. LAMINATED VENEER LUMBER (LVL)
- 1. MATERIALS, MANUFACTURER AND QUALITY SHALL COMPLY WITH ICC EVAULATION SERVICE REPORT NO. ESR-1387.
- 2. PRODUCTS SHALL BE PROVEN BY TESTING AND EVALUATION IN ACCORDANCE WITH THE PROVISIONS OF ASTM D-5456.
- 3. SHOP DRAWINGS AND DETAILS SHALL BE FURNISHED FOR REVIEW AND APPROVAL BY THE ARCHITECT/ENGINEER BEFORE FABRICATION WORK IS COMMENCED.
- 4. UNLESS NOTED, THE FOLLOWING MINIMUM PROPERTIES AS PER 2.0E REDLAM LVL (AS

2000 KSI
1000 KSI
2900 PSI
1660 PSI
750 PSI
2635 PSI
285 PSI
0.50

- 5. FOR DRY USAGE CONDITIONS MOISTURE CONTENT SHALL BE 16% OR LESS U.N.O..
- 6. WET USAGE CONTENT SHALL BE USED OUTSIDE EXTERIOR WALLS.
- 7. TOLERANCES: FINISHED LENGTH SHALL BE WITHIN ±1/4". FINISHED DEPTH AND WIDTH SHALL BE
- 8. THE PRODUCTS DELIVERED SHALL BE FREE FROM MANUFACTURING ERRORS OR DEFECTS IN WORKMANSHIP OR MATERIAL
- 9. THE PRODUCTS SHALL BE WARRANTED TO PERFORM AS DESIGNED FOR THE NORMAL AND EXPECTED LIFE OF THIS STRUCTURE.
- 10. LAMINATED VENEER LUMBER SHALL CONFORM TO AND BE ACCOMPANIED BY APPROVED EVIDENCE OF COMPLIANCE WITH CHAPTER 23 OF THE 2021 IBC.
- 11. USE WATER-BORNE, PRESSURE TREATED, WOLMANIZED WOOD FOR ALL LUMBER EXPOSED TO WEATHER OR IN CONTACT WITH MASONRY OR CONCRETE.

### PLYWOOD:

1. ALL SHEATHING SHALL BEAR THE TRADEMARK STAMP OF THE AMERICAN PLYWOOD ASSOCIATION (APA). UNLESS NOTED OTHERWISE, ALL PANELS SHALL BE ORIENTED PERPENDICULAR TO SUPPORTS, AND NAILED WITH 10d COMMON NAILS AT 6" O.C. AT EDGES, 12" O.C. AT INTERMEDIATE SUPPORTS. SHEATHING THICKNESS REQUIRED WALL SHEATHING: 1/2" STRUCTURAL 1 RATED, PLYWOOD

ROOF SHEATHING: 5/8" EXPOSURE 1 RATED PLYWOOD UNBLOCKED, 32/16 SPAN RATING FLOOR SHEATHING: 3/4" THICK T&G EXPOSURE 1 RATED. WOLMANIZED PLYWOOD WITH A 48/24 SPAN RATING BLOCKED.

- 2. LONG SIDE OF PLYWOOD PANEL SHALL BE PERPENDICULAR TO THE SUPPORT WITH THE END JOINT OF THE PANEL ALIGNED WITH THE CENTER OF THE TWO ADJACENT PANELS. (NO CONTINUOUS PANEL JOINTS). PANELS SHALL BE CONTINUOUS OVER TWO OR MORE SPANS.
- 3. SUITABLE EDGE SUPPORT SHALL BE PROVIDED AS RECOMMENDED BY THE AMERICAN PLYWOOD ASSOCIATION BY USE OF PANEL CLIPS OR LUMBER BLOCKING BETWEEN JOISTS. PANEL END JOINTS SHALL OCCUR OVER FRAMING. PLYWOOD PANELS SHALL BE BLOCKED WITH 2X6 (MIN. U.N.O.) AT PERIMETER OF ROOF AND AT DIRECTIONAL CHANGES.

### SPECIAL INSPECTIONS

- QUALIFIED SPECIAL INSPECTORS SHALL BE RETAINED TO PERFORM INSPECTIONS REQUIRED BY THE BUILDING CODE. SEE SHEETS S-003 FOR THE SPECIAL INSPECTIONS SCHEDULES.
- 2. ANY FIELD OBSERVATIONS OR OTHER WORK PROGRESS REVIEW PERFORMED BY THE STRUCTURAL ENGINEER SHALL NOT BE CONSTRUED AS A SPECIAL INSPECTION.

### K. DEFERRED SUBMITTALS/DELEGATED DESIGNS:

- 1. IN ACCORDANCE WITH THE IBC, THE FOLLOWING IS A LIST OF DEFERRED SUBMITTALS / DELEGATED DESIGNS. THESE ITEMS SHALL BE DESIGNED BY A REGISTERED PROFESSIONAL ENGINEER (PE) IN THI PROJECT'S STATE. DOCUMENTS SHALL CONTAIN DESIGN DRAWINGS AND CALCULATIONS THAT ARE SIGNED AND SEALED BY THE PROFESSIONAL ENGINEER. DOCUMENTS SHALL BE SUBMITTED FOR REVIEW PRIOR TO CONSTRUCTION, FABRICATION, AND/OR INSTALLATION.
- A. GUARDRAILS, TOEBOARD, AND ASSOCIATED CONNECTIONS
- B. HANDRAILS
- STEEL STAIRS, STRINGERS, TREADS, AND ASSOCIATED CONNECTIONS
- D. AWNINGS AND ASSOCIATED CONNECTIONS
- E. WOOD ROOF TRUSSES
- F. ANY ITEM NOT SPECIFICALLY SHOWN ON STRUCTURAL DRAWINGS.

### STRUCTURAL STEEL

- STRUCTURAL STEEL FOR THIS PROJECT HAS BEEN DESIGNED IN ACCORDANCE WITH THE FIFTEENTH EDITION OF THE AMERICAN INSTITUTE OF STEEL CONSTRUCTION (AISC) "STEEL CONSTRUCTION MANUAL."
- 2. STRUCTURAL STEEL SHALL COMPLY WITH THE FOLLOWING SPECIFICATIONS:

	COMPONENT TYPE	STANDARD	YIELD STRENGTH
a.	STRUCTURAL STEEL WIDE FLANGE SHAPES:	ASTM A992	Fy = 50 ksi
b.	OTHER STRUCTURAL STEEL SHAPES, PLATES, AND BARS:	ASTM A36	Fy = 36 ksi
C.	HOLLOW STRUCTURAL SECTIONS (HSS):	ASTM A500 (GRADE B)	Fy = 50 ksi
d.	STEEL PIPE:	ASTM A53 (GRADE B)	Fy = 35 ksi
e.	ANCHOR RODS:	ASTM F1554	Fy = 36 ksi
		·	·

- WELDING SHALL BE IN ACCORDANCE WITH AWS D1.1, "STRUCTURAL WELDING CODE STEEL," LATEST EDITION. WELD ELECTRODES SHALL BE E70XX. PROVIDE 1/4" CONTINUOUS FILLET WELDS UNLESS NOTED OTHERWISE.
- 4. ALL EXTERIOR STRUCTURAL STEEL TO BE HOT-DIPPED GALVANIZED (MIN G60), U.N.O.

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US Fish & Wildlife Services

**PROJECT NAME** 

Cameron Prairie National Wildlife Refuge -Bunkhouse

Bell City, LA 70630

**DRAWING ISSUE** 

DESIGNED BY: D. SKULLY DRAWN BY: D.SKULLY CHECKED BY: W. HAYNES SUBMITTED BY: C.CUSICK 02/12/2025 PROJECT #: 1220834

**GENERAL** 

SHEET TITLE

STRUCTURAL NOTES

**SHEET NUMBER** 

ORIGINAL SHEET SIZE: 24" X 36"

100% ISSUED FOR CONSTRUCTION

170	5.5 WOOD CONSTRUCTION		
	MATERIAL / ACTIVITY	SERVICE	EXTENT
1.	FOR PREFABRICATED WOOD STRUCTURAL ELEMENTS, INSPECTION OF THE FABRICATION PROCESS AND ASSEMBLIES IN ACCORDANCE WITH SECTION 1704.2.5	IN PLANT REVIEW	PERIODIC
2.	FOR HIGH-LOAD DIAPHRAGMS, VERIFY GRADE AND THICKNESS OF STRUCTURAL PANEL SHEATHING AGREE WITH APPROVED BUILDING PLANS	FIELD INSPECTION	PERIODIC
3.	FOR HIGH-LOAD DIAPHRAGMS, VERIFY NOMINAL SIZE OF FRAMING MEMBERS AT ADJOINING PANEL EDGES, NAIL OR STAPLE DIAMETER AND LENGTH, NUMBER OF FASTENER LINES, AND THAT SPACING BETWEEN FASTENERS IN EACH LINE AND AT EDGE MARGINS AGREE WITH APPROVED BUILDING PLANS	FIELD INSPECTION	PERIODIC

170	1705.6 REQUIRED VERIFICATION AND INSPECTION OF SOILS			
	MATERIAL / ACTIVITY	SERVICE	EXTENT	
1.	VERIFY MATERIALS BELOW SHALLOW FOUNDATIONS ARE ADEQUATE TO ACHIEVE THE DESIGN BEARING CAPACITY	FIELD INSPECTION	PERIODIC	
2.	VERIFY EXCAVATIONS ARE EXTENDED TO PROPER DEPTH AND HAVE REACHED PROPER MATERIAL	FIELD INSPECTION	PERIODIC	
3.	PERFORM CLASSIFICATION AND TESTING OF COMPACTED FILL MATERIALS	FIELD INSPECTION	PERIODIC	
4.	VERIFY USE OF PROPER MATERIALS, DENSITIES, AND LIFT THICKNESS DURING PLACEMENT AND COMPACTION OF CONTROLLED FILL	FIELD INSPECTION	CONTINUOUS	
5.	PRIOR TO PLACEMENT OF CONTROLLED FILL, OBSERVE SUBGRADE AND VERIFY THAT SITE HAS BEEN PREPARED PROPERLY	FIELD INSPECTION	PERIODIC	
5.	COMPACTION OF CONTROLLED FILL  PRIOR TO PLACEMENT OF CONTROLLED FILL, OBSERVE SUBGRADE AND VERIFY THAT SITE HAS BEEN			

VICE EXTENT  ND FIELD PERIODIC
ECTION FERIODIC
ND FIELD CTION
ND FIELD PERIODIC
ND FIELD PERIODIC
ND FIELD PERIODIC ECTION
ND FIELD CONTINUOUS
ND FIELD ECTION CONTINUOUS
ND FIELD ECTION PERIODIC
ND FIELD CTION
CONTINUOUS
CONTINUOUS
PERIODIC
W FIELD NG AND RATORY ORTS
SPECTION PERIODIC

### NOTES:

1705.3 CONCRETE CONSTRUCTION

- a. WHERE APPLICABLE, SEE ALSO SECTION 1705.11 SPECIAL INSTRUCTIONS FOR SEISMIC RESISTANCE.
- b. SPECIFIC REQUIREMENTS FOR SPECIAL INSPECTION SHALL BE INCLUDED IN THE RESEARCH REPORT FOR THE ANCHOR ISSUED BY AN APPROVED SOURCE IN ACCORDANCE WITH ACI 355.2 OR OTHER QUALIFICATIONS PROCEDURES. WHERE SPECIFIC REQUIREMENTS ARE NOT PROVIDED, SPECIAL INSPECTION REQUIREMENTS SHALL BE SPECIFIED BY THE REGISTERED DESIGN PROFESSIONAL AND SHALL BE APPROVED BY THE BUILDING OFFICIAL PRIOR TO THE COMMENCEMENT OF THE WORK.

170	05.7 REQUIRED SPECIAL INSPECTIONS AND TESTS OF DRIVEN DEEP FOUNDATION ELEMENTS		
	TYPE	CONTINOUS SPECIAL INSPECTION	PERIODIC SPECIAL INSPECTION
1.	VERIFY ELEMENT MATERIALS, SIZES AND LENGTHS COMPLY WITH THE REQUIREMENTS.	Х	-
2.	DETERMINE CAPACITIES OF TEST ELEMENTS AND CONDUCT ADDITIONAL LOAD TESTS, AS REQUIRED.	X	-
3.	INSPECT DRIVING OPERATIONS AND MAINTAIN COMPLETE AND ACCURATE RECORDS FOR EACH ELEMENT.	Х	-
4.	VERIFY PLACEMENT LOCATIONS AND PLUMBNESS, CONFIRM TYPE AND SIZE OF HAMMER, RECORD NUMBER OF BLOWS PER FOOT OF PENETRATION, DETERMINE REQUIRED PENETRATIONS TO ACHIEVE DESIGN CAPACITY, RECORD TIP AND BUTT ELEVATIONS AND DOCUMENT ANY DAMAGE TO FOUNDATION ELEMENT.	X	-
5.	FOR SPECIALTY ELEMENTS, PERFORM ADDITIONAL INSPECTIONS AS DETERMINED BY THE REGISTERED DESIGN PROFESSIONAL IN RESPONSIBLE CHARGE.	-	Х

### STRUCTURAL ABBREVIATION KEY

	SIRUCIUR	AL ADDREVIA I	IONKET
@	AT	lb	POUNDS
A.F.F.	ABOVE FINISHED FLOOR	L.L.	LIVE LOAD
ARCH'L	ARCHITECTURAL	LLH	LONG LEG HORIZONTAL
B/	BOTTOM OF	LLV	LONG LEG VERTICAL
BLDG	BUILDING	LSV	LONG SIDE VERTICAL
ВМ	BEAM	L.W.	LIGHT WEIGHT
BTM.	BOTTOM	MAX.	MAXIMUM
BTW.	BETWEEN	MECH.	MECHANICAL
C.L.	CENTERLINE	MFR.	MANUFACTURER
CIP	CAST-IN-PLACE	MIN.	MINIMUM
CJ	CONTROL JOINT	mph	MILES PER HOUR
C.J.P.	COMPLETE JOINT PENETRATING WELD	N/A	NOT APPLICABLE
CLR.	CLEAR	N.I.C.	NOT IN CONTRACT
CMU	CONCRETE MASONRY UNIT	N.S.	NEAR SIDE
COL.	COLUMN	N.T.S.	NOT TO SCALE
CONC.	CONCRETE	N.W.	NORMAL WEIGHT
CONST.	CONSTRUCTION	0/0	OUT TO OUT
CONT.	CONTINUOUS	O.C.	ON CENTER
DEG.	DEGREE	О.Н.	OPPOSITE HAND
DIA.	DIAMETER	OPN'G	OPENING
D.L.	DEAD LOAD	OPP.	OPPOSITE
DWG.	DRAWING	PEMB	PRE-ENGINEERED METAL BUILDING SYSTEM
DWL.	DOWEL	PL.	PLATE
E.E.	EACH END	PJF	PRE-MOLDED JOINT FILLER
E.F.	EACH FACE	P.J.P.	PARTIAL JOINT PENETRATING WELD
ELEC.	ELECTRICAL	PROJ.	PROJECTION
ELEV.	ELEVATION	PT	PRESSURE TREATED
E.O.R.	ENGINEER OF RECORD	PTB	POST-TENSION BEAM
	EDGE OF SLAB		
E.O.S.		psf	POUNDS PER SQUARE FOOT
EQ.	EQUAL	psi	POUNDS PER SQUARE INCH
E.S.	EACH SIDE	RCB	REINFORCED CONCRETE BEAM
E.W.	EACH WAY	REINF.	REINFORCEMENT
EXIST.	EXISTING	REQ'D	REQUIRED
EXP.	EXPANSION	SDSTSMS	SELF-DRILLING, SELF-TAPPING SHEET METAL SCREWS
EXT.	EXTERIOR	0.5	
FD	FLOOR DRAIN	S.F.	SQUARE FOOT
FDN.	FOUNDATION	SIM.	SIMILAR
F.F.	FINISH FLOOR	SLV.	SHORT LEG VERTICAL
F.P.	FLOOR PENETRATION	SQ.	SQUARE
F.S.	FAR SIDE	STD.	STANDARD
FT.	FEET	STL.	STEEL
FTG	FOOTING	S.W.	SELF-WEIGHT
GEN/GEN'L		T&B	TOP AND BOTTOM
GT	GIRDER TRUSS	T/	TOP OF
HK.	HOOK	THRD'D	THREADED
HOR.	HORIZONTAL	TOS	TOP OF STEEL
H.S.A.	HEADED STUD ANCHOR	TYP.	TYPICAL
HSS	HOLLOW STRUCTURAL SECTION	U.N.O.	UNLESS NOTED OTHERWISE
HGT.	HEIGHT	VERT.	VERTICAL
HT	HIP TRUSS	VIF	VERIFY IN FIELD
HVY.	HEAVY	w/	WITH
IN.	INCH	W/C	WATER TO CEMENT
INT.	INTERIOR	WF	WIDE FLANGE
K	KIPS	W.L.	WIND LOAD
ksi	1,000 POUNDS PER SQUARE INCH	W.P.	WORKING POINT
		WT.	WEIGHT
		WWR	WELDED WIRE REINFORCEMENT

NOTE: NOT ALL ABBREVIATIONS WILL BE USED.

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DESIGNED BY: D. SKULLY
DRAWN BY: D.SKULLY
CHECKED BY: W. HAYNES
SUBMITTED BY: C.CUSICK
DATE: 02/12/2025
PROJECT #: 1220834

SHEET TITLE

SCHEDULE OF SPECIAL INSPECTIONS & ABBREVIATION KEY

SHEET NUMBER

S-003

- 1. POSITIVE VALUES ACT TOWARD THE ROOF SURFACE (COMPRESSION) AND NEGATIVE VALUES ACT AWAY FROM THE ROOF SURFACE (UPLIFT).
- 2. FOR ROOF TRUSS DESIGN, NET UPLIFT = SCHEDULED VALUE + 6 psf.
- 3. LINEAR INTERPOLATION PERMITTED BETWEEN VALUES.
- 4. VALUES INDICATED IN TABLES ARE FACTORED LOADS IN ACCORDANCE WITH ASCE 7-16.

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SHEET TITLE


WIND LOADING DIAGRAMS

S-004

ORIGINAL SHEET SIZE: 24" X 36"

### ROOF COMPONENTS AND CLADDING WIND PRESSURE SCHEDULE


		EFFECTIVE WIND AREA			
	ZONE	AREA ≤ 10 S.F.	AREA = 25 S.F.	AREA = 50 S.F.	100 S.F. ≤ AREA
	1	-64.3 / 38.2	-62.5 / 31.3	-56.9 / 26.1	-51.2 / 20.8
	2e	-86.0 / 38.2	-76.7 / 31.3	-69.7 / 26.1	-62.6 / 20.8
	2r	-112.1 / 38.2	-97.4 / 31.3	-86.4 / 26.1	-75.3 / 20.8
	3	-86.0 / 38.2	-76.7 / 31.3	-69.7 / 26.1	-62.6 / 20.8
	1	-78.2 / 38.2	-44.6 / 31.3	-40.9 / 26.1	-86.9 / 20.8
HANG		-99.9 / 38.2	-97.2 / 31.3	-95.2 / 26.1	-93.2 / 20.8
OVERHANG	2r	-126.0 / 38.2	-118.0 / 31.3	-112.0 / 26.1	-105.9 / 20.8
J	3	-126.0 / 38.2	-108.7 / 31.3	-95.6 / 26.1	-82.6 / 20.8

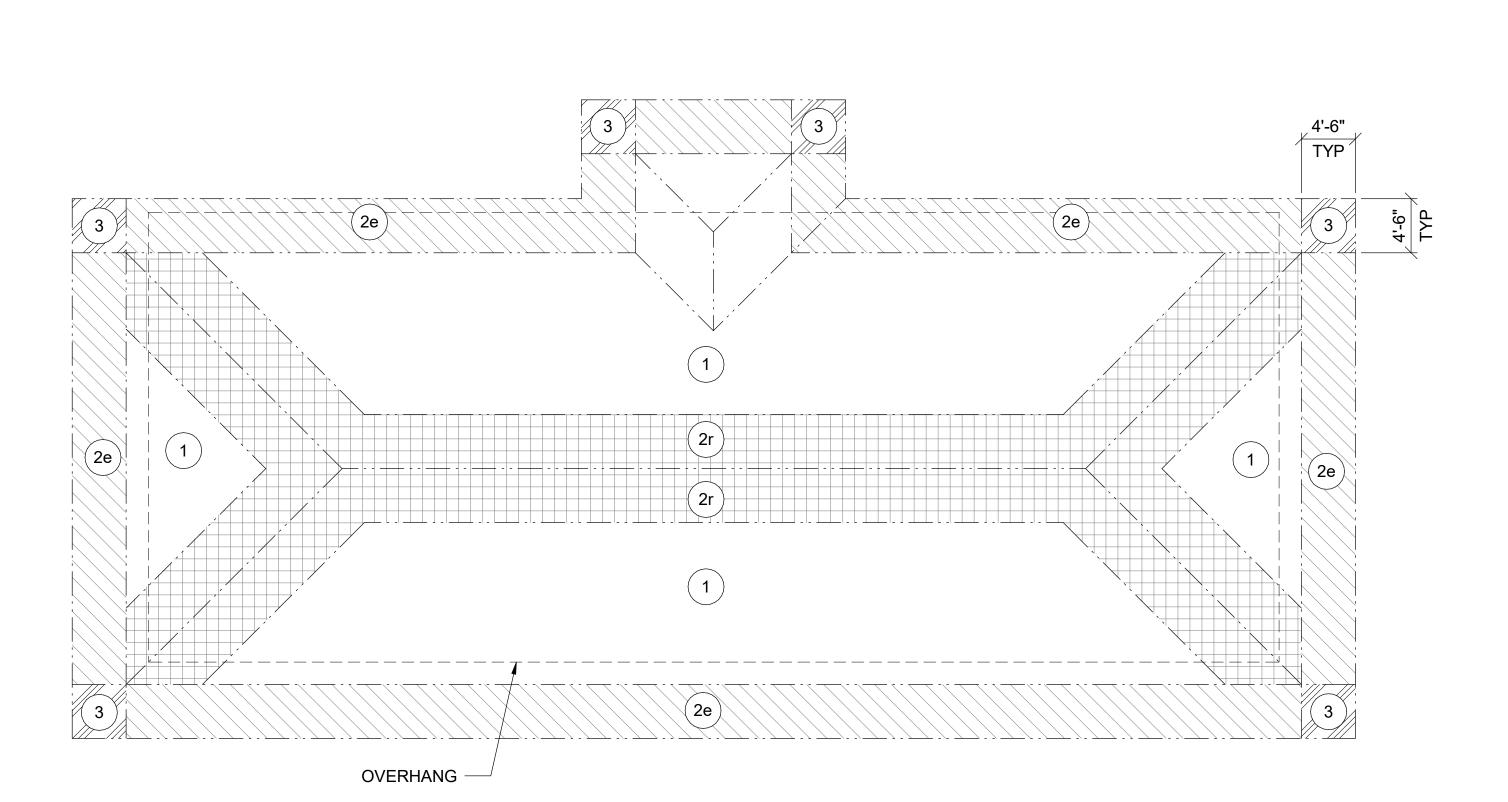


# ROOF COMPONENTS AND CLADDING WIND PRESSURE DIAGRAM N.T.S

## WALL COMPONENTS AND CLADDING WIND PRESSURE SCHEDULE

	EFFECTIVE WIND AREA			
ZONE	AREA ≤ 10 S.F.	AREA = 50 S.F.	AREA = 200 S.F.	500 S.F. ≤ AREA
4	-55.6 / 51.2	-50.2 / 45.9	-45.6 / 41.3	-42.6 / 38.2
5	-68.6 / 51.2	-57.9 / 45.9	-48.7 / 41.3	-42.6 / 38.2

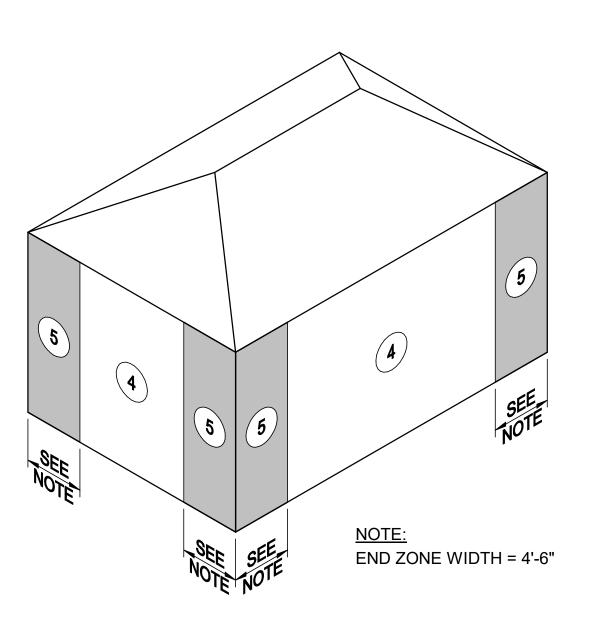

WALL COMPONENTS AND CLADDING (A3) WIND PRESSURE DIAGRAM - HIP ROOF

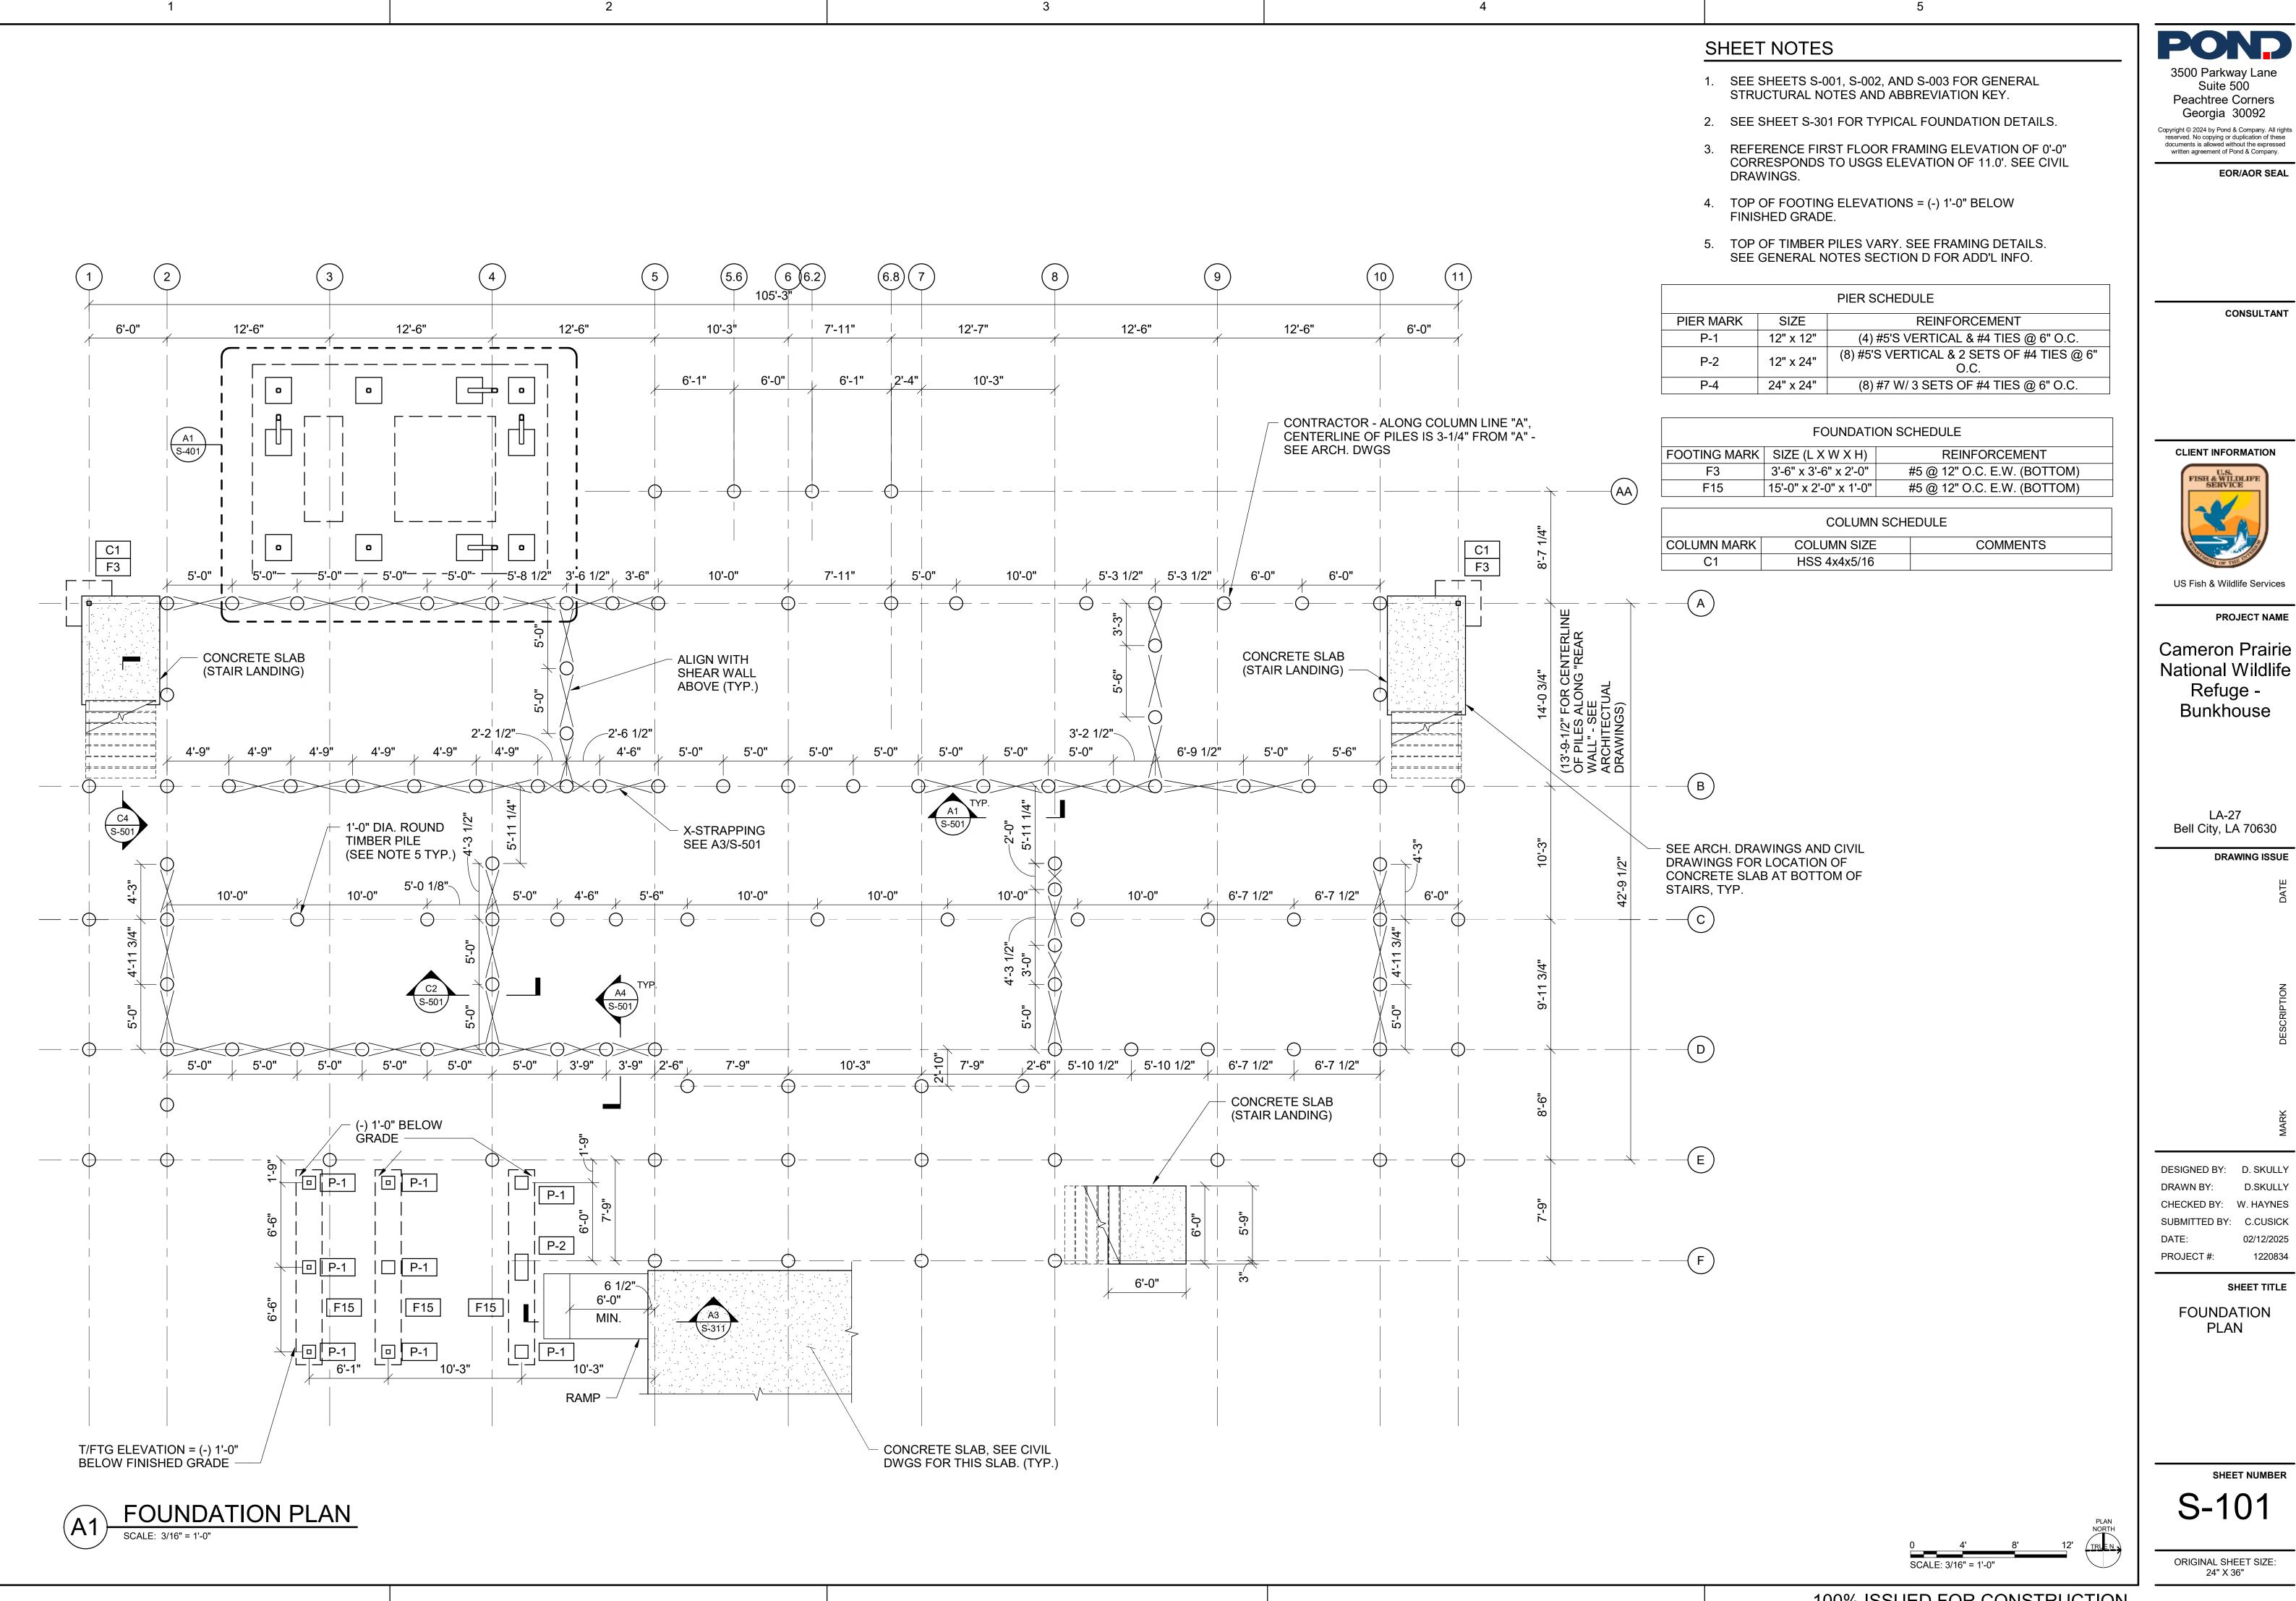

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DESIGNED BY: D. SKULLY D.SKULLY DRAWN BY: CHECKED BY: W. HAYNES SUBMITTED BY: C.CUSICK 02/12/2025 PROJECT #: 1220834

SHEET TITLE

**FOUNDATION** PLAN

SHEET NUMBER

S-101

ORIGINAL SHEET SIZE: 24" X 36"

100% ISSUED FOR CONSTRUCTION


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DESIGNED BY: D. SKULLY D.SKULLY DRAWN BY: CHECKED BY: W. HAYNES SUBMITTED BY: C.CUSICK 02/12/2025 1220834 PROJECT #:

FIRST FLOOR FRAMING PLAN

SHEET TITLE

**SHEET NUMBER** 

S-111

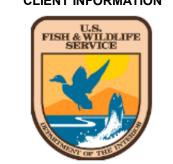ORIGINAL SHEET SIZE: 24" X 36"

SHEET NOTES

- SEE SHEETS S-001, S-002, AND S-003 FOR GENERAL STRUCTURAL NOTES, AND ABBREVIATION KEY.
- SEE SHEETS S-301 AND S-311 FOR TYPICAL DETAILS.
- TOP OF FLOOR SHEATHING ELEVATION = 11'-0", WHICH IS REFERENCE ELEVATION (0'-0") UNLESS NOTED OTHERWISE.
- FLOOR JOISTS SHALL BE EQUALLY SPACED BETWEEN COLUMN LINES, UNLESS NOTED OTHERWISE.
- SEE S-601 FOR SHEAR WALL, JOIST HANGER, AND HEADER SCHEDULES AND ADDITIONAL INFO.
- SEE C4/S-601 FOR SHEAR WALL PLAN. ALL SHEAR WALLS SHALL BE CENTERED OVER BEAMS

### **BEAM SCHEDULE**

MARK	MEMBER	NOTES
LVL212	1.75 x 11.875	SEE NOTE 1
LVL412	3.5 x 11.875	SEE NOTE 1
(2) 2x12	(2) 1.5 x 11.25	SEE NOTE 2
LVL612	5.25 x 11.875	SEE NOTE 1
LVL712	7 x 11.875	SEE NOTE 1
(3) 2x12	(3) 1.5 x 11.875	SEE NOTE 2

CONTRACTOR: THE FLOOR MEMBERS

MINIMUM OF (3) 2x6s AT GIRDER TRUSS ABOVE -SEE ROOF PLAN (TYP.)

TYP. @

2x4@16" O.C.

LOAD BEARING

(-) 1-1/2"

WALLS, TYP.

(2) 2x12

(3) 2x12

(3) 2x12

(2) 2x12

6'-0"

(10)

2x6@12" O.C. FOR

- 2x12@16" O.C. TYP

AT DECK FRAMING

EXTERIOR WALLS, TYP.

FOR INTERIOR

STEEL COL

WILL ONLY HAVE SPLICES/GAPS

OCCURRING OVER PILES

8'-0" MIN.

(2 SPAN)

2x12 @ 16" O.C.

TYP. @ END OF

(2) 2x12

LVL412

||LVL412 ||(2 SPAN)|

LVL412

12'-6"

8'-0" MIN.

SHEAR WALL

(2 SPAN)

LVL412

LVL412

LVL412 (2 SPAN)

LVL412

12'-6"

6x6 TIMBER

POST TYP

2x12 @ 1/6" O.C.

LVL412

18'-8" x 12'-1"

**GALV STEEL** GRATING -

PLATFORM W/

8'-0" MIN.

(2 SPAN)

LVL412

(2) 2x12

LVL412

—8'-0" MIN.—

C1 S-311

12'-6"

FIRST FLOOR FRAMING PLAN

RAMP

SCALE: 3/16" = 1'-0"

(-) 1-1/2"

D2 S-301

(-) 0-3/8"

(-) 1-1/2" N

2x12@12" O.C. TYP

ADD BLOCKING AS

AT CORNERS

NEEDED FOR DECKING

**PATTERN** 

(3) 2x12

(3) 2x12

(2) 2x12

2x12@16" O.C. TYP -

 $\backslash |/| \backslash |/|$ 

(2 SPAN)

LVL412

2x12 @ 16" O.C.

WALL PLAN C4/S-601 -

(2) 2x12

(2) 2x12 @ 16" O.C.

SW2 SEE SHEAR

| LVL412|

2X12 @ 16" O.C.

| LVL412 | (2 SPAN) | LVL412 | (2 SPAN)

SW2 OVER A LVL412, TYP.

B2 `

\s-501*]* 

12'-6"

\_(2 SPAN)\_

LVL412

SW2 OVER A

LVL412, TYP.

 $\left(6.8\right)$ 

 $\left(6.2\right)$ 

6'-1"

(2) 2x12

LVL412

LVĻ412

LVL412

SW2 OVER A

LVL412, TYP.

2x12 @ 16" O.C.

(2) 2x12

(2) 2x12 @ 16" O.C.

LVL412

| LVL612 |

\_LVL412\_\_

**(-**) 1-1/2" /

LVL412

**SLOPING** 

10'-3"

SW2 SEE SHEAR

SW2 OVER A

LVL412, TYP.

| LVL412 |

(2) 2x12 @ 16" O.C.

LVL612

LVL412\_

LVL412

10'-3"

(-) 2"

WALL PLAN C4/S-601

6'-0"

(2) 2x12

| 2x12 @ 16" O.C.

(2) 2x12 @ 16" O.C.

FIRE PUMP & TANK

| LVL412

WATER HEATER

LVL612

\_\_LVL412\_

\(-) 1-1/2"\

LVL412

SLOPING

10'-3"

105'-3

| LVL412 |

(5.6)

(2) 2x12

A1 S-402

\_(2 SPAN)

LVL412

₩2x12 @ 16" O.C.|

-**||**-LVL412 |

Į LVL412|∭|LVL412 | LVL712∭ 😝 |

LVL412 (2 SPAN) + LVL512 + +

(-) 1-1/2"

12'-6"

(2) 2X12 @ 16" O.C.

LVL 212 @ 16" O.C.

LVL 212 @ 8" O.C

- 1. SEE GENERAL NOTES SECTION H FOR LVL PROPERTIES AND ADDITIONAL INFO.
- USE PLYWOOD TO MATCH WIDTH OF LVL BEAMS AS NEEDED. SEE NOTE NO. 16 ON THE FASTENING SCHEDULE ON S602 FOR ATTACHING BUILT UP BEAMS TOGETHER.
- ALL BEAMS CAN ONLY HAVE GAPS IN THEIR LENGTHS AT TOP OF PILES. GAPS CANNOT OCCUR BETWEEN

### **MECHANICAL EQUIPMENT NOTES:**


- MAXIMUM OPERATING WEIGHTS OF THE SELECTED EQUIPMENT SHALL BE VERIFIED AND COORDINATED WITH THE DESIGN WEIGHTS INDICATED BELOW BY THE CONSTRUCTION PROFESSIONAL. THIS SHALL BE COMPLETED BEFORE THE PROCUREMENT OF ANY MATERIALS AND EQUIPMENT AND THE DEVELOPMENT OF ANY SHOP DRAWINGS OR SUBMITTALS.
- 2. THE STRUCTURE HAS BEEN DESIGNED FOR MECHANICAL **EQUIPMENT WITH THE FOLLOWING MAXIMUM OPERATING** WEIGHTS:

MECH EQUIPMENT	OPERATING WEIGHT (LBS.)
FIRE PUMP & TANK	4,000
WATER HEATER	1,400

NOT ALL MECHANICAL EQUIPMENT IS SHOWN. ONLY LARGER EQUIPMENT WITH THE MAXIMUM OPERATING WEIGHTS USED FOR THE STRUCTURAL DESIGN IS INDICATED.

## SHEET LEGEND

DENOTES TOP OF DECKING ELEVATION (SEE ARCH. DWGS. FOR ADDITIONAL INFORMATION REGARDING SLOPING DECK.)

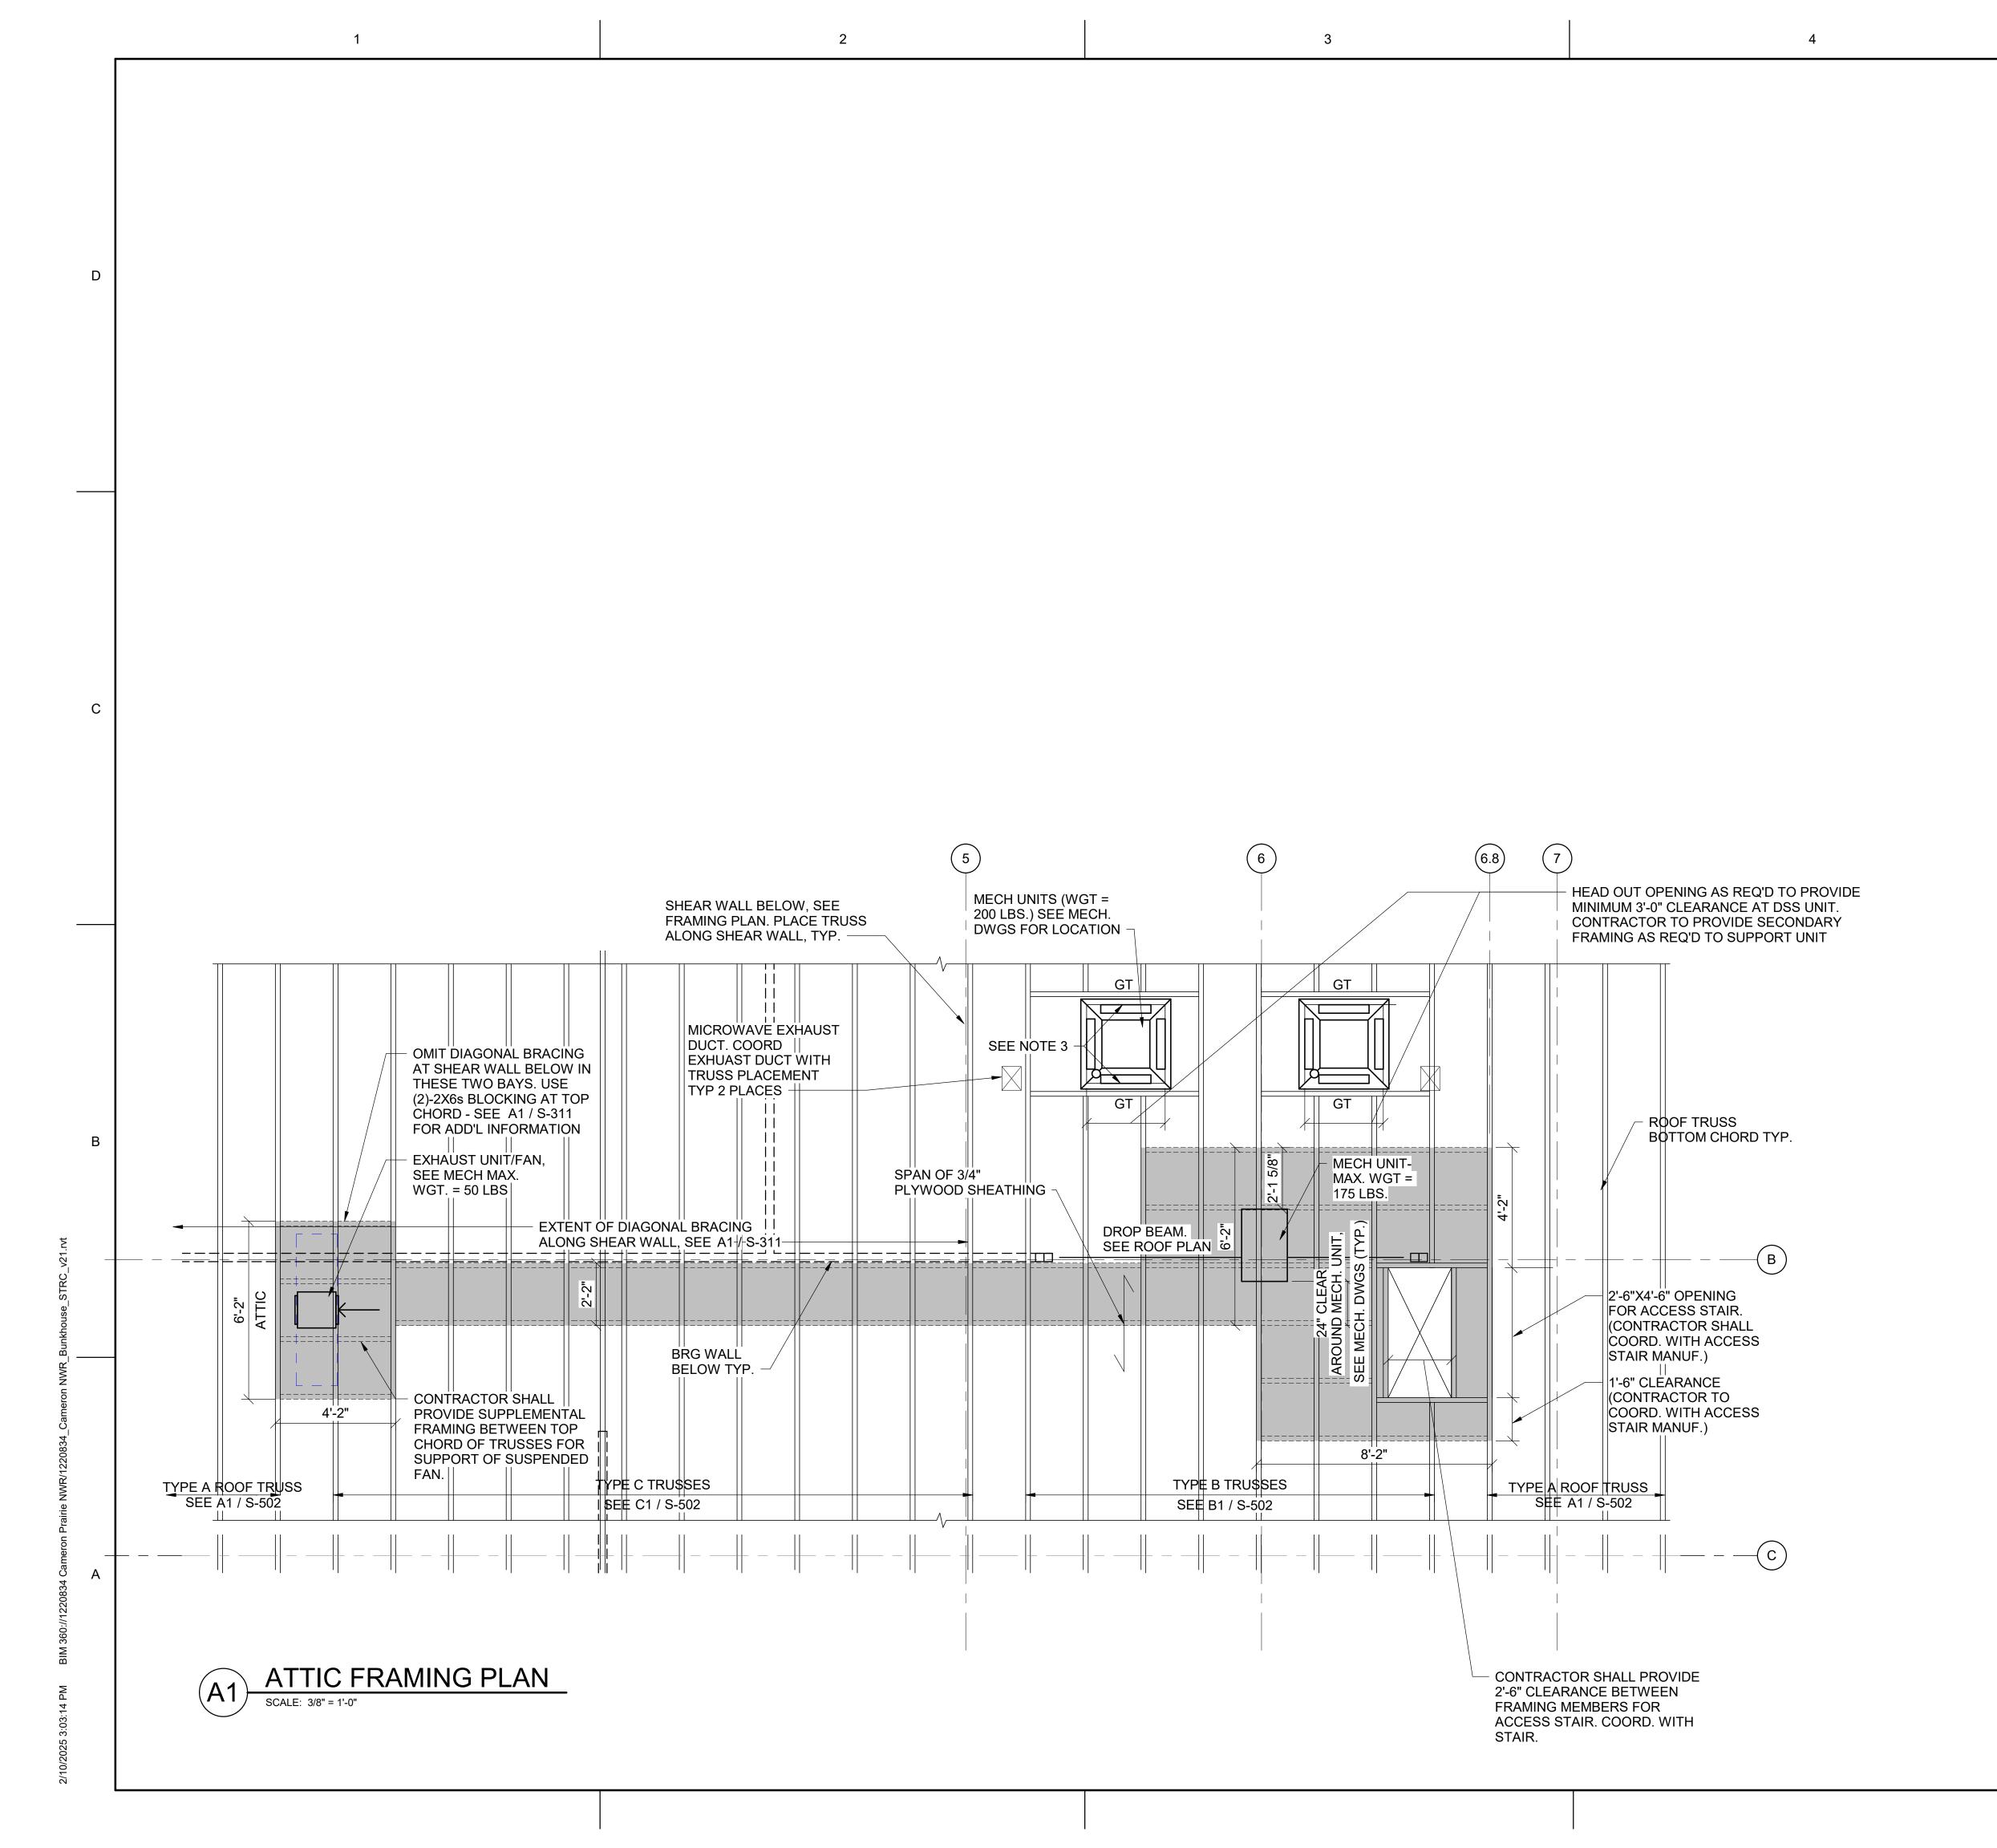

- 1. WHERE SPACING BETWEEN TRUSSES EXCEED 2 FEET O.C., THE CONTRACTOR SHALL PROVIDE SUPPLEMENTAL FRAMING AT THE TOP CHORD FOR SUPPORT OF ROOF SHEATHING AND AT THE BOTTOM CHORD FOR SUPPORT OF CEILING.
- 2. SEE S-502 FOR SCHEMATIC TRUSS PROFILES FOR TRUSSES TYPE A, B, AND C (INDICATED ON THIS PLAN.)
- 3. TRUSS MFR SHALL PROVIDE GIRDER AT BOTTOM CHORD TO ALLOW MECH UNIT TO BE MOUNTED FLUSH WITH CEILING. COORD W/ MECH. TOP CHORDS SHALL PROVIDE CONTINUOUS SUPPORT FOR ROOF SHEATHING.
- 4. ATTIC TO BE DRAFTSTOPPED INTO 3000SF MAX SECTIONS. APPLY 1 LAYER 5/8" GWB TO TRUSS AND SEAL TO DECK AND RATED CEILING BELOW.

SHEET NOTES

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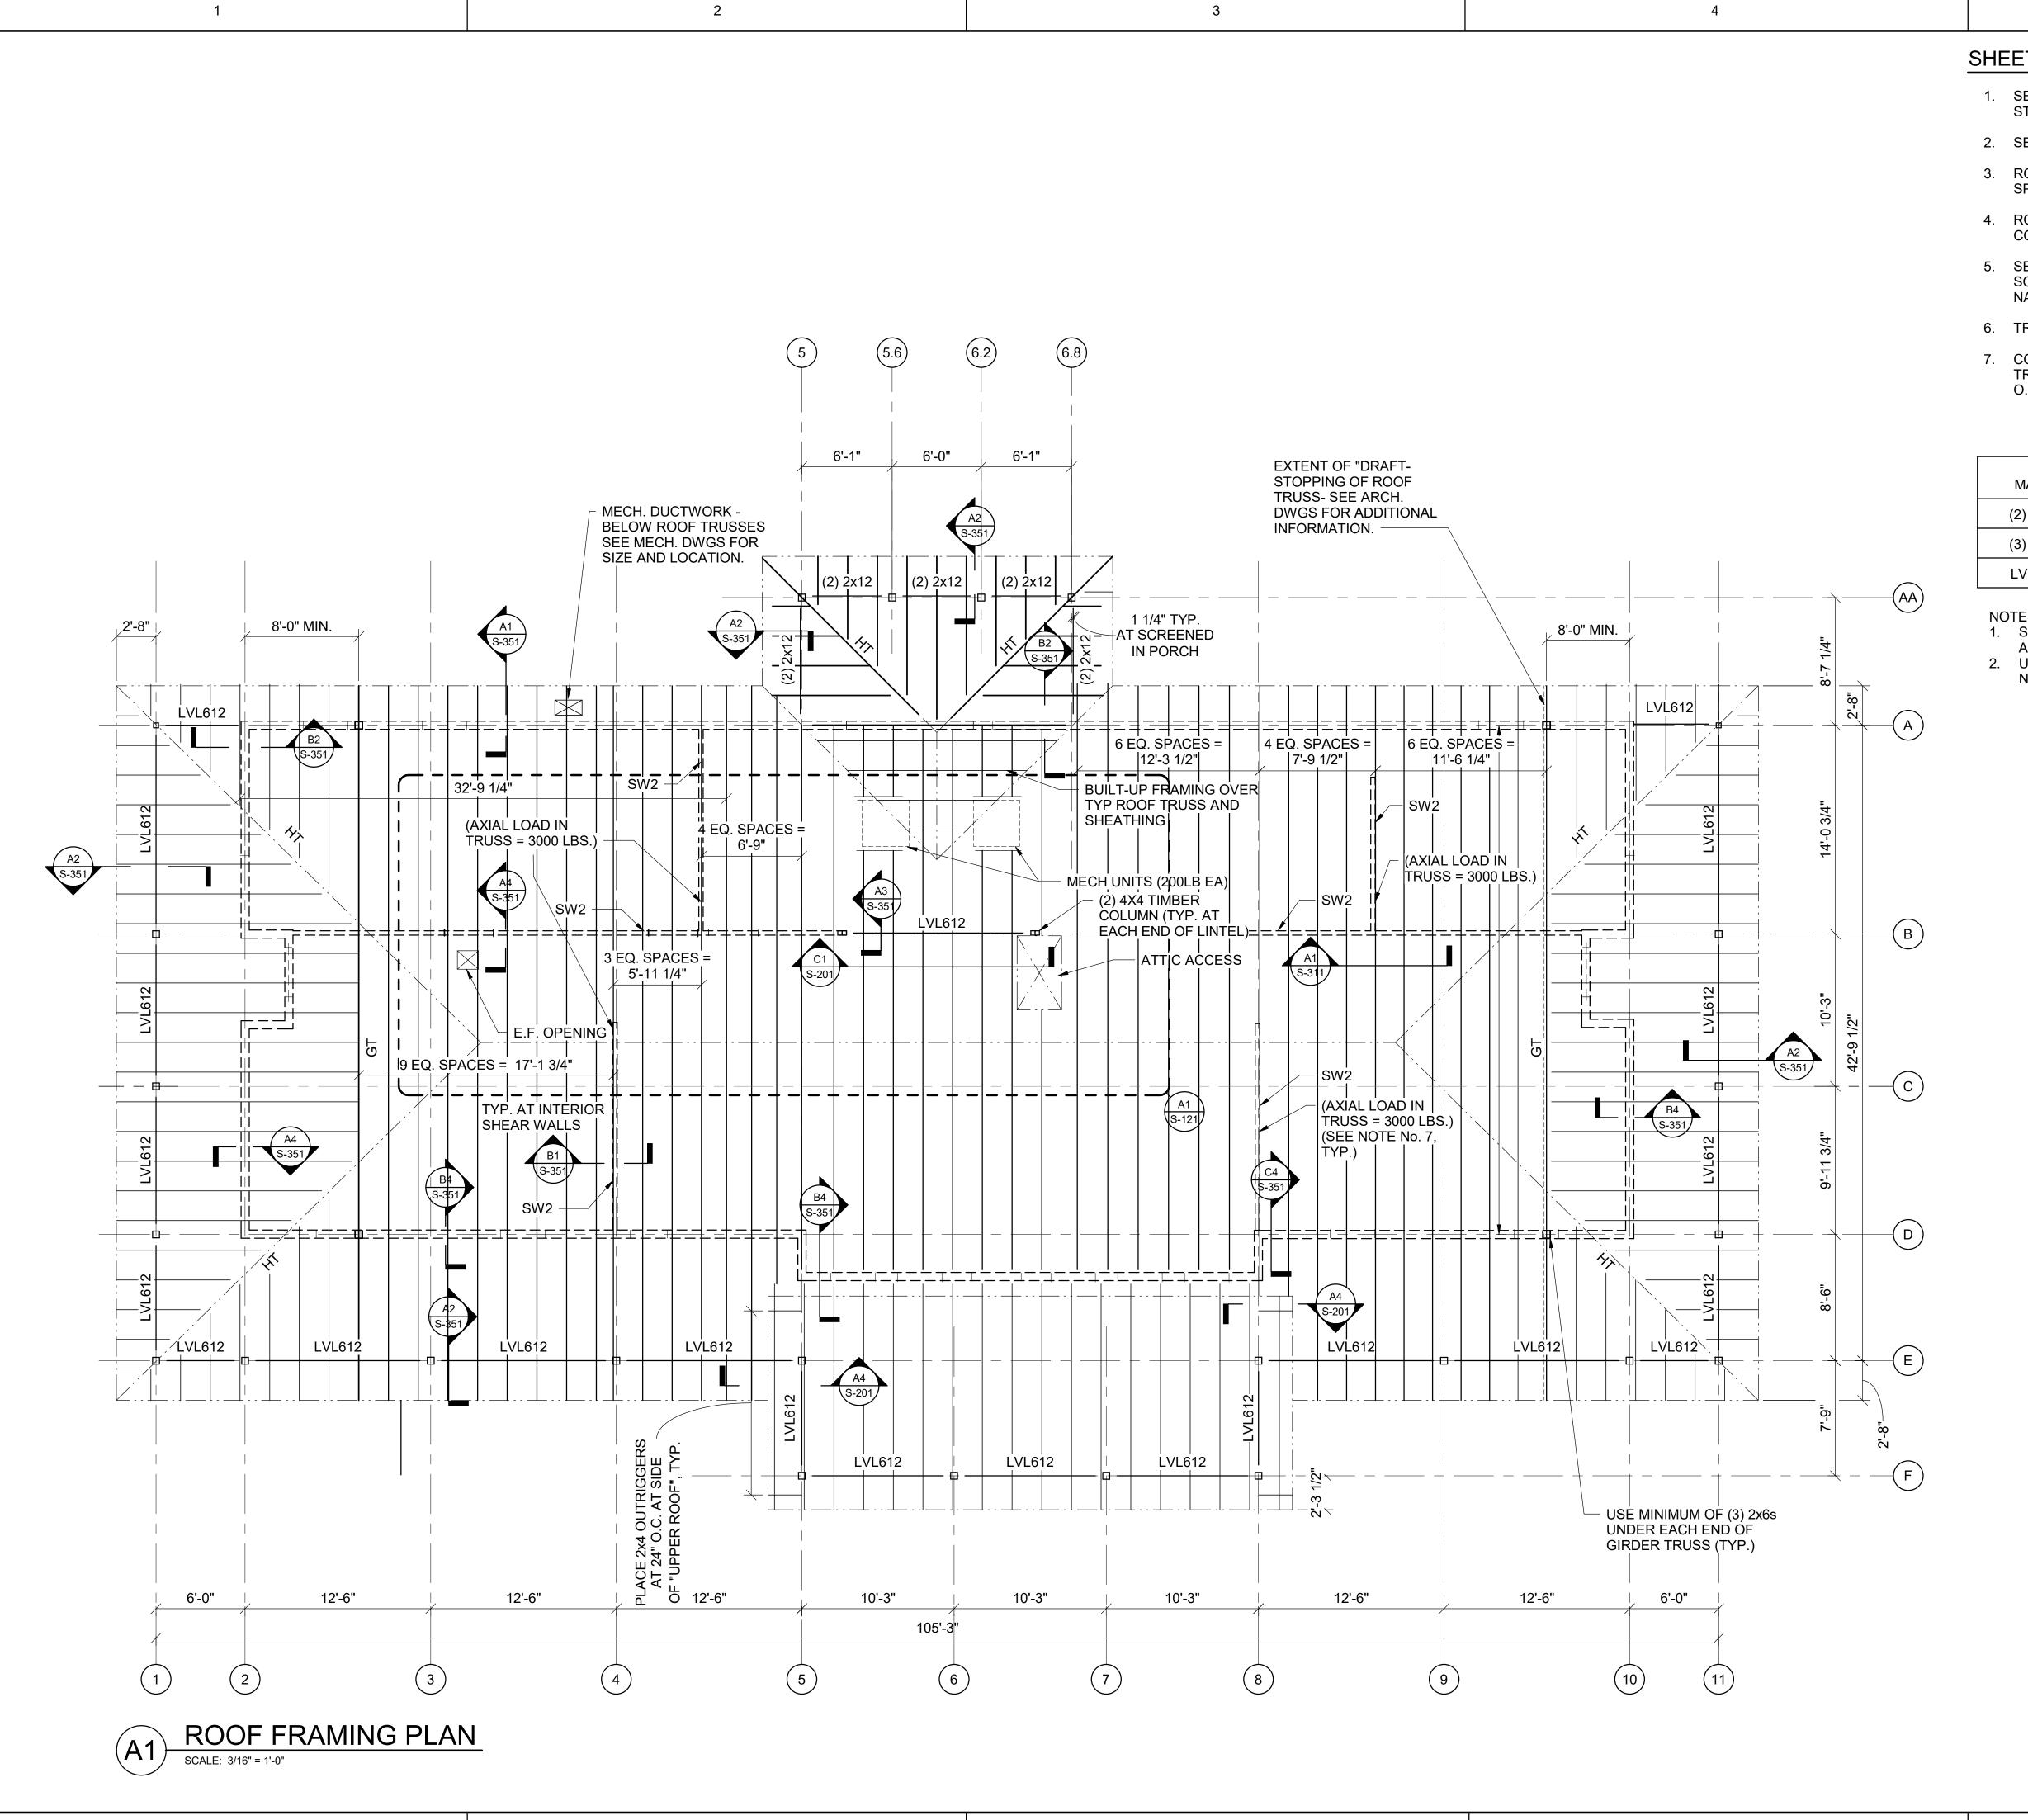
DESIGNED BY: B. NEW DRAWN BY: E. GOSSETT

CHECKED BY: W. HAYNES SUBMITTED BY: C. CUSICK 02/12/2025 PROJECT #: 1220834

SHEET TITLE

ATTIC FRAMING PLAN

SHEET NUMBER S-121



### SHEET NOTES

- 1. SEE SHEETS S-001,S-002, AND S-003 FOR GENERAL STRUCTURAL NOTES, AND ABBREVIATION KEY.
- 2. SEE SHEET S-351 FOR TYPICAL DETAILS.
- 3. ROOF DECK AND ATTACHMENT SHALL BE OF THE TYPE SPECIFIED IN GENERAL NOTE I ON SHEET S-002.
- 4. ROOF TRUSSES SHALL BE EQUALLY SPACED BETWEEN COLUMN LINES, UNLESS NOTED OTHERWISE.
- 5. SEE SHEET S-601 FOR HEADER AND SHEAR WALL SCHEDULES, AND TYP DIAPHRAGM AND SHEAR WALL NAILING SCHEMATICS.
- TRUSS BEARING ELEV. 10'-1 1/8". ABOVE FLOOR SHEATHING
- 7. CONTRACTOR SHALL ATTACH ROOF SHEATHING TO TRUSSES WITH AXIAL LOADS IN THEM USING 10d NAILS @ 6"

### ROOF BEAM SCHEDULE

MARK	MEMBER	NOTES
(2) 2x12	(2) 1.5 x 11.25	SEE NOTE 2
(3) 2x12	(3) 1.5 x 11.25	SEE NOTE 2
LVL612	5 1/4" x 11 7/8" LVL	SEE NOTE 1

### NOTES:

- 1. SEE GENERAL NOTES SECTION H FOR LVL PROPERTIES AND ADDITIONAL INFO.
- 2. USE PLYWOOD TO MATCH WIDTH OF LVL BEAMS AS NEEDED.

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US Fish & Wildlife Services

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LA-27 Bell City, LA 70630

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DESIGNED BY: D. SKULLY D.SKULLY DRAWN BY: CHECKED BY: W. HAYNES SUBMITTED BY: C.CUSICK 02/12/2025 PROJECT #:

SHEET TITLE


**ROOF FRAMING** PLAN

SHEET NUMBER

S-151

ORIGINAL SHEET SIZE: 24" X 36"

SCALE: 3/16" = 1'-0"

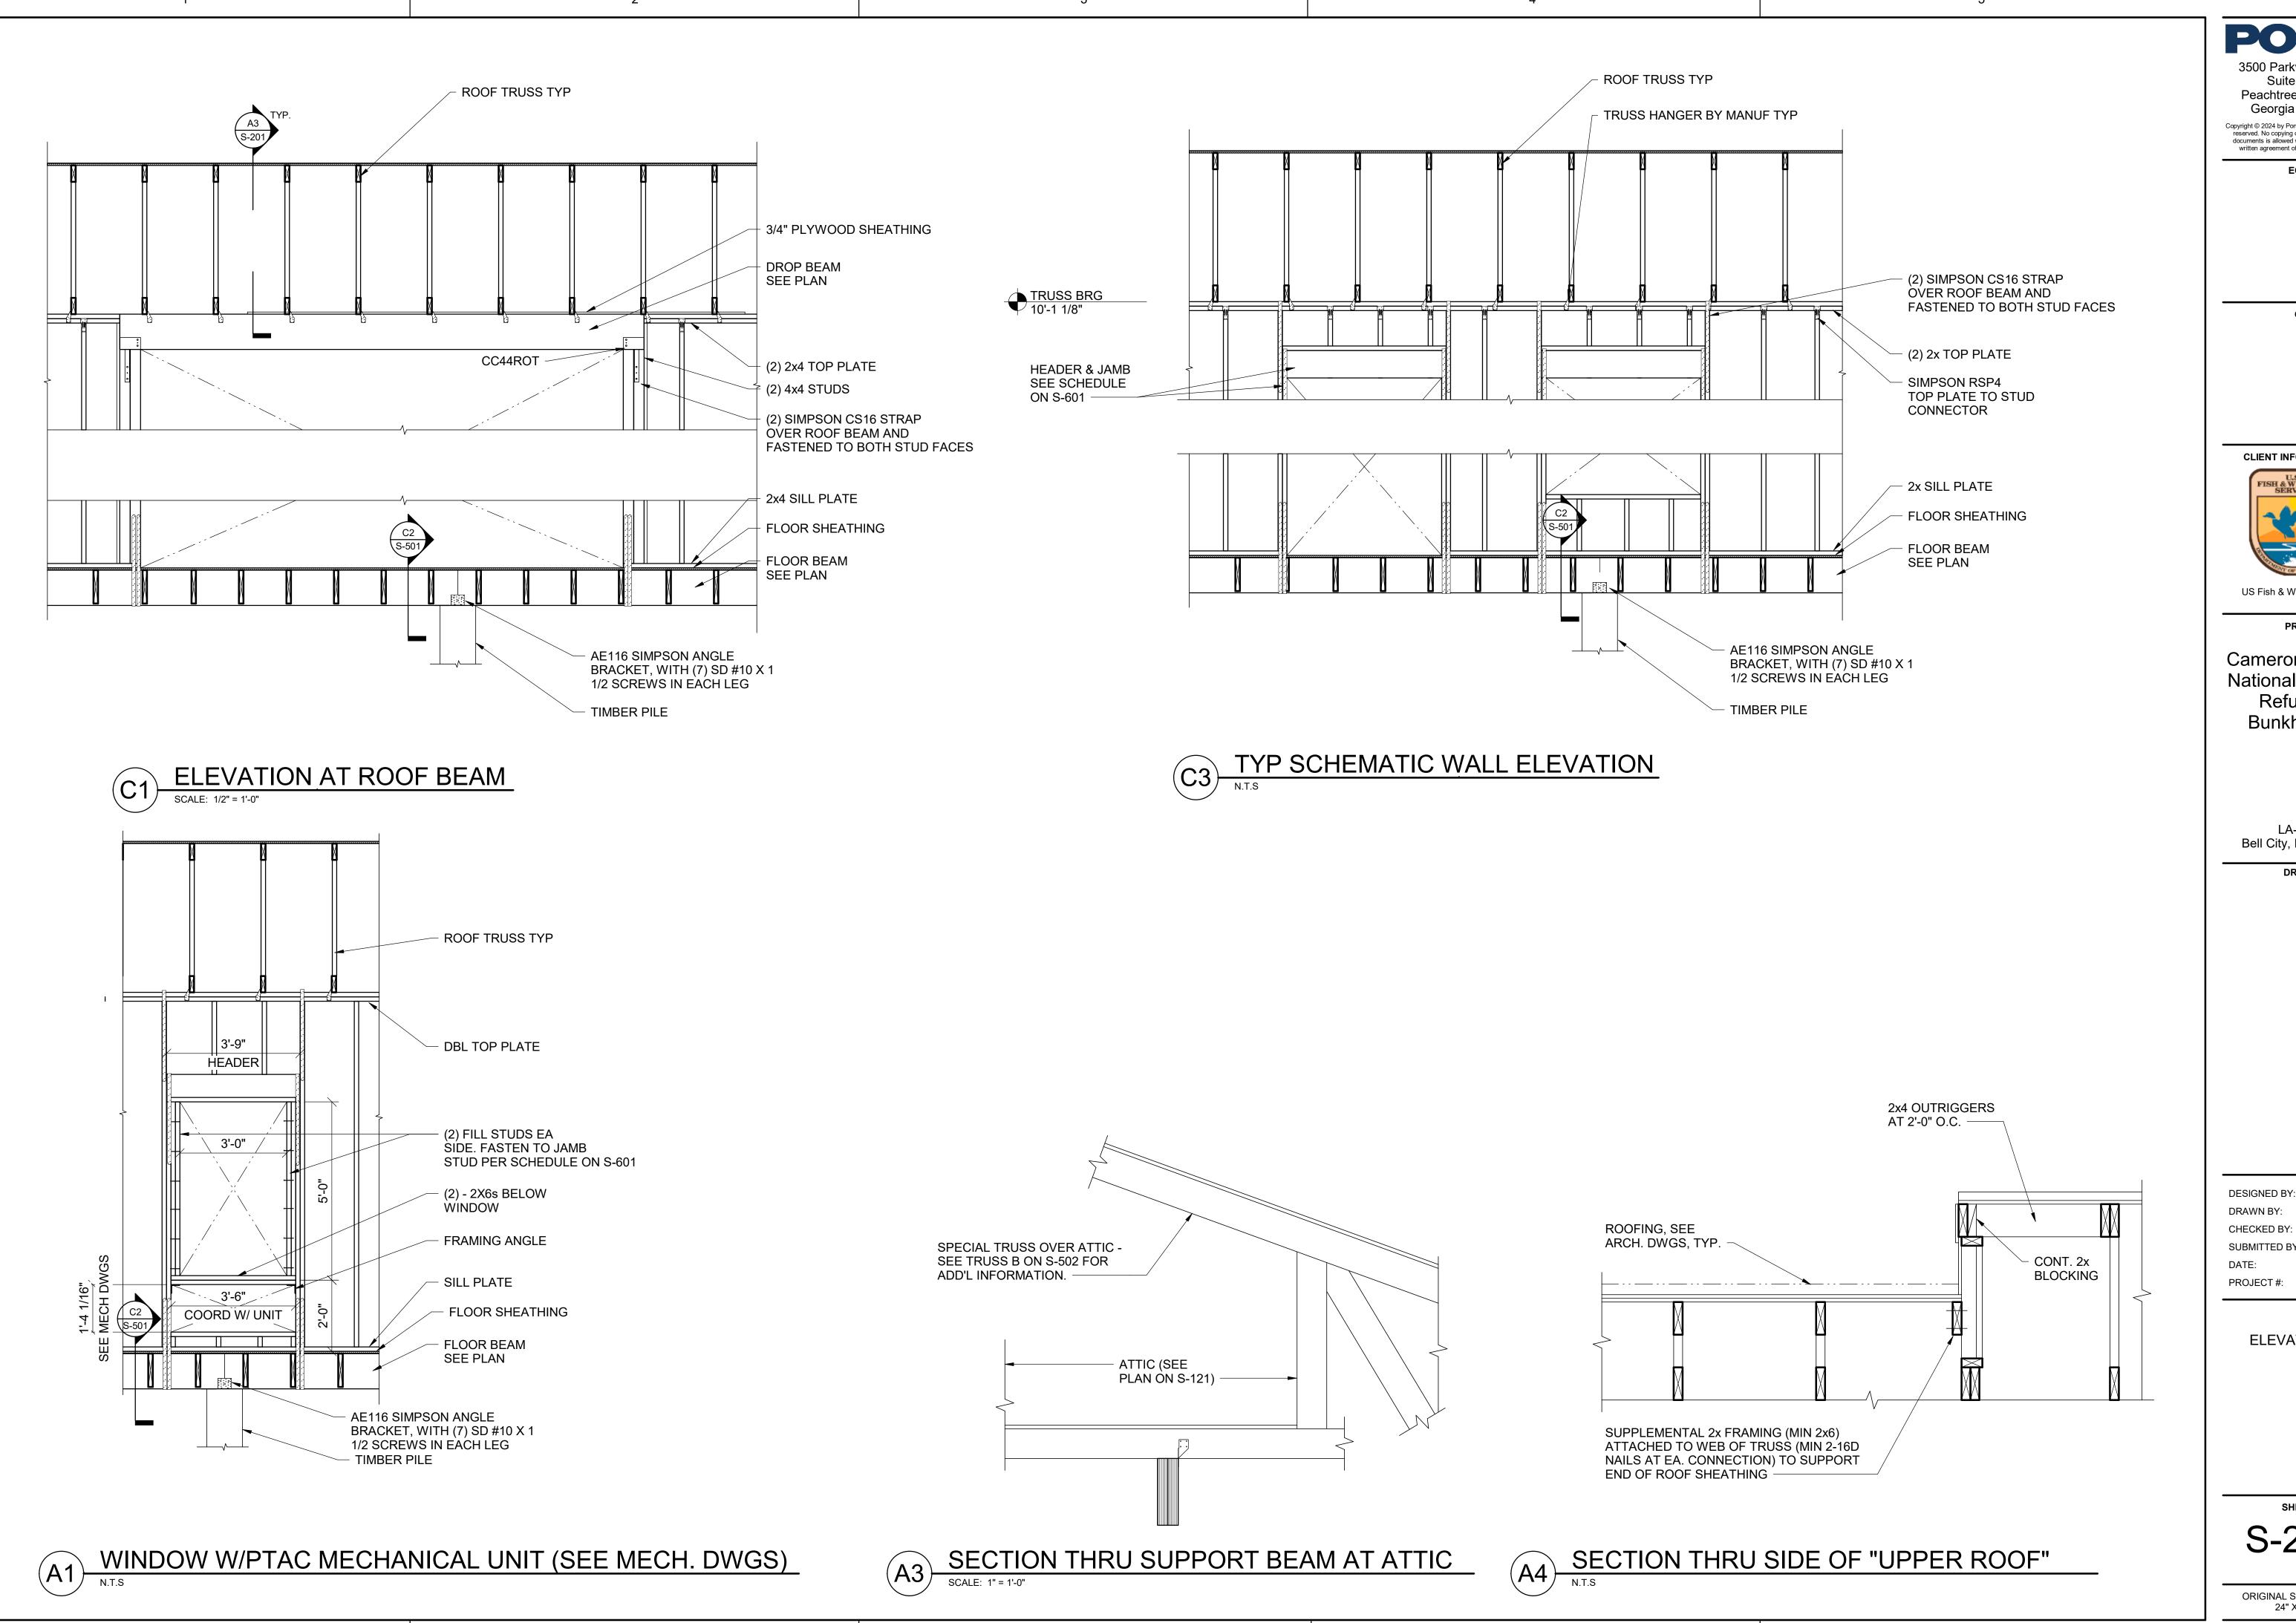


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DESIGNED BY: D. SKULLY DRAWN BY: D. SKULLY CHECKED BY: W. HAYNES SUBMITTED BY: C.CUSICK 02/12/2025


> SHEET TITLE **ELEVATIONS**

1220834

SHEET NUMBER S-201

ORIGINAL SHEET SIZE: 24" X 36"

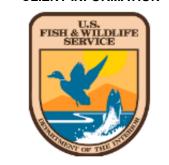100% ISSUED FOR CONSTRUCTION

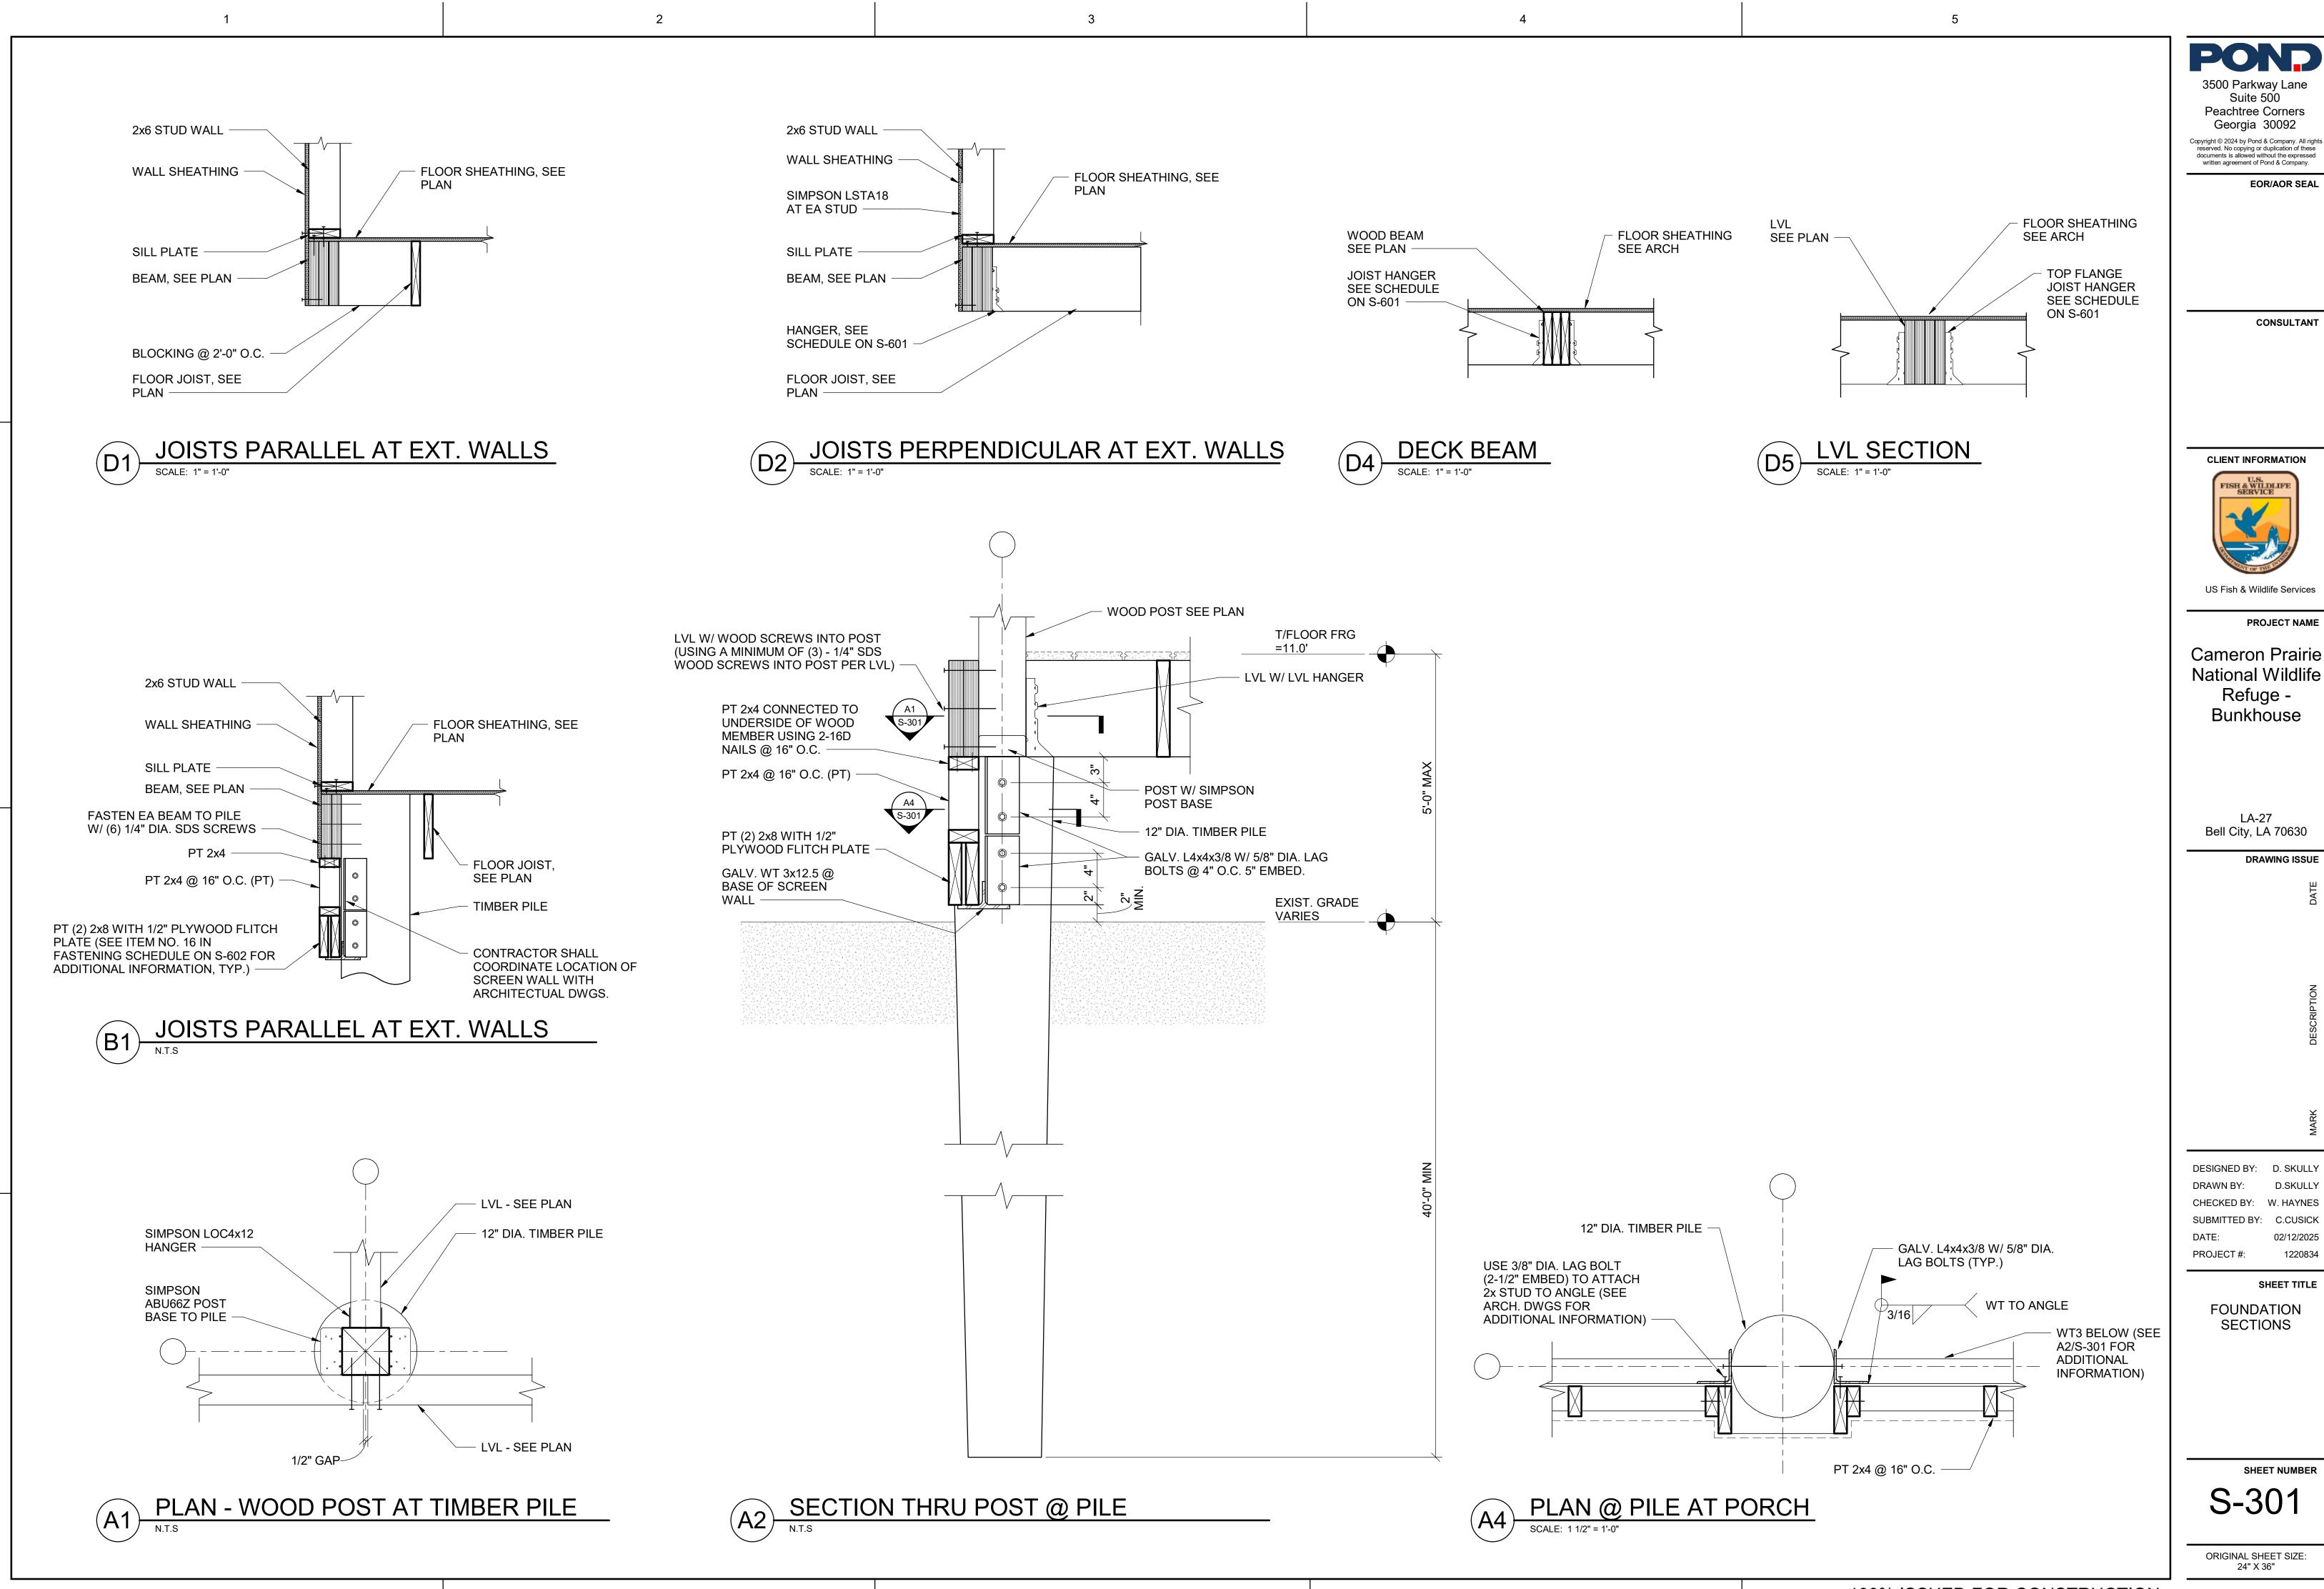

3500 Parkway Lane Suite 500 Peachtree Corners

Georgia 30092

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**EOR/AOR SEAL** 



US Fish & Wildlife Services

**PROJECT NAME** 

Cameron Prairie National Wildlife Refuge -Bunkhouse

LA-27 Bell City, LA 70630

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SHEET TITLE

1220834


FOUNDATION SECTIONS

SHEET NUMBER

S-301

ORIGINAL SHEET SIZE: 24" X 36"

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US Fish & Wildlife Services

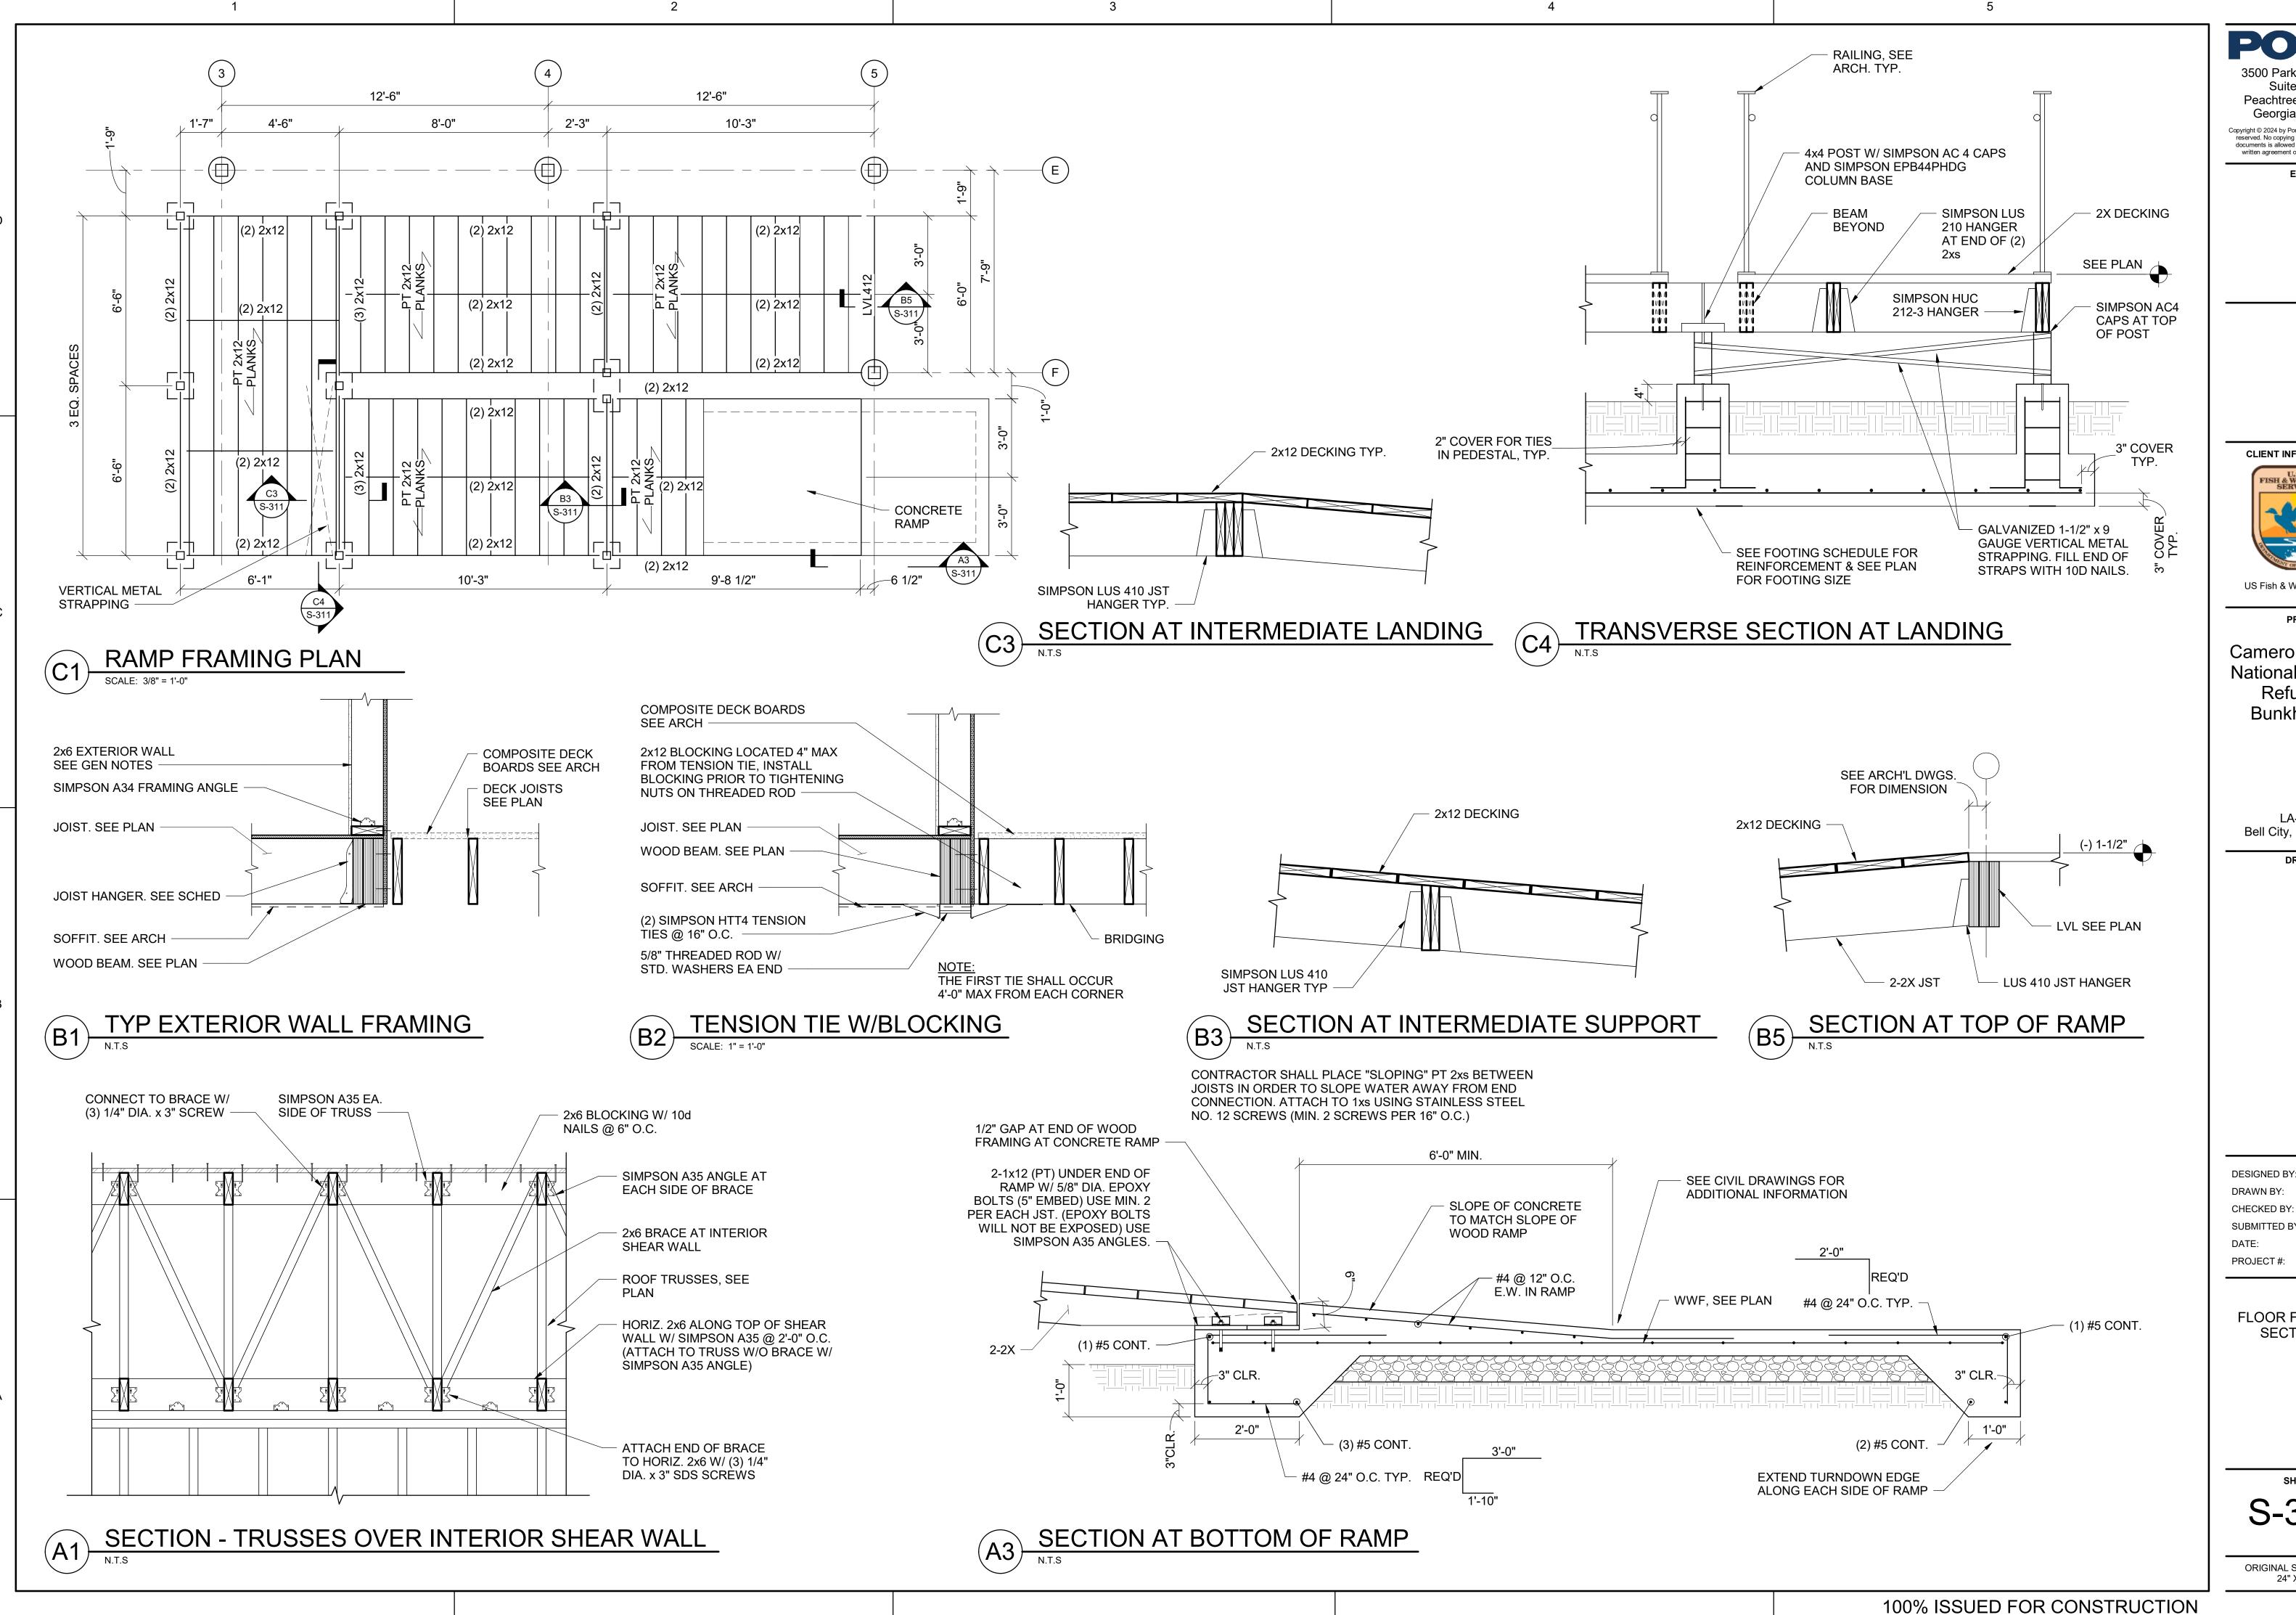**PROJECT NAME** 

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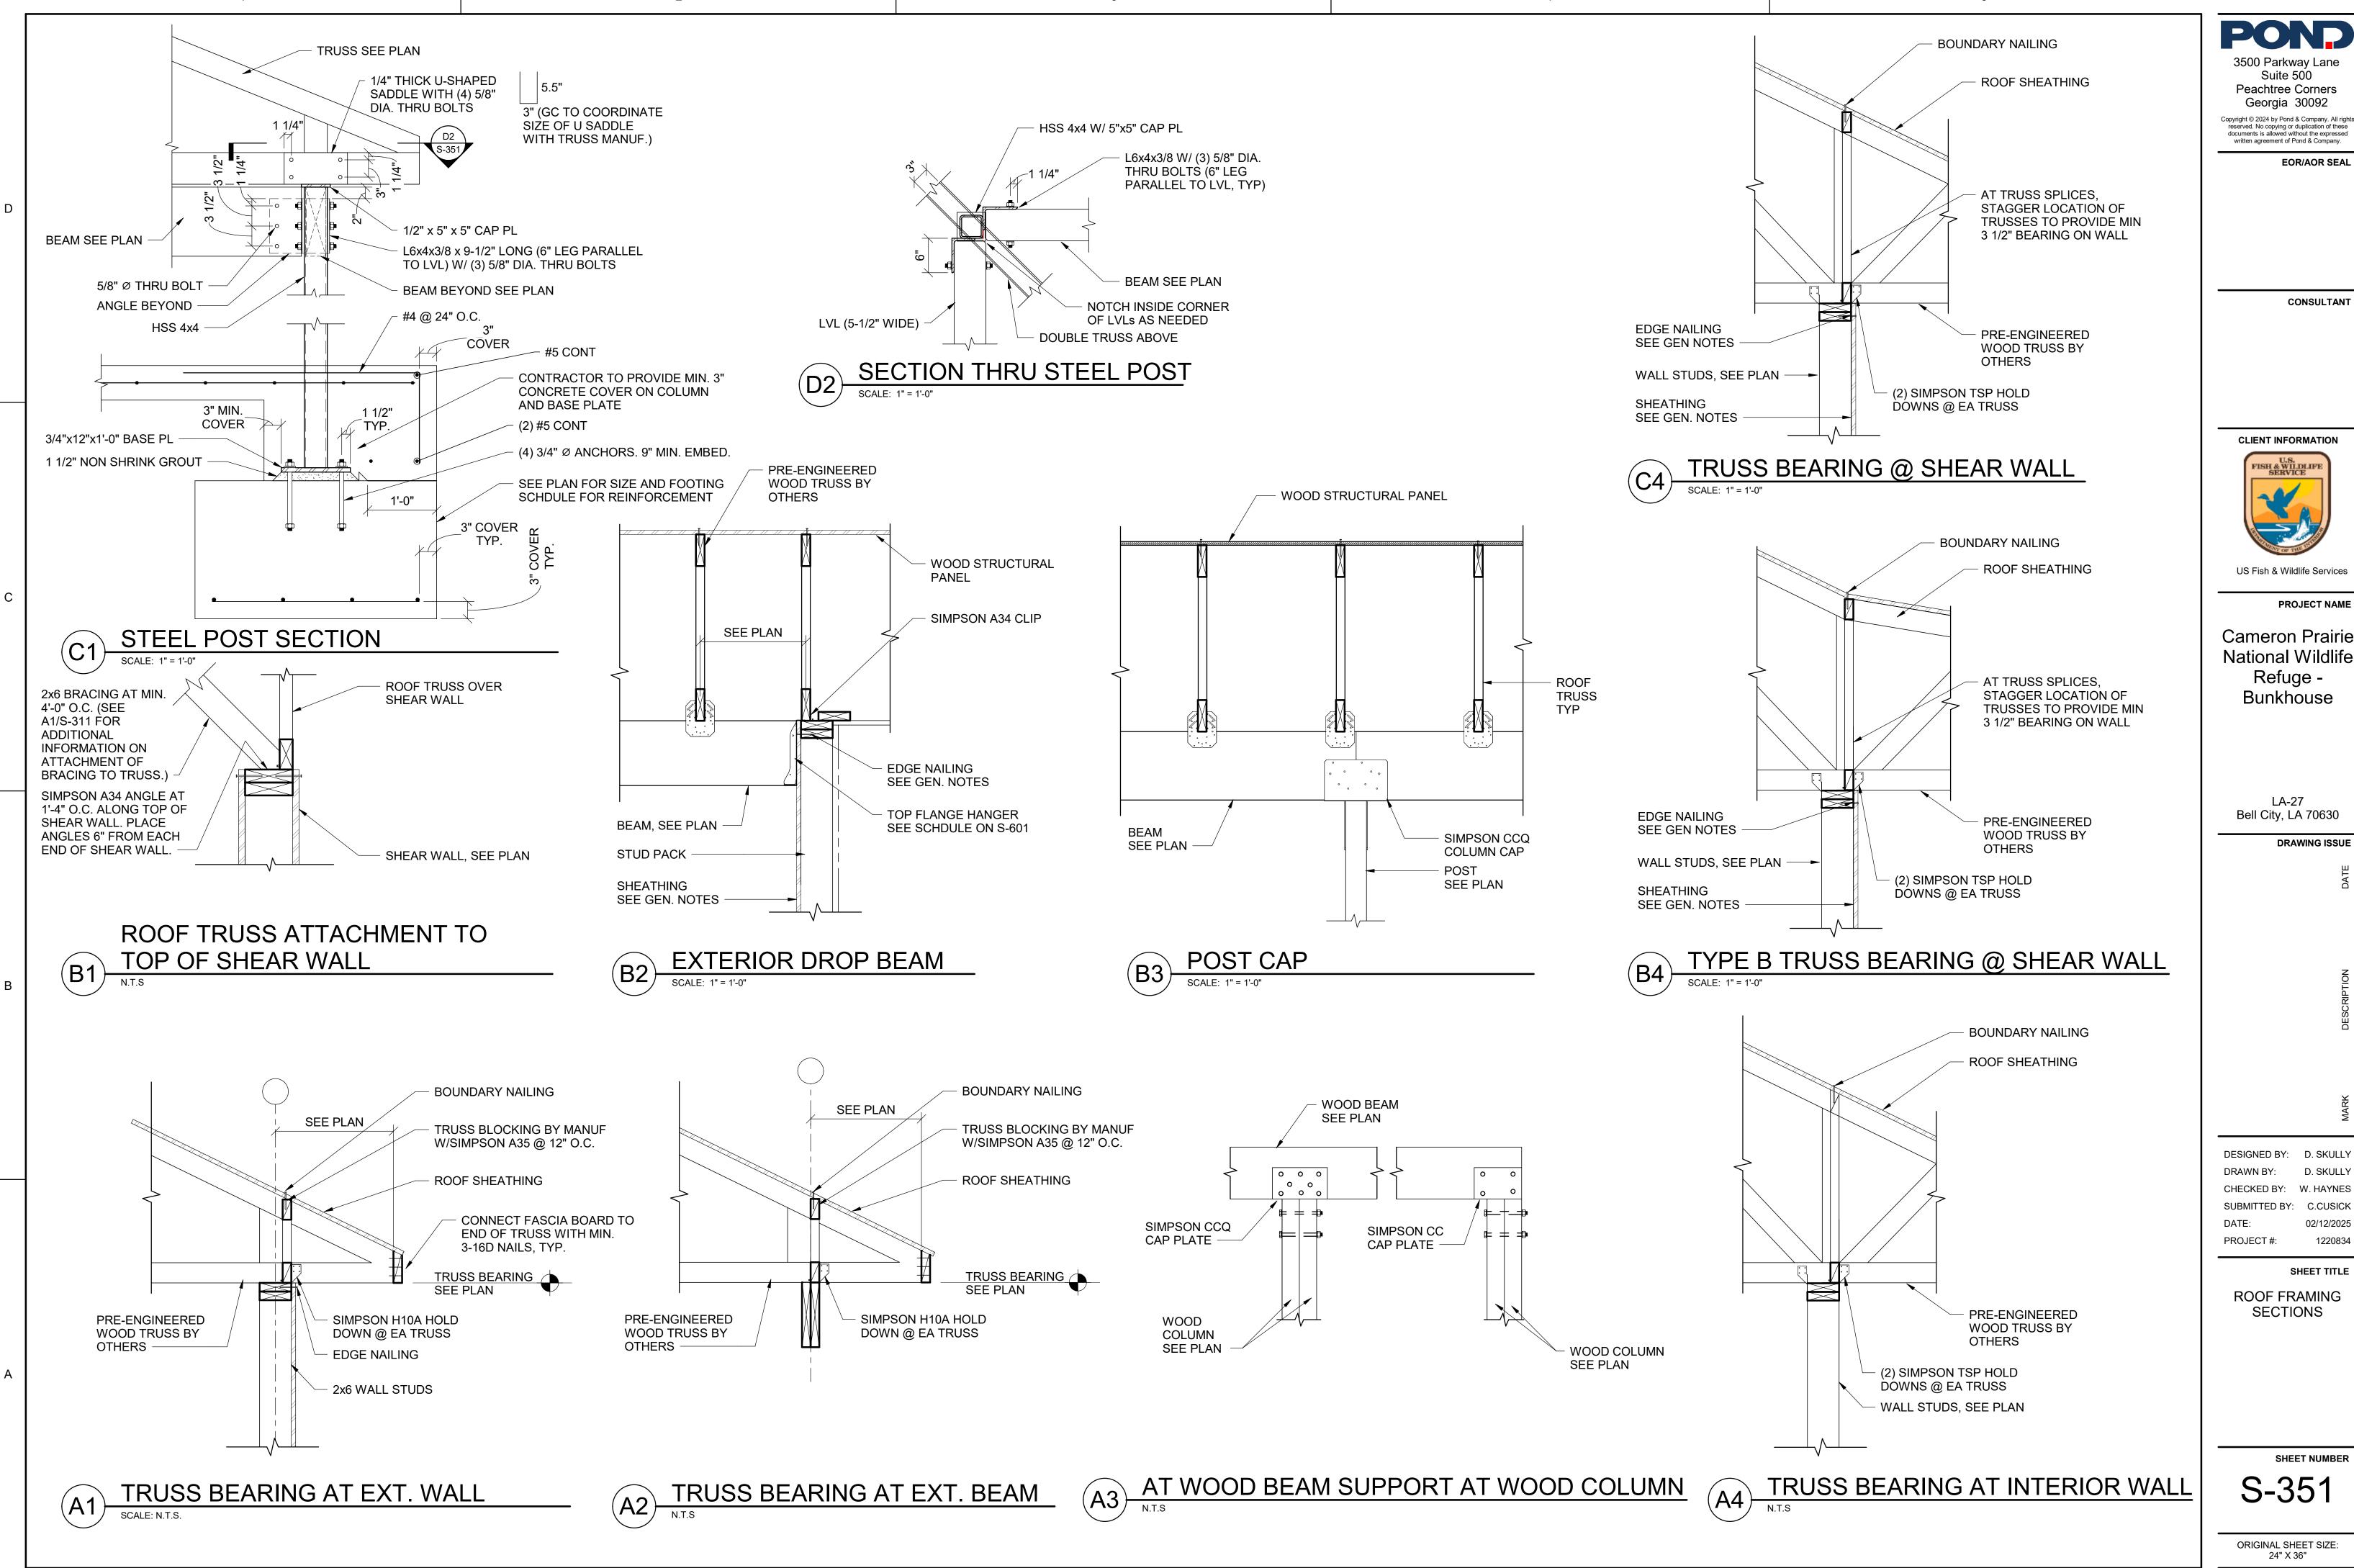
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SHEET TITLE

1220834

FLOOR FRAMING SECTIONS

SHEET NUMBER S-311



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Cameron Prairie National Wildlife Refuge -Bunkhouse

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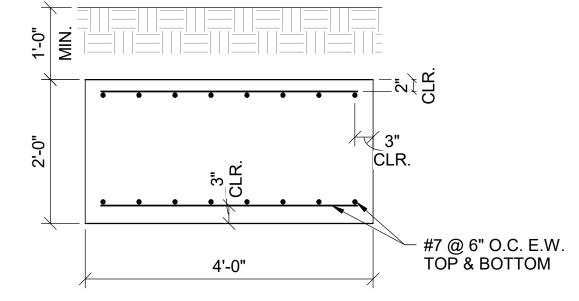
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SHEET TITLE

1220834


SECTIONS

S-351




# (C1) MECH. PLATFORM FOOTING SCALE: 3/4" = 1'-0"

PIER SCHEDULE					
PIER MARK	SIZE	REINFORCEMENT			
P-1	12" x 12"	(4) #5'S VERTICAL & #4 TIES @ 6" O.C.			
P-2	12" x 24"	(8) #5'S VERTICAL & 2 SETS OF #4 TIES @ 6" O.C.			
P-4	24" x 24"	(8) #7 W/ 3 SETS OF #4 TIES @ 6" O.C.			

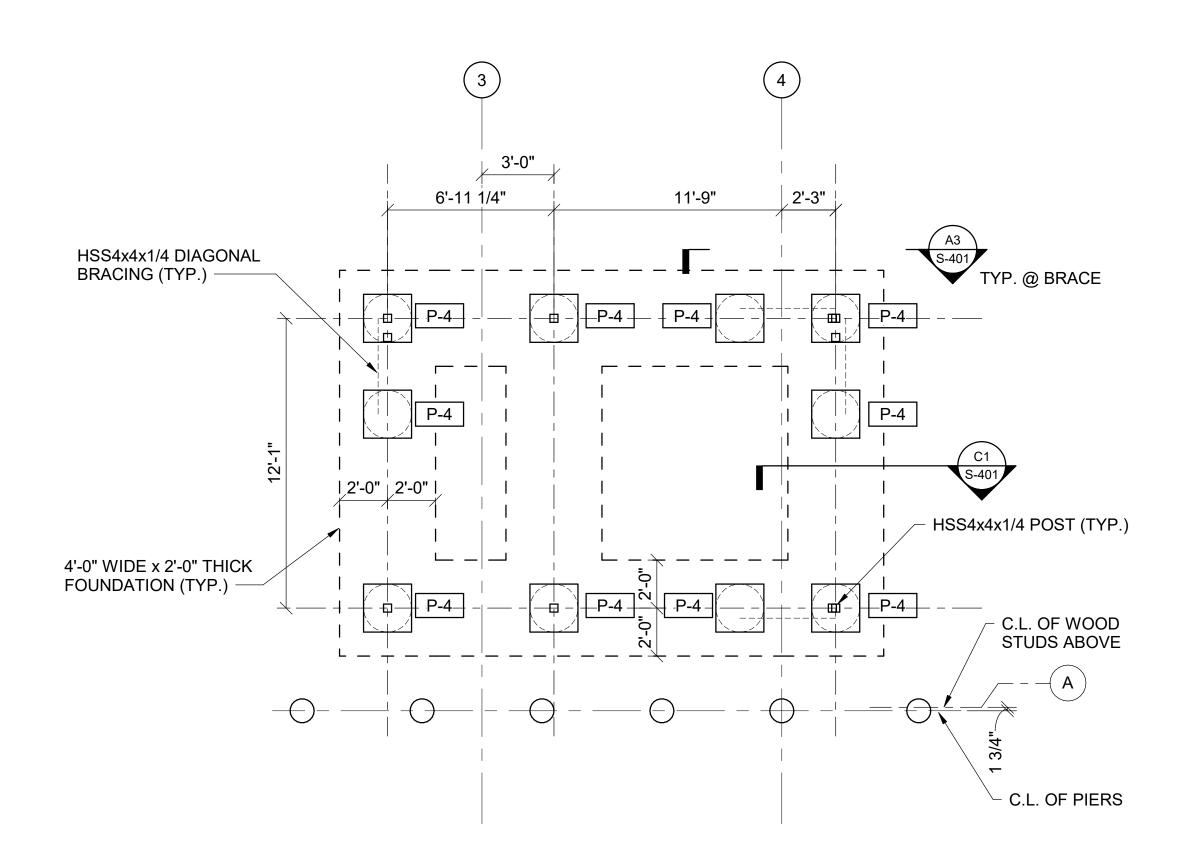


(A1) ELEVATED MECH. PLATFORM FOUNDATION PLAN

SCALE: 1/4" = 1'-0"

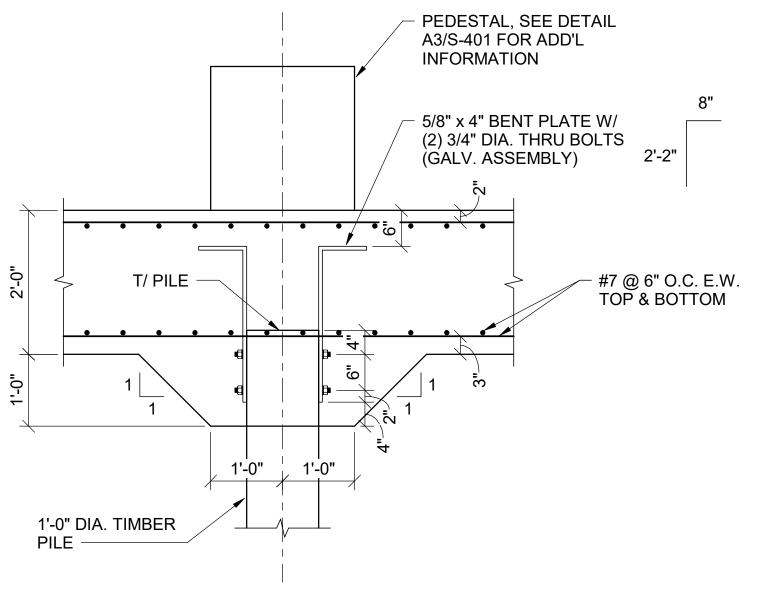

# C3 PILE ANCHOR TO FOOTING DETAIL

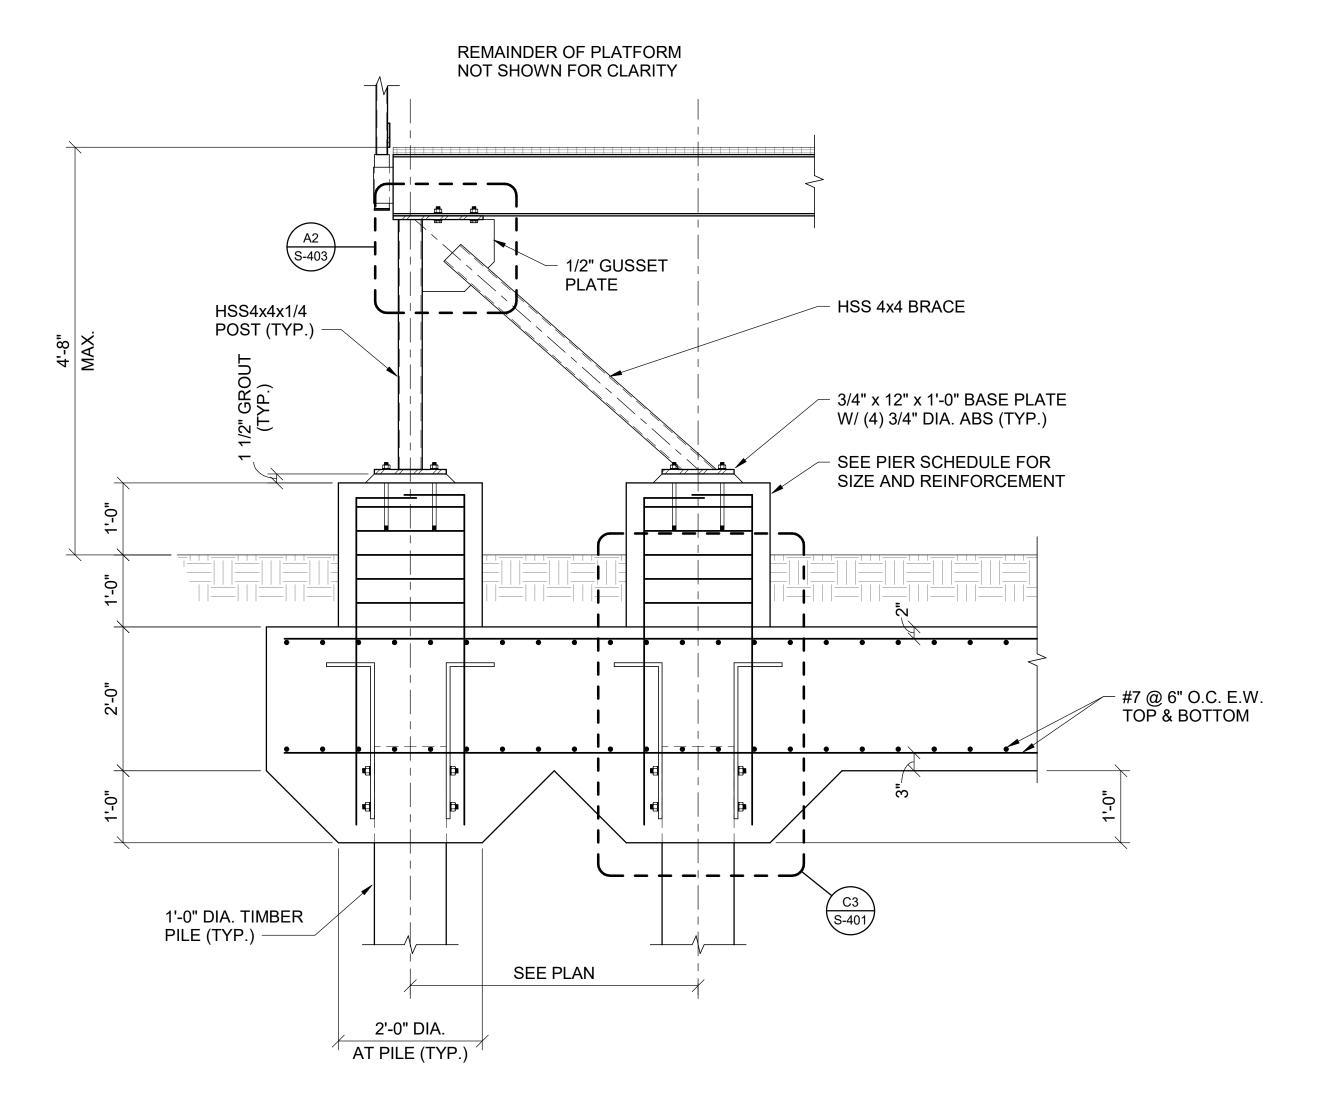

A3 SECTION AT PLATFORM FOUNDATION

N.T.S

0 2' 4' 8' SCALE: 1/4" = 1'-0" 3500 Parkway Lane Suite 500

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US Fish & Wildlife Services

PROJECT NAME

Cameron Prairie National Wildlife Refuge -Bunkhouse

> LA-27 Bell City, LA 70630

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DESCRIP1

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DRAWN BY: D. SKULLY
CHECKED BY: W. HAYNES
SUBMITTED BY: C.CUSICK

SHEET TITLE


PROJECT #:

02/12/2025

ELEVATED MECH.
PLATFORM
FOUNDATION
PLAN & DETAILS

SHEET NUM

S-401

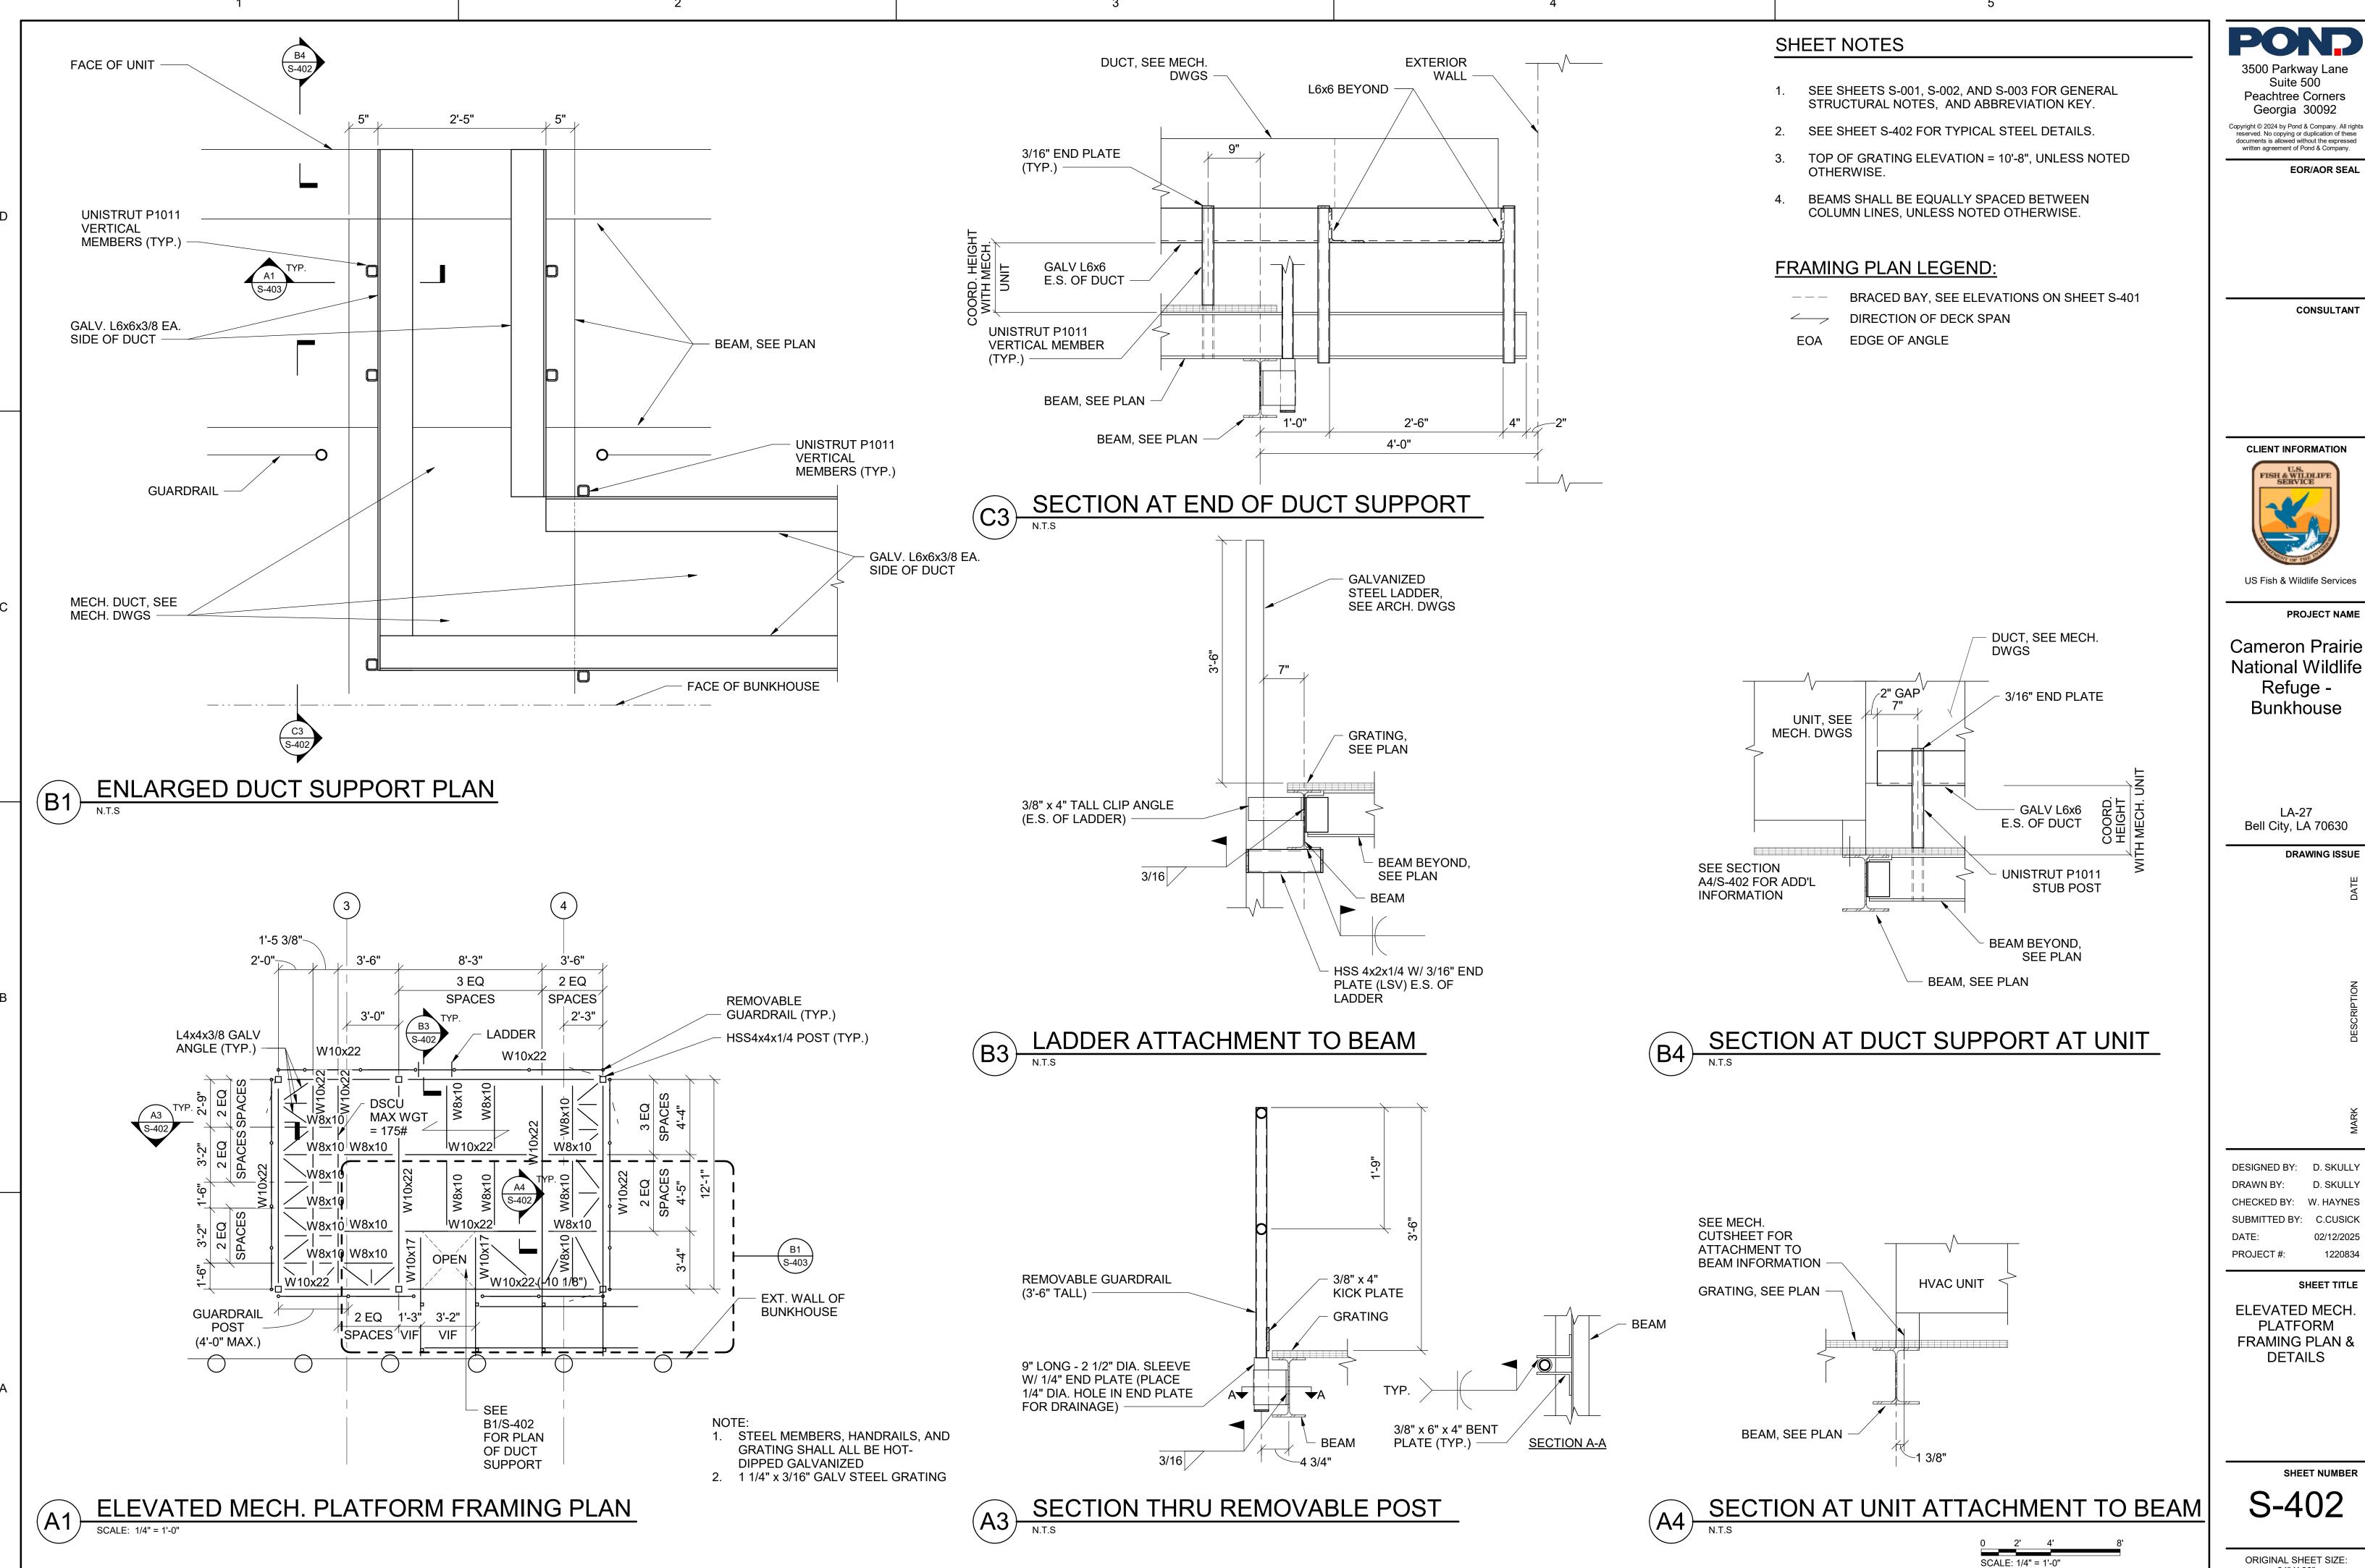

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LA-27 Bell City, LA 70630

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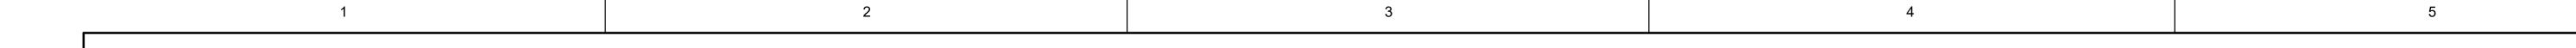
SHEET TITLE

1220834

ELEVATED MECH. PLATFORM FRAMING PLAN & **DETAILS** 

SHEET NUMBER

S-402



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PROJECT NAME

Cameron Prairie National Wildlife Refuge -Bunkhouse

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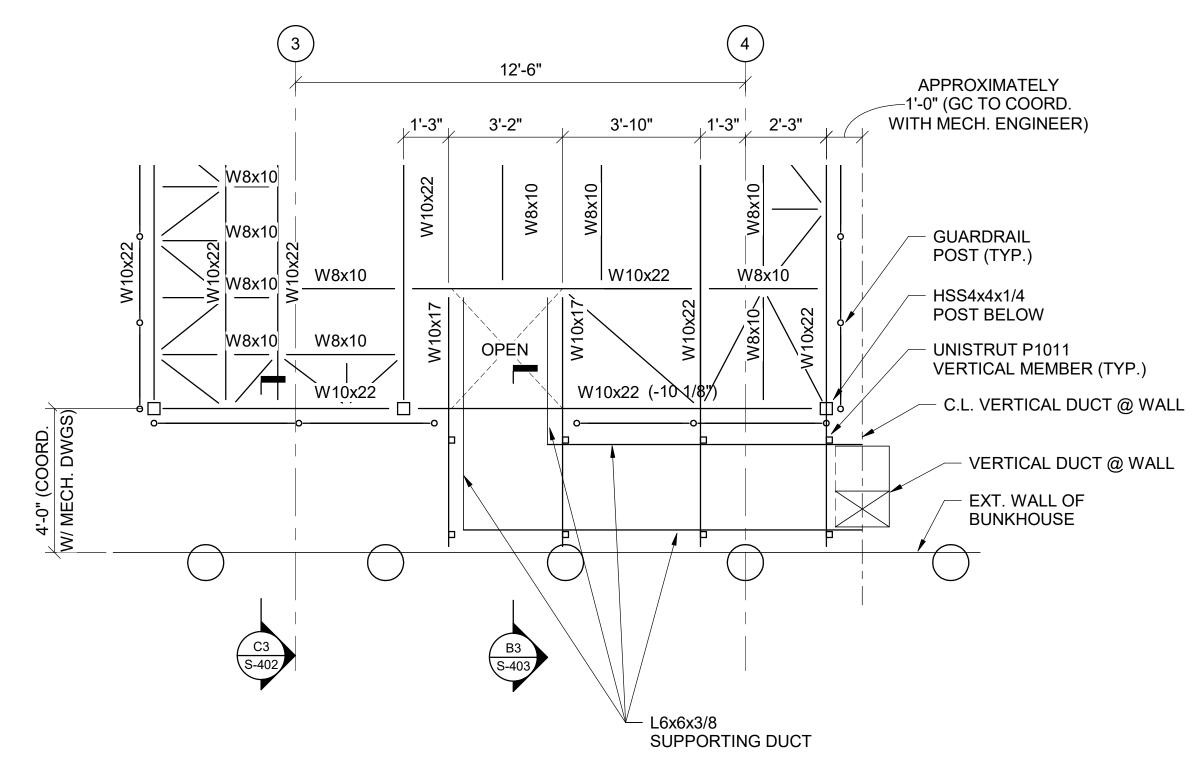
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CHECKED BY: W. HAYNES
SUBMITTED BY: C.CUSICK
DATE: 02/12/2025
PROJECT #: 1220834

SHEET TITLE

ELEVATED MECH.
PLATFORM
FRAMING DETAILS

S-403

ORIGINAL SHEET SIZE: 24" X 36"



BEAM, SEE PLAN

4'-0"

SECTION THRU DUCT SUPPORT

N.T.S

DUCT, SEE MECH.

3/16" END PLATE

BEAM, SEE PLAN -

DWGS

**EXTERIOR** 


WALL

UNISTRUT P1011

VERTICAL MEMBER

B1 PARTIAL PLAN OF PLATFORM - DUCT SUPPORT

SCALE: 3/8" = 1'-0"

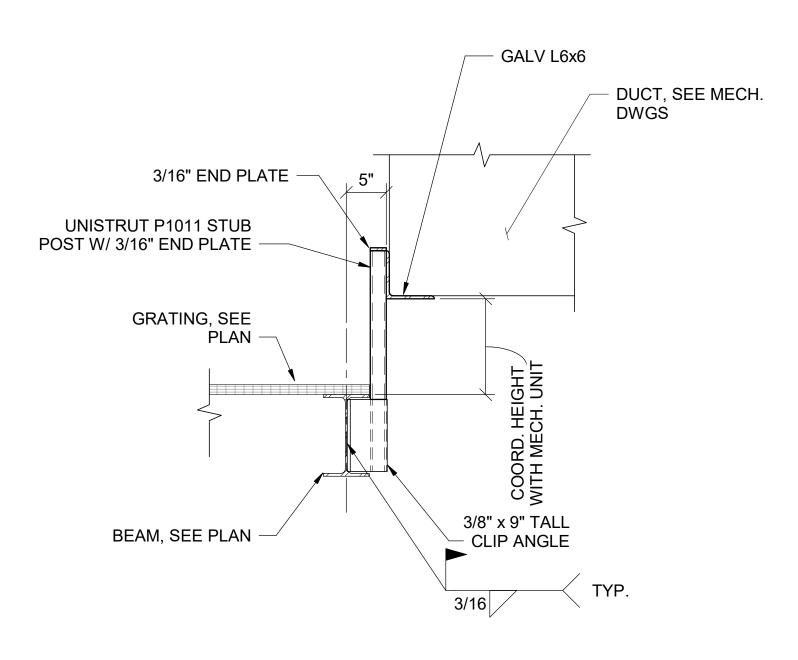

AS REQ'D

(1'-0" MIN.)

5/8" x 6" x 1'-3" CAP PLATE

WITH 4 - 5/8" A325 BOLTS

TYP.

3/16 6


HSS4x4x1/4


POST (TYP.)

A1 SECTION THRU DUCT SUPPORT


(A2) VERTICAL BRACING DETAIL

N.T.S

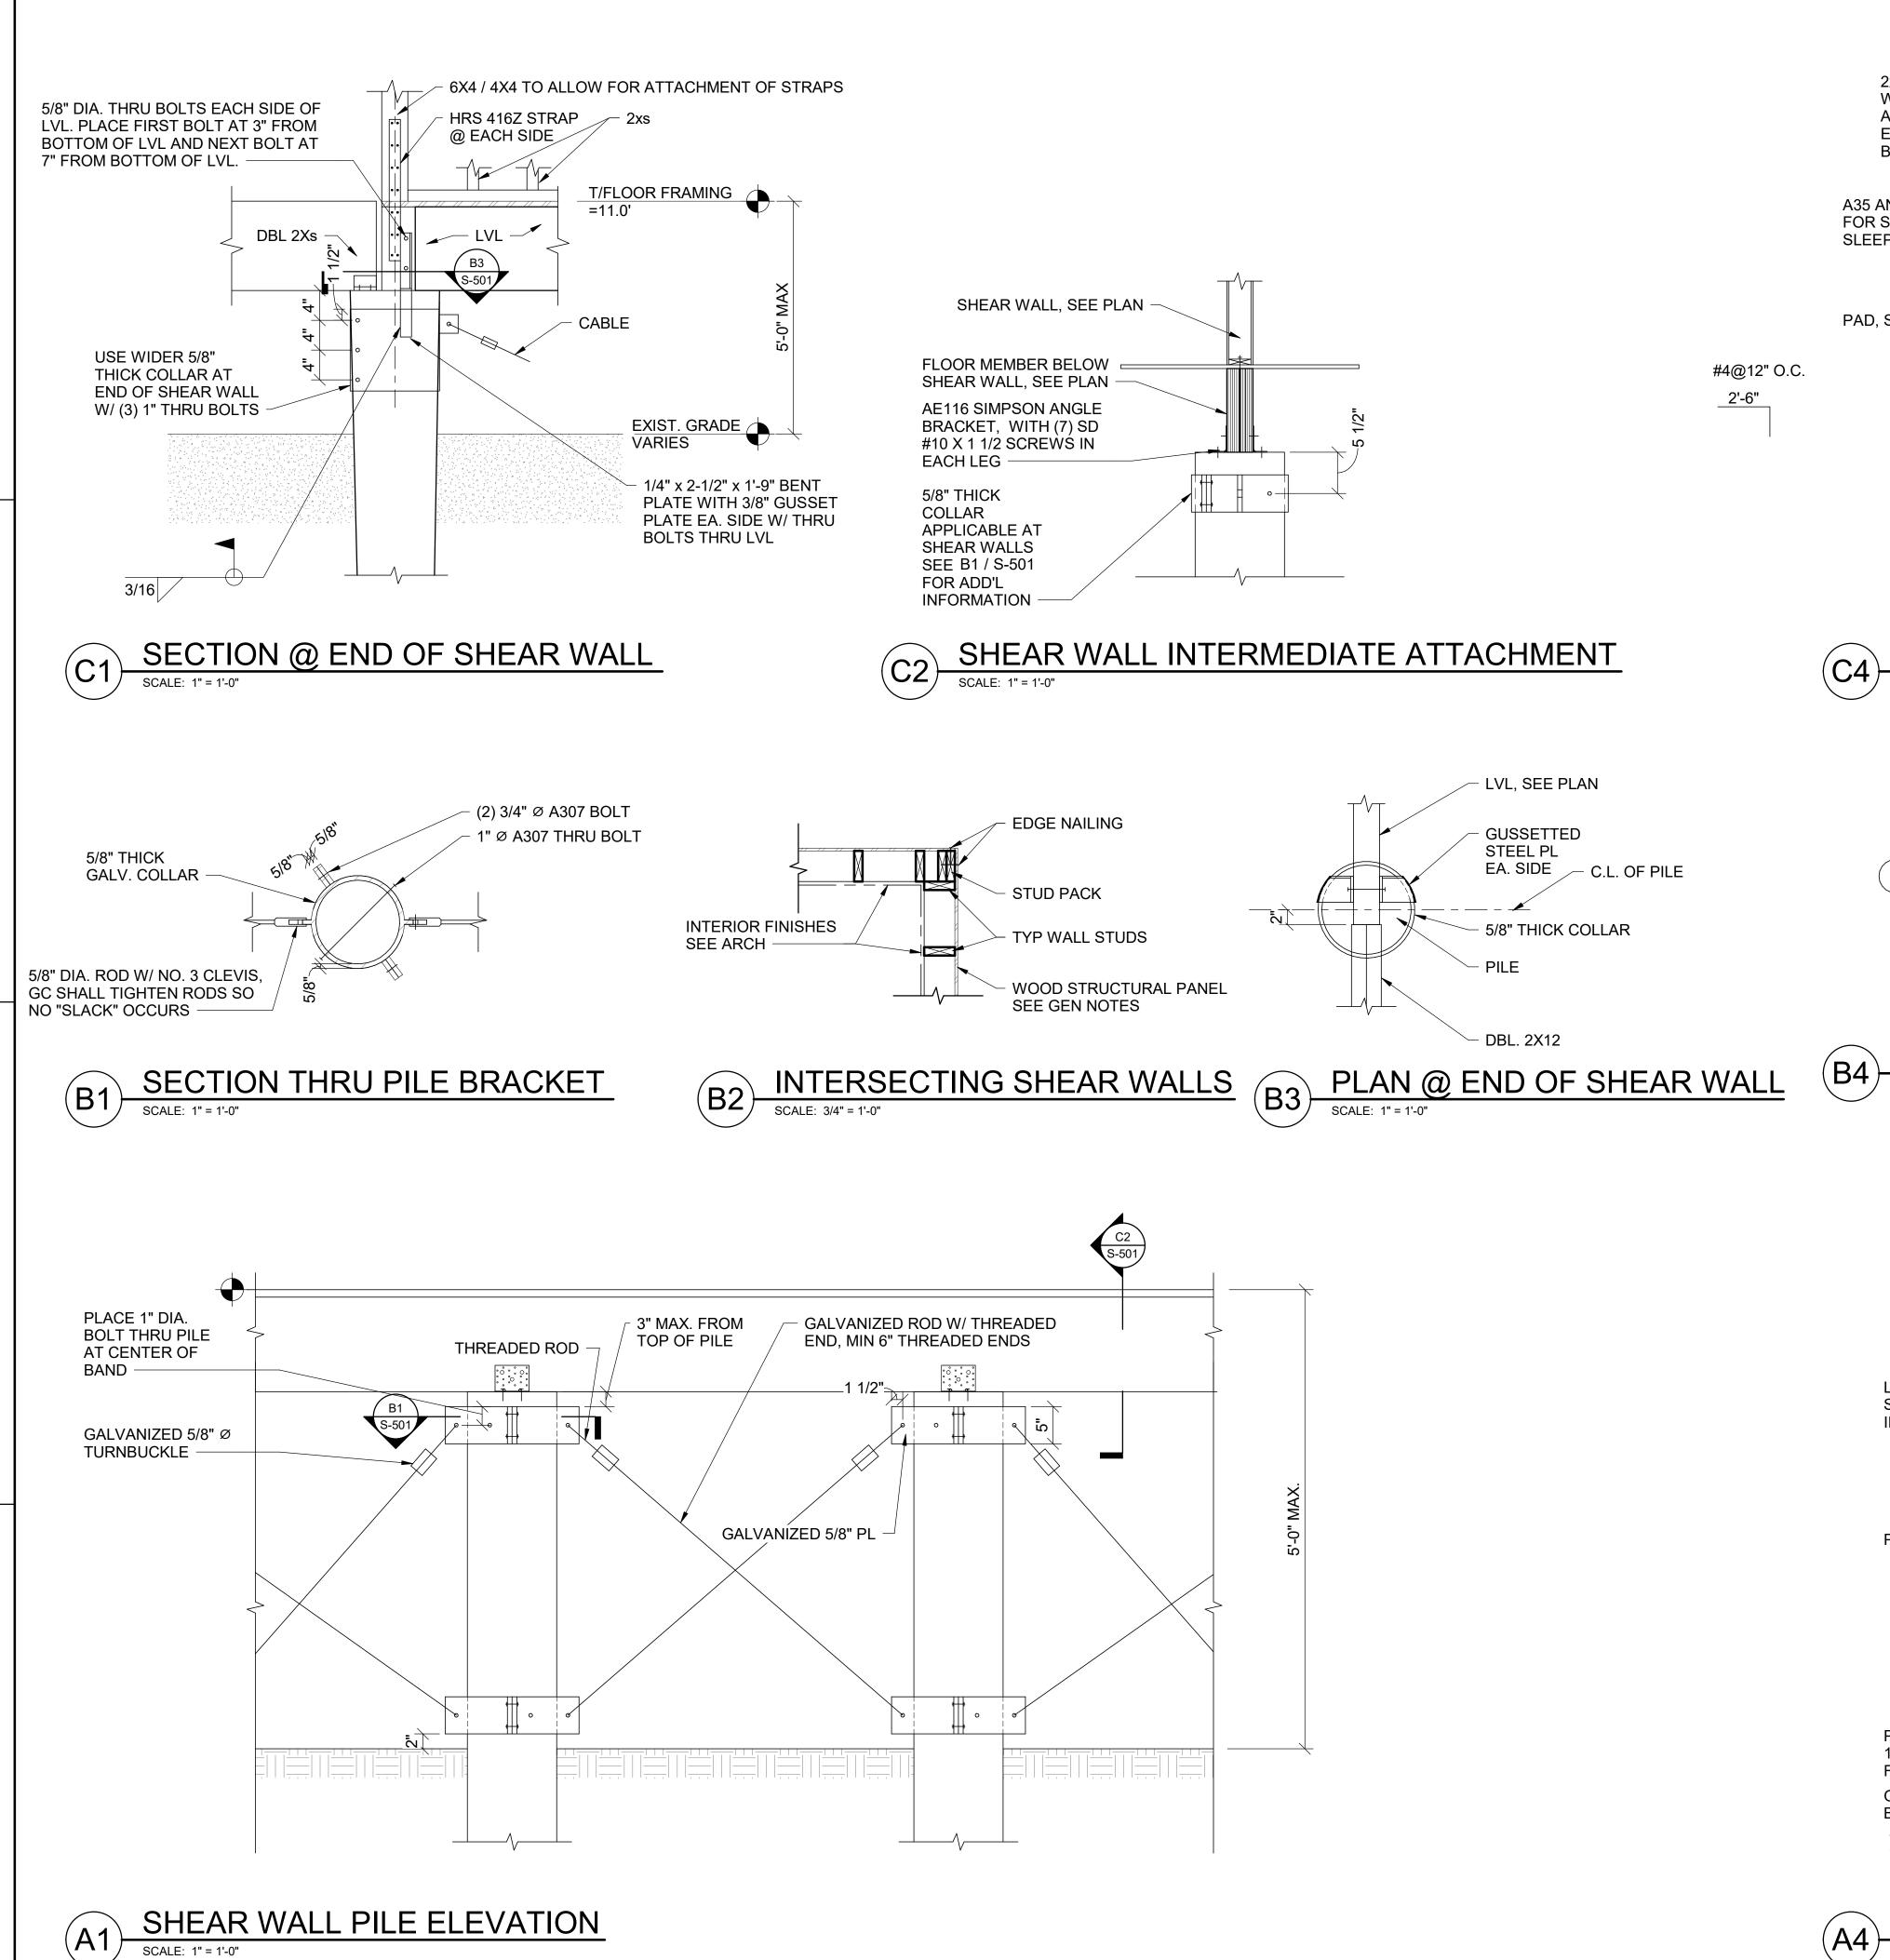

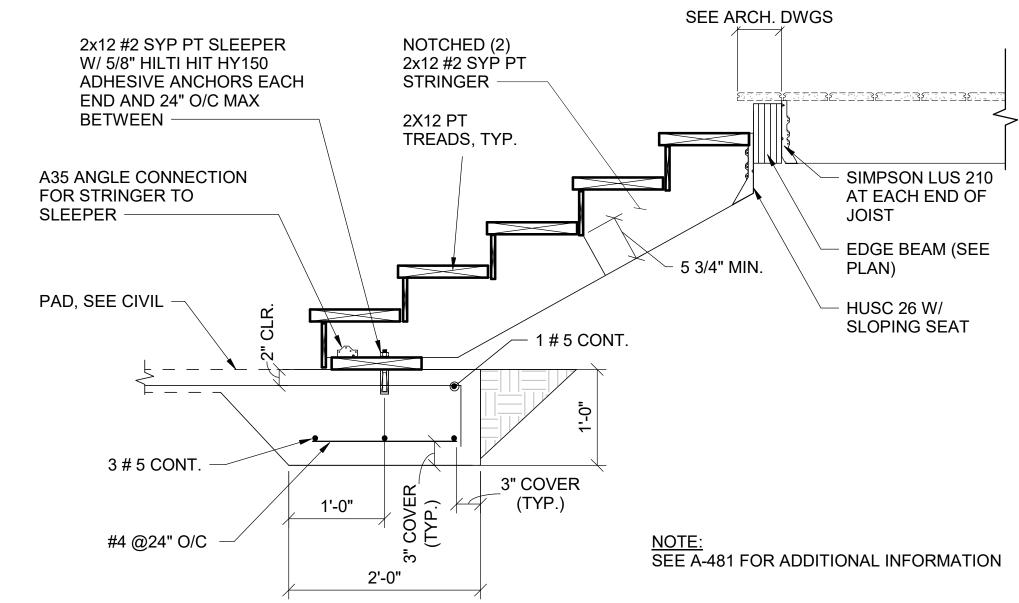




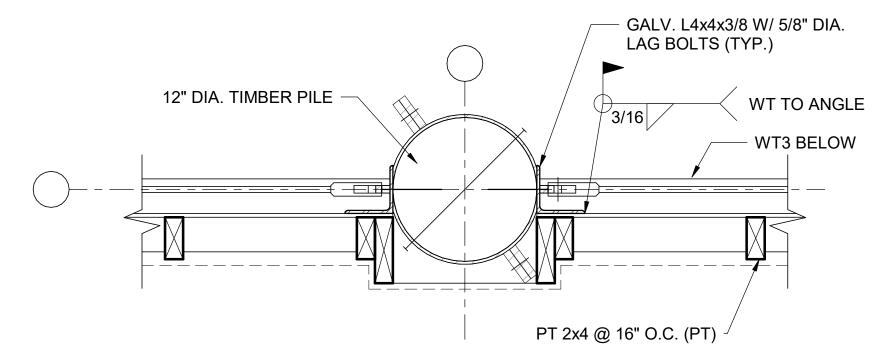

PLAN @ PILE AT PORCH SHEAR WALL

SCALE: 1 1/2" = 1'-0"

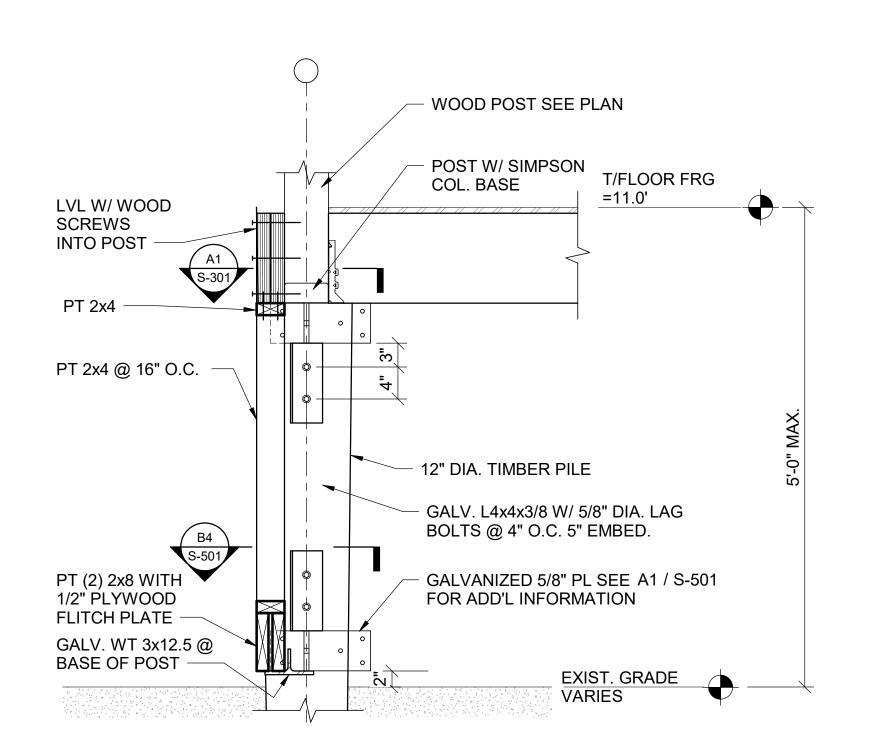

SECTION THRU POST SHEAR WALL @ PILE

ORIGINAL SHEET SIZE:

100% ISSUED FOR CONSTRUCTION

SCALE: 3/4" = 1'-0"

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US Fish & Wildlife Services

**PROJECT NAME** 

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LA-27 Bell City, LA 70630 **DRAWING ISSUE** 

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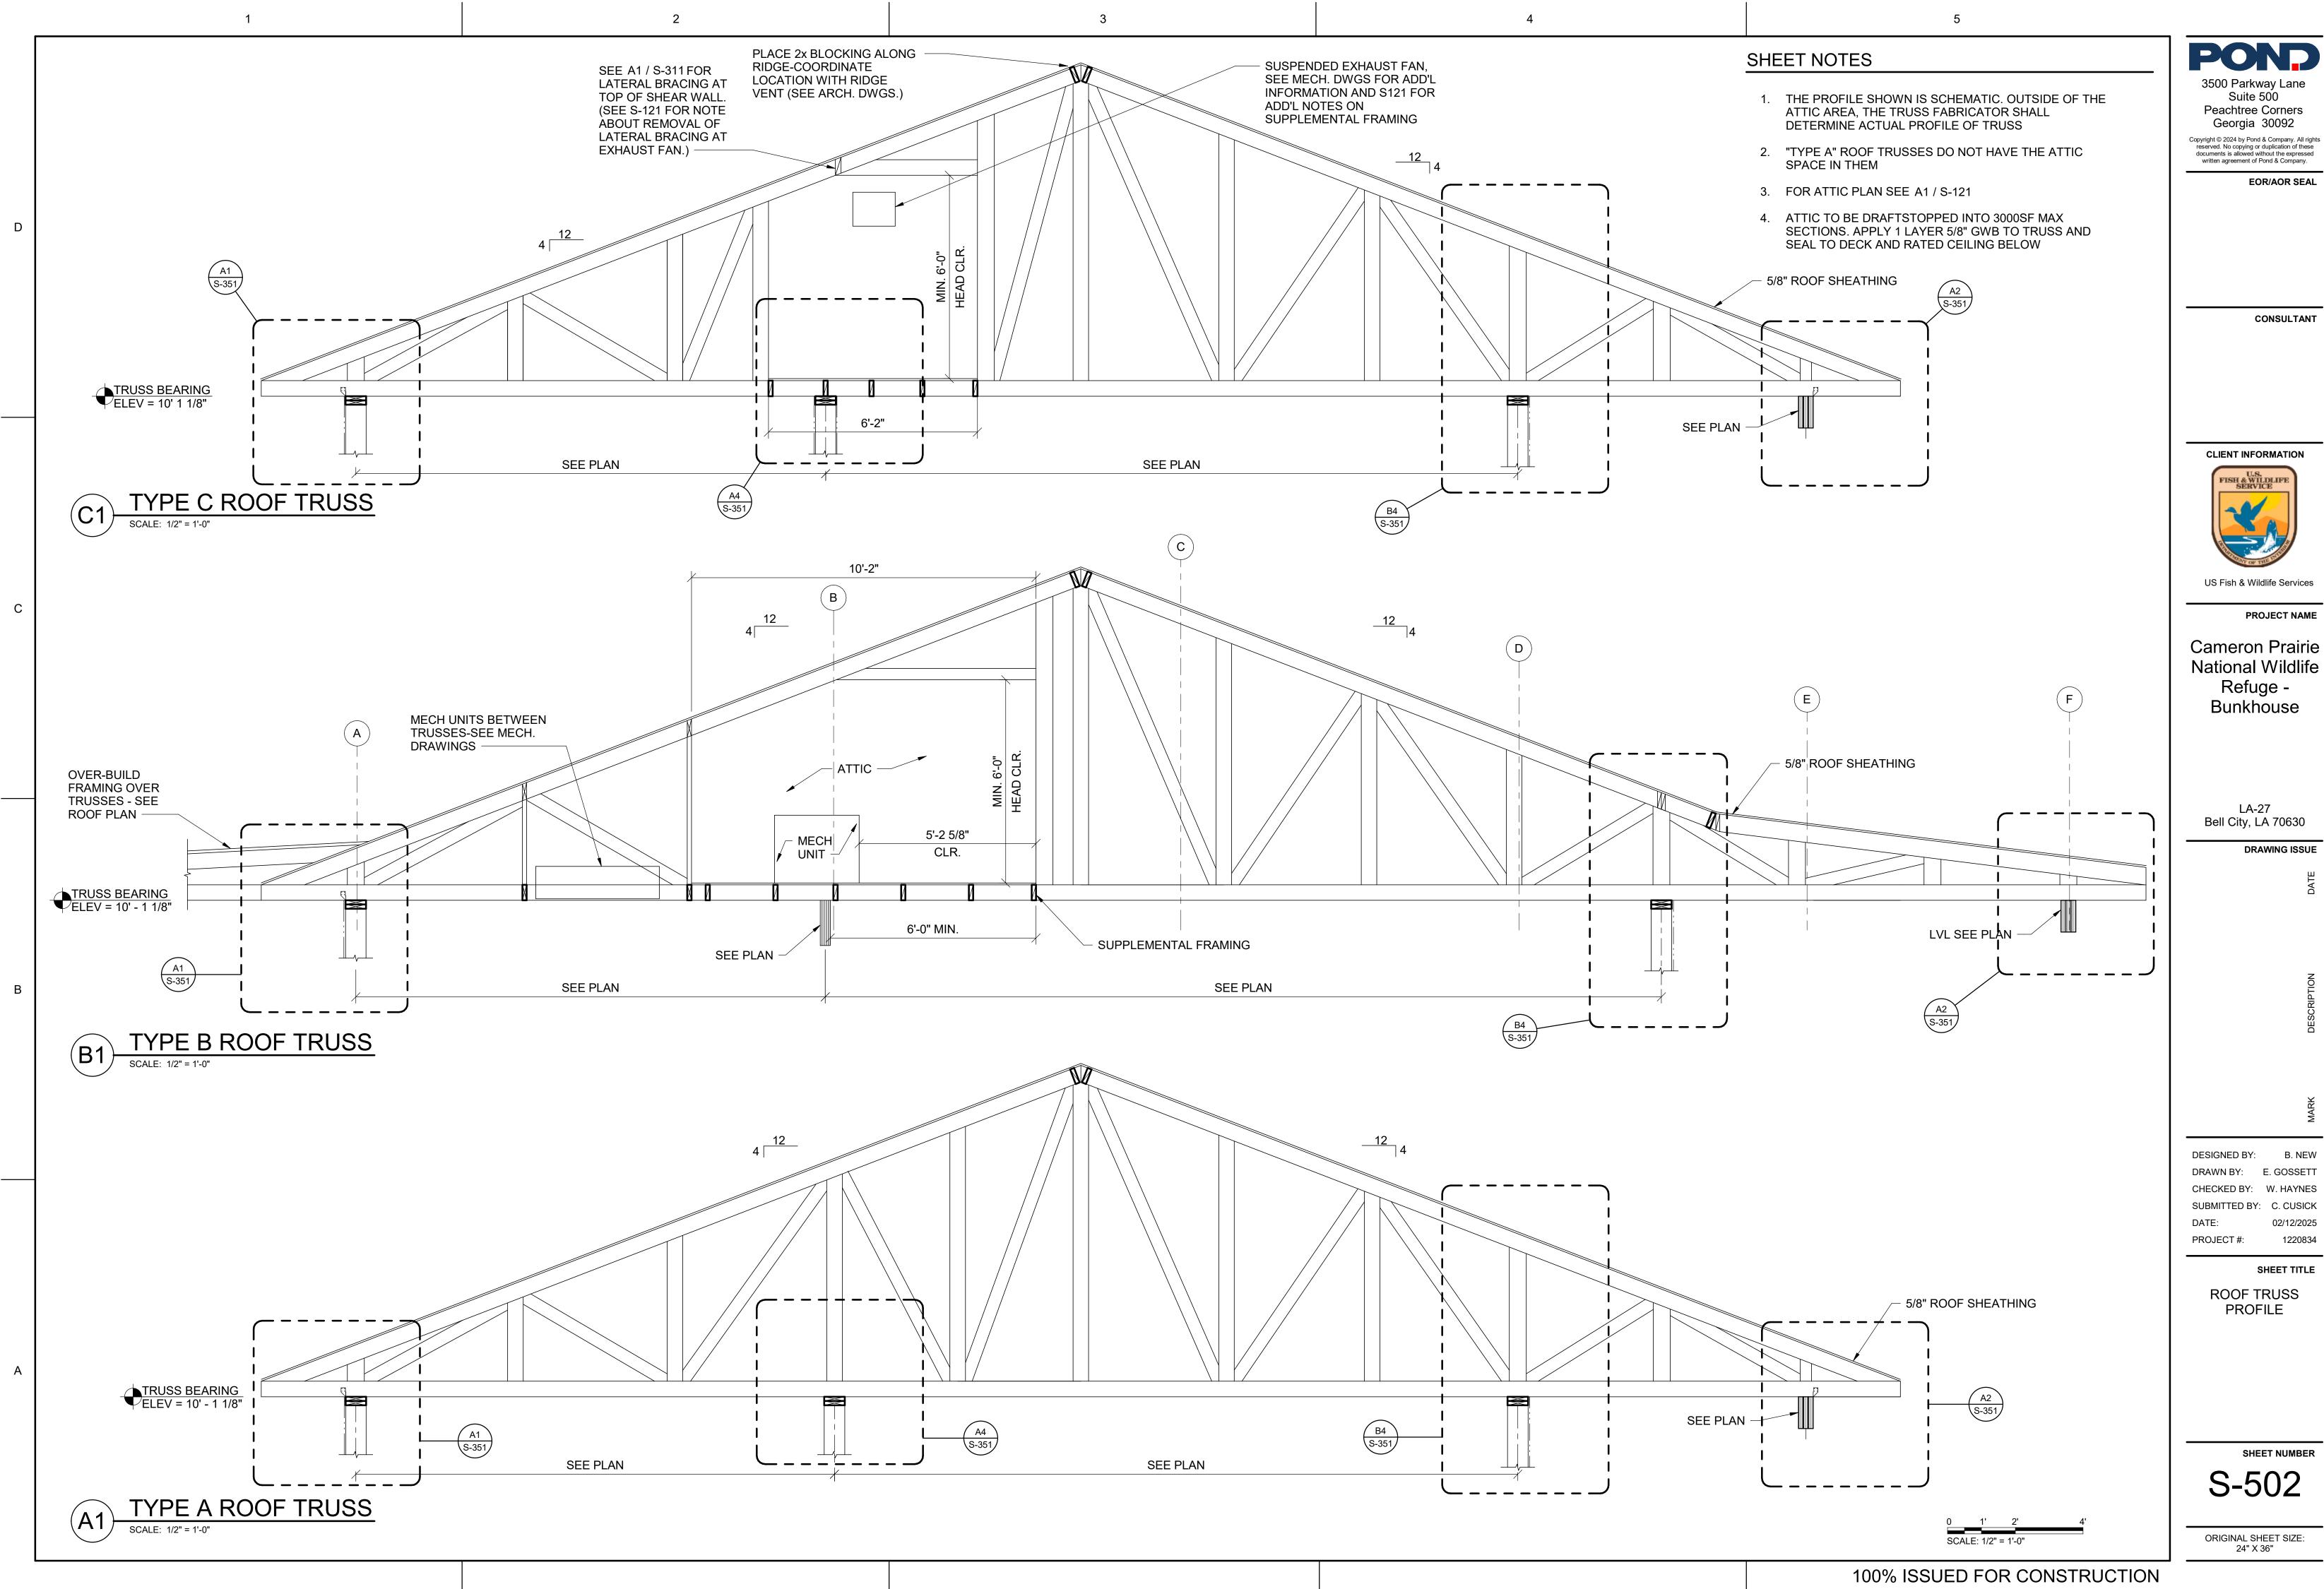
1220834

STRUCTURAL DETAILS

PROJECT #:

S-501

24" X 36"



3500 Parkway Lane


Peachtree Corners



US Fish & Wildlife Services

02/12/2025

SHEET TITLE

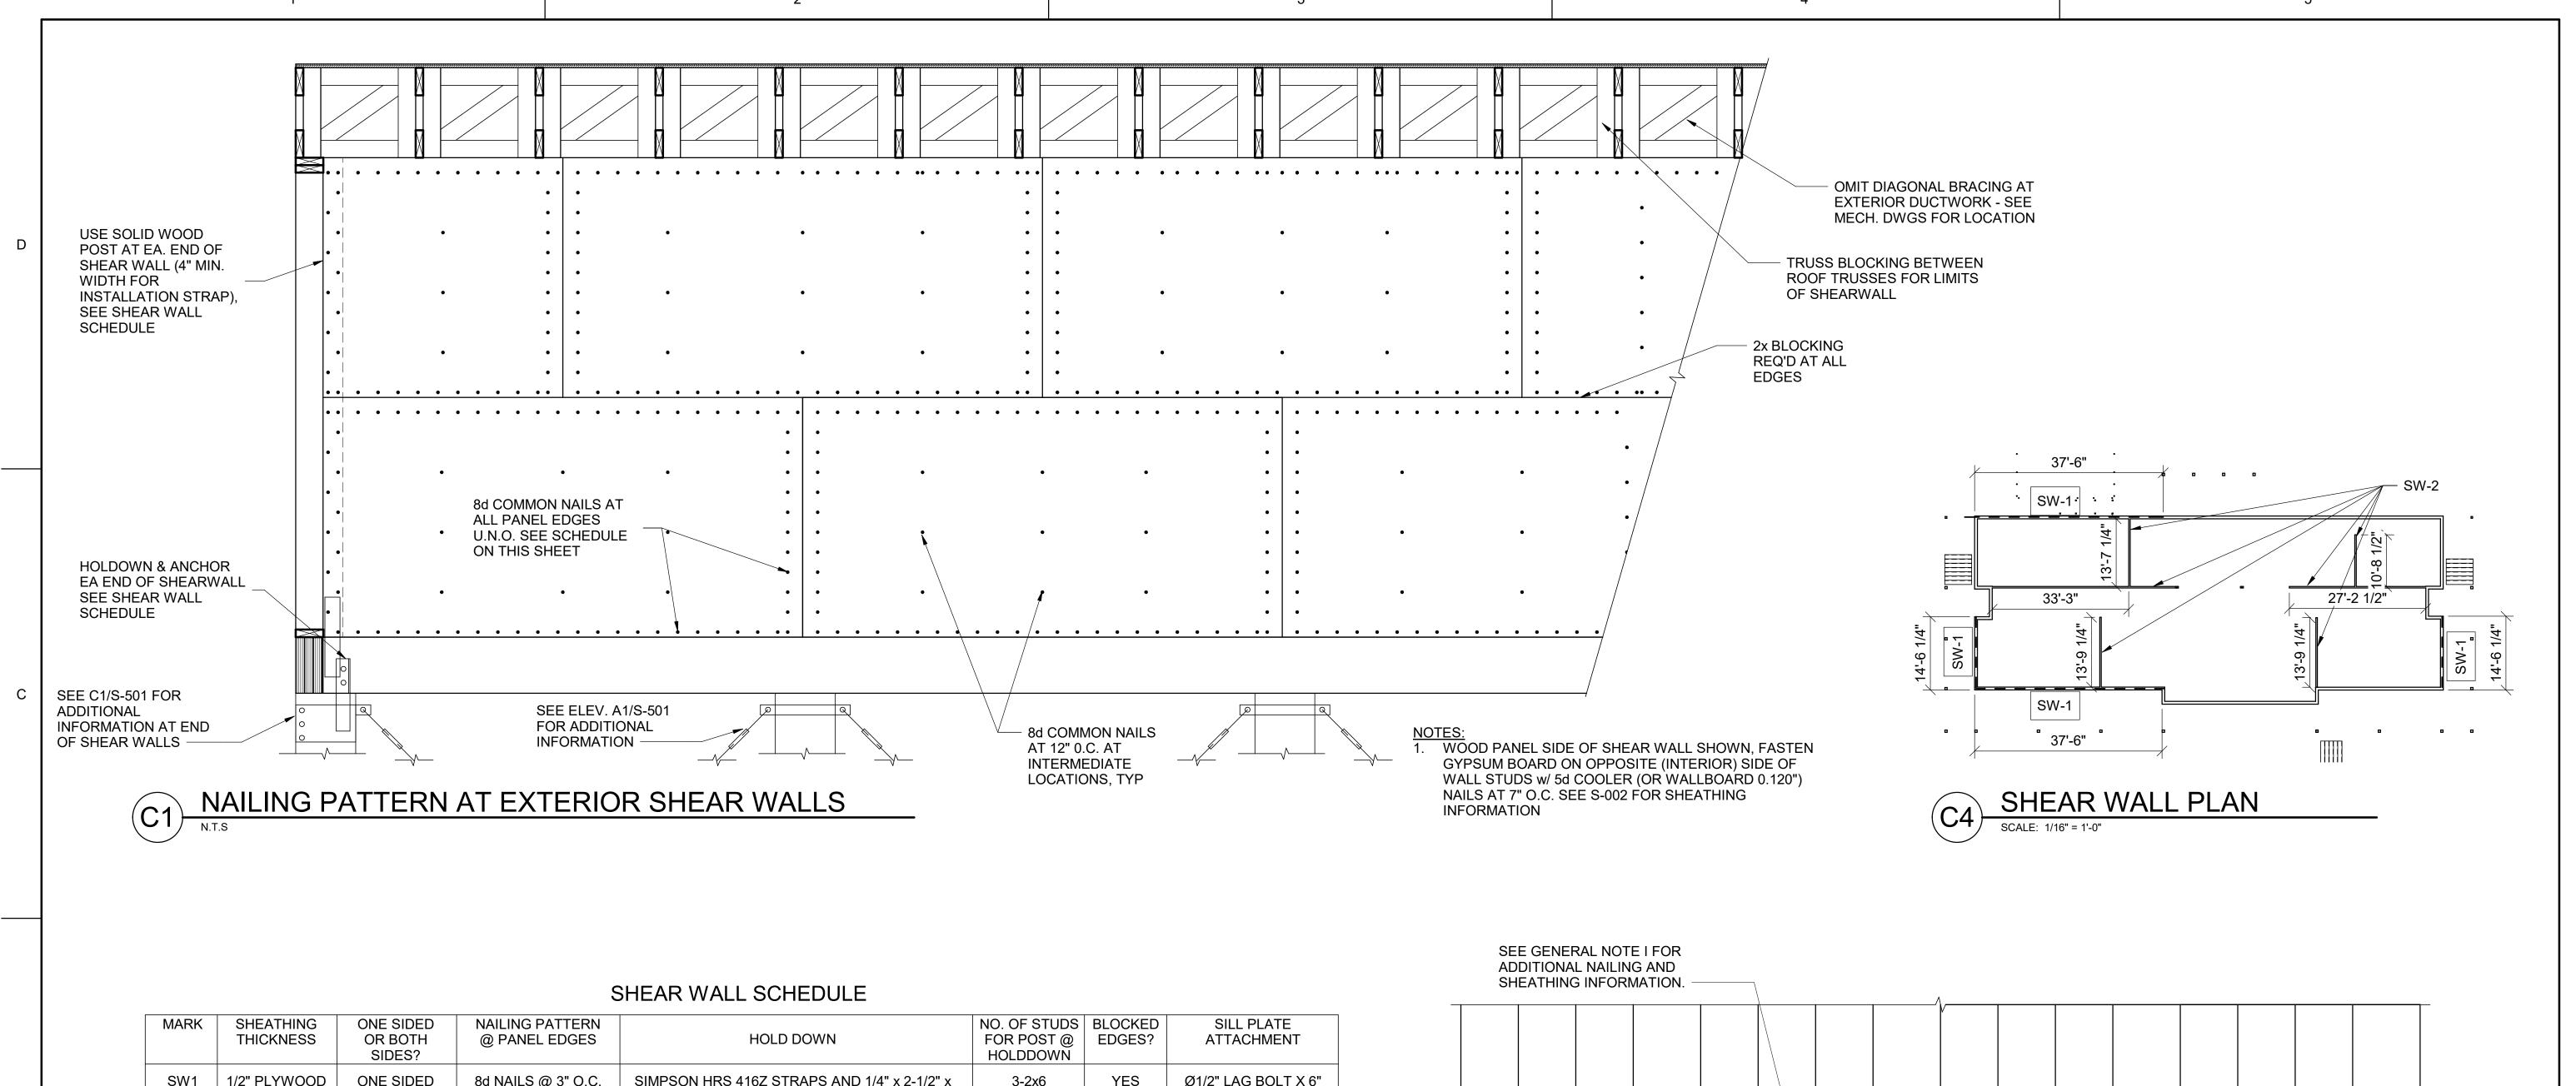

MARK	SHEATHING THICKNESS	ONE SIDED OR BOTH SIDES?	NAILING PATTERN @ PANEL EDGES	HOLD DOWN	NO. OF STUDS FOR POST @ HOLDDOWN	BLOCKED EDGES?	SILL PLATE ATTACHMENT
SW1	1/2" PLYWOOD	ONE SIDED	8d NAILS @ 3" O.C.	SIMPSON HRS 416Z STRAPS AND 1/4" x 2-1/2" x 1'-9" BENT PLATE WITH 3/8" GUSSET PLATE (SEE C1/S-501 FOR ADDITIONAL INFO.)	3-2x6	YES	Ø1/2" LAG BOLT X 6" LONG @ 16" O.C.
SW2	1/2" GYPSUM WALLBOARD	BOTH SIDES	No. 12 SCREWS AT 3" O.C.	SIMPSON HRS 416Z STRAPS AND 1/4" x 2-1/2" x 1'-9" BENT PLATE WITH 3/8" GUSSET PLATE (SEE C1/S-501 FOR ADDITIONAL INFO.)	3-2x6	YES	Ø1/2" LAG BOLT X 6" LONG @ 16" O.C.

### JOIST HANGER SCHEDULE

10107.0175	HAN	GER	
JOIST SIZE	FACE-MOUNT	TOP-HUNG	CONCEALED FLANGES
(2) 2x12	LU28	LB28	LUC26
2x10	LU210	JB210A	LUC210
2x12	LU210	JB212A	LUC210
(2) 2x6	N/A	N/A	HUC26-2
(2) 2x8	N/A	N/A	HUC26-2
11 7/8" RED-I45	N/A	BA1.81/11.88	N/A
11 7/8" RED-I90	N/A	BA3.56/11.88	N/A
(2) 11 7/8" RED-I90	N/A	BA7.12/11.88	N/A

1. HANGER NAMES ARE BASED ON SIMPSON STRONG TIE PRODUCT LINE.


SUBMIT SUBSTITUTIONS TO E.O.R. FOR APPROVAL. 2. HANGERS LISTED IN TABLE ARE TO BE USED U.N.O. IN DETAILS.

### HEADER SCHEDULE

	2x4 WALLS		2x6 WALLS	
CLEAR OPENING	MINIMUM HEADER	MINIMUM JAMB	MINIMUM HEADER	MINIMUM JAMB
WIDTH < 4'-0"	(2) 2x8 WITH 1/2" THICK PLYWOOD FLITCH PLATE	(2) 2x4	(3) 2X8 WITH (2) 1/2" THICK PLYWOOD FLITCH PLATES	(2) 2x6

HEADER SIZES NOTED ARE THE MINIMUM SIZES TO BE USED U.N.O. 2. PLYWOOD SHALL BE ADDED BETWEEN PLIES SO THE OVERALL

WIDTH HEADER MATCHES THE WALL STUD DEPTH. PLIES SHALL BE NAILED PER THE FASTENING SCHEDULE on S-602.

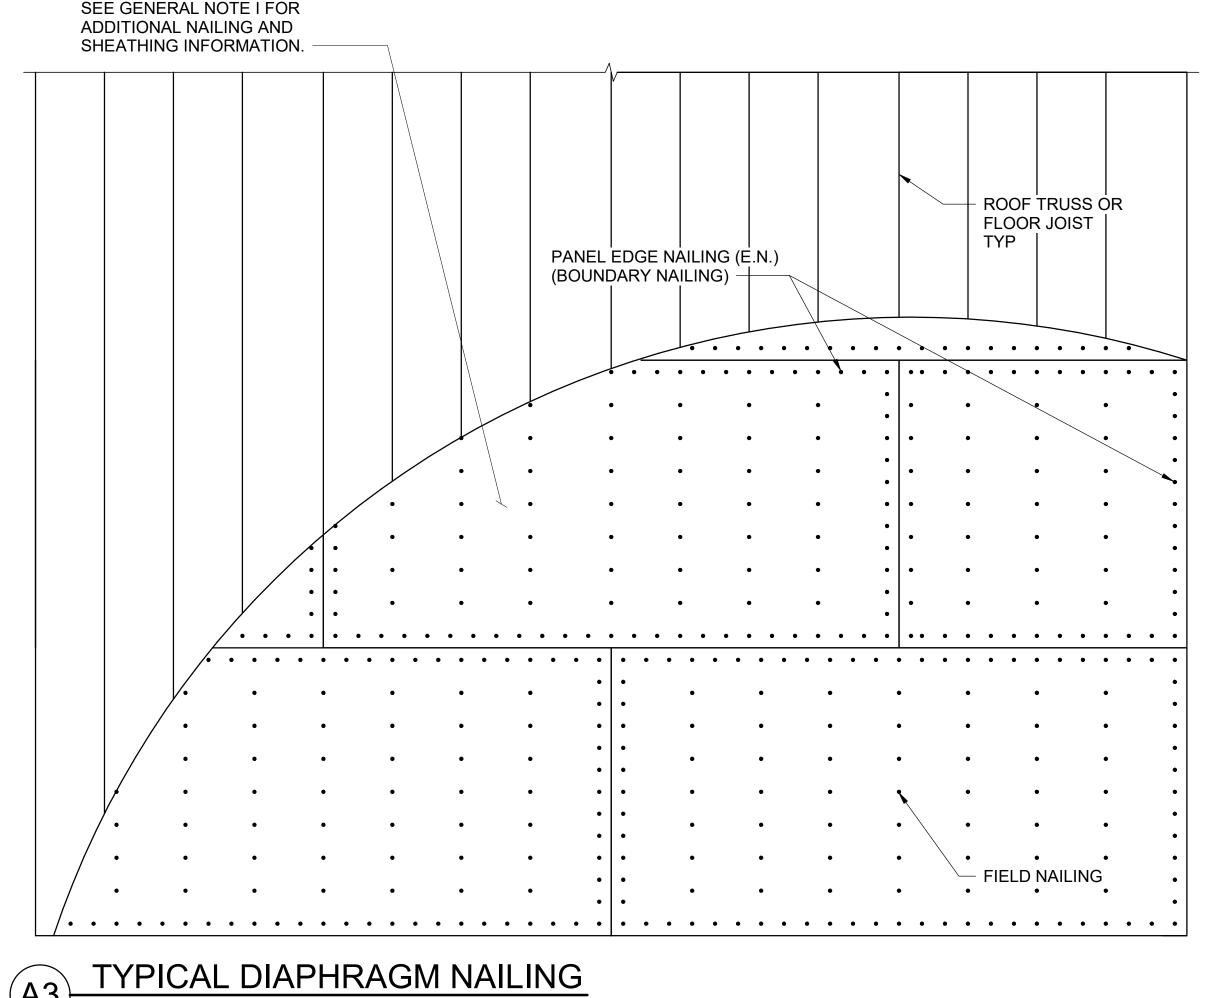

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SHEET TITLE

1220834

SCHEDULES

PROJECT #:

SHEET NUMBER

S-601

	FASTENING SCHEDULE						
	DESCRIPTION OF BUILDING ELEMENTS	NUMBER AND TYPE OF FASTENER	SPACING AND LOCATION				
ROOF							
1.	BLOCKING BETWEEN CEILING JOISTS, RAFTERS OR TRUSSES TO TOP PLATE OR OTHER FRAMING BELOW	4-8d BOX (2 1/2" x 0.113"); OR 3-8d COMMON (2 1/2" x 0.131"); OR 3-10d BOX (3" x 0.128"); OR 3-3" x 0.131" NAILS; OR 3-3" 14 GAGE STAPLES, 7/16" CROWN	EACH END, TOENAIL				
	BLOCKING BETWEEN RAFTERS OR TRUSSES NOT AT	2-8d COMMON (2 1/2" x 0.131"); OR 2-3" x 0.131" NAILS; OR 2-3" 14 GAGE STAPLES	EACH END, TOENAIL				
	THE WALL TOP PLATE, TO RAFTER OR TRUSS	2-16d COMMON (3 1/2" x 0.162"); OR 3-3" x 0.131" NAILS; OR 3-3" 14 GAGE STAPLES	END NAIL				
	FLAT BLOCKING TO TRUSS AND WEB FILLER	16d COMMON (3 1/2" x 0.162") @ 6" O.C.; OR 3" x 0.131" NAILS @ 6" O.C.; OR 3" 14 GAGE STAPLES @ 6" O.C.	FACE NAIL				
2.	RAFTER OR ROOF TRUSS TO TOP PLATE (SEE SECTION 2308.7.5, TABLE 2308.7.5)	3-10d COMMON (3" x 0.148"); OR 3-16d BOX (3 1/2" x 0.135"); OR 4-10d BOX (3" x 0.128"); OR 4-3" x 0.131" NAILS; OR 4-3" 14 GAGE STAPLES, 7/16" CROWN	TOENAIL <sup>(a)</sup>				
		WALL					
		16d COMMON (3 1/2" x 0.162")	24" O.C. FACE NAIL				
3.	STUD TO STUD (NOT AT BRACED WALL PANELS)	10d BOX (3" x 0.128"); OR 3" x 0.131" NAILS; OR 3-3" 14 GAGE STAPLES, 7/16" CROWN	16" O.C. FACE NAIL				
4.	STUD TO STUD AND ABUTTING STUDS AT	16d COMMON (3 1/2" x 0.162") 16d BOX (3 1/2" x 0.135")	16" O.C. FACE NAIL				
	INTERSECTING WALL CORNERS (AT BRACED WALL PANELS)	3" x 0.131" NAILS; OR 3-3" 14 GAGE STAPLES, 7/16" CROWN	12" O.C. FACE NAIL				
5.	BUILT-UP HEADER (2" TO 2" HEADER)	16d COMMON (3 1/2" x 0.162") 16d BOX (3 1/2" x 0.135")	16" O.C. FACE NAIL 12" O.C. FACE NAIL				
6.	CONTINUOUS HEADER TO STUD	4-8d COMMON (2 1/2" x 0.131") 4-10d BOX (3" x 0.128") 5-8d BOX (2 1/2" x 0.113")	TOENAIL				
		16d COMMON (3 1/2" x 0.162")	16" O.C. FACE NAIL				
7.	TOP PLATE TO TOP PLATE	10d BOX (3" x 0.128"); OR 3" x 0.131" NAILS; OR 3" 14 GAGE STAPLES, 7/16" CROWN	12" O.C. FACE NAIL				
8.	TOP PLATE TO TOP PLATE, AT END JOINTS	8-16d COMMON (3 1/2" x 0.162"); OR 12-16d BOX (3 1/2" x 0.135"); OR 12-10d BOX (3" x 0.128"); OR 12-3" x 0.131" NAILS; OR 12-3" 14 GAGE STAPLES, 7/16" CROWN	EACH SIDE OF END JOINT, FACE NAIL (MINIMUM 24" LAP SPLICE LENGTH EACH SIDE OF END JOINT)				
		16d COMMON (3 1/2" x 0.162")	16" O.C. FACE NAIL				
9.	BOTTOM PLATE TO JOIST, RIM JOIST, BAND JOIST OR BLOCKING ( NOT AT BRACED WALL PANELS)	16d BOX (3 1/2" x 0.135"); OR 3" x 0.131" NAILS; OR 3" 14 GAGE STAPLES, 7/16" CROWN	12" O.C. FACE NAIL				
10.	BOTTOM PLATE TO JOIST, RIM JOIST, BAND JOIST OR BLOCKING AT BRACED WALL PANELS	2-16d COMMON (3 1/2" x 0.162"); OR 3-16d BOX (3 1/2" x 0.135"); OR 4-3" x 0.131" NAILS; OR 4-3" 14 GAGE STAPLES, 7/16" CROWN	16" O.C. FACE NAIL				
11	STUD TO TOP OR BOTTOM PLATE	3-16d BOX (3 1/2" x 0.135"); OR 4-8d COMMON (2 1/2" x 0.131") ; OR 4-10d BOX (3" x 0.128"); OR 4-3" x 0.131" NAILS; OR 4-3" 14 GAGE STAPLES, 7/16" CROWN	TOENAIL				
11.	STOD TO TOP OR BOTTOM PLATE	2-16d COMMON (3 1/2" x 0.162"); OR 3-16d BOX (3 1/2" x 0.135") OR: 3-10d BOX (3" x 0.128"); OR 3-3" x 0.131" NAILS; OR 3-3" 14 GAGE STAPLES, 7/16" CROWN	END NAIL				
12.	TOP PLATES, LAPS AT CORNERS AND INTERSECTIONS	2-16d COMMON (3 1/2" x 0.162") 3-10d BOX (3" x 0.128"); OR 3-3" x 0.131" NAILS; OR 3-3" 14 GAGE STAPLES, 7/16" CROWN	FACE NAIL				
13.	1" BRACE TO EACH STUD AND PLATE	2-8d COMMON (2 1/2" x 0.131"); OR 2-10d BOX (3" x 0.128"); OR 2-3" x 0.131" NAILS; OR 2-3" 14 GAGE STAPLES, 7/16" CROWN	FACE NAIL				

(a	a) WHERE A RAFTER IS FASTENED TO AN ADJACENT PARALLEL CEILING JOIST IN ACCORDANCE WITH THIS SCHEDULE AND THE CEILING
•	JOIST IS FASTENED TO THE TOP PLATE IN ACCORDANCE WITH THIS SCHEDULE, THE NUMBER OF TOENAILS IN THE RAFTER SHALL BE
	PERMITTED TO BE REDUCED BY ONE NAIL.

<u>FASTE</u>	NING SCHEDULE	
DESCRIPTION OF BUILDING ELEMENTS	NUMBER AND TYPE OF FASTENER	SPACING AND LOCATION
	FLOOR	
14. JOIST TO SILL, TOP PLATE, OR GIRDER	4-8d BOX ( 2 1/2" x 0.113") OR; 3-8d COMMON (2 1/2" x 0.131") ; OR 3-10d BOX (3" x 0.128"); OR 3-3" x 0.131" NAILS; OR 3-3" 14 GAGE STAPLES, 7/16" CROWN	TOENAIL
	8d BOX (2 1/2" x 0.131")	4" O.C., TOENAIL
15. RIM JOIST, BAND JOIST, OR BLOCKING TO TOP PLATE, SILL OR OTHER FRAMING BELOW	8d COMMON (2 1/2" x 0.131"); OR 10d BOX (3" x 0.128"); OR 3" x 0.131" NAILS; OR 3" 14 GAGE STAPLES, 7/16" CROWN	6" O.C., TOENAIL
	20d COMMON (4" x 0.192"); OR	32" O.C. FACE NAIL AT TOP AND BOTTOM STAGGERED ON OPPOSITE SIDES
16. BUILT-UP GIRDERS AND BEAMS, 2" LUMBER LAYERS	10d BOX (3" x 0.128"); OR 3" x 0.131" NAILS; OR 3" 14 GAGE STAPLES, 7/16" CROWN	24" O.C. FACE NAIL AT TOP AND BOTTOM STAGGERED ON OPPOSITE SIDES
	AND: 2-20d COMMON (4" x 0.192") ; OR 3-10d BOX (3" x 0.128"); OR 3-3" x 0.131" NAILS; OR 3-3" 14 GAGE STAPLES, 7/16" CROWN	ENDS AND AT EACH SPLICE, FACE NAIL
17. LEDGER STRIP SUPPORTING JOISTS TO RAFTERS	3-16d COMMON (3 1/2" x 0.162"); OR 4-16d BOX (3 1/2" x 0.135"); OR 4-10d BOX (3" x 0.128"); OR 4-3" x 0.131" NAILS; OR 4-3" 14 GAGE STAPLES, 7/16" CROWN	EACH JOIST OR RAFTER, FACE NAIL
18. JOIST TO BAND JOIST OR RIM JOIST	3-16d COMMON (3 1/2" x 0.162"); OR 4-10d BOX (3" x 0.128"); OR 4-3" x 0.131" NAILS; OR 4-3" 14 GAGE STAPLES, 7/16" CROWN	ENDNAIL
19. BRIDGING OR BLOCKING TO JOIST, RAFTER OR TRUSS	2-8d COMMON (2 1/2" x 0.131"); OR 2-10d BOX (3" x 0.128"); OR 2-3" x 0.131" NAILS; OR 2-3" 14 GAGE STAPLES, 7/16" CROWN	EACH END, TOENAIL

<u>FA</u>	STENING SCHEDULE		
DESCRIPTION OF BUILDING ELEMENTS	NUMBER AND TYPE OF FASTENER	SPACI	NG AND LOCATION
		EDGES (INCHES)	INTERMEDIATE SUPPORTS (INCHES
	SP), SUBFLOOR, ROOF AND INTERIOR WALL SHEATHING TO TICLEBOARD WALL SHEATHING TO FRAMING <sup>(a)</sup>		
	10d COMMON OR DEFORMED (2 1/2" x 0.131"); OR 2 3/8" x 0.113" NAIL (SUBFLOOR AND WALL)	6	12
	10d COMMON OR DEFORMED (2 1/2" x 0.131" x 0.281" HEAD) (ROOF) OR RSRS-01 (2 3/8" x 0.131") NAIL (ROOF)(b)	6	12
20. 3/8" - 1/2"	1 3/4" 16 GAGE STAPLE, 7/16" CROWN (SUBFLOOR AND WALL)	4	8
	2 3/8" x 0.113" x 0.266" HEAD NAIL (ROOF)	3 <sup>(c)</sup>	3 <sup>(c)</sup>
	1 3/4" 16 GAGE STAPLE, 7/16" CROWN (ROOF)	3(c)	<b>3</b> (c)
	10d COMMON (2 1/2" x 0.131"); (SUBFLOOR AND WALL)	6	12
21. 19/32" - 3/4"	10d COMMON OR DEFORMED (2 1/2" x 0.131" x 0.281" HEAD) (ROOF) OR RSRS-01 (2 3/8" x 0.113") NAIL (ROOF)(b)	6 <sup>(d)</sup>	6(d)
	2 3/8" x 0.113" x 0.266" HEAD NAIL; OR 2" 16 GAGE STAPLE, 7/16" CROWN	4	8
WOOD STRUCTURAL PANELS,	COMBINATION SUBFLOOR UNDERLAYMENT TO FRAMING		
22. 3/4" AND LESS	10d COMMON (2 1/2" x 0.131"); OR DEFORMED (2" x 0.113"); OR DEFORMED (2 1/2" x 0.120"0	6	12
	I		

(a) NAILS SPACED AT 6 INCHES AT INTERMEDIATE SUPPORTS WHERE SPANS ARE 48 INCHES OR MORE. FOR NAILING OF WOOD STRUCTURAL PANEL DIAPHRAGMS AND SHEAR WALLS, REFER TO SECTION 2305. NAILS FOR WALL SHEATHING ARE PERMITTED TO BE COMMON, BOX OR CASING.

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US Fish & Wildlife Services

**PROJECT NAME** 

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LA-27 Bell City, LA 70630

DRAWING ISSUE

DESIGNED BY: D. SKULLY

DRAWN BY: D. SKULLY CHECKED BY: W. HAYNES SUBMITTED BY: C. CUSICK 02/12/2025 PROJECT #: 1220834

SHEET TITLE

**FASTENING** SCHEDULES

SHEET NUMBER

 <sup>(</sup>b) RSRS-01 IS A ROOF SHEATHING RING SHANK NAIL MEETING THE SPECIFICATIONS IN ASTM F1667.
 (c) FASTENING IS ONLY PERMITTED WHERE THE ULTIMATE DESIGN WIND SPEED IS LESS THAN OR EQUAL TO 100 MPH.

### ARCHITECTURAL ABBREVIATIONS

<u>ARCHITI</u>	<u>ECTURAL ABBREVIAT</u>	IONS:			
AFF	ABOVE FINISHED FLOOR	FDN	FOUNDATION	PL	PLATE
ADAAG	AMERICAN W/ DISABILITIES	GA	GAGE / GAUGE	PLMB	PLUMBING
7157010	ACCESSIBILITY GUIDELINES	GALV	GALVANIZED	PLYWD.	PLYWOOD
ADJ	ADJUST/ ADJUSTABLE	GFCI	GOVERNMENT FURNISHED	PT	PORCELAIN TILE
ACT	ACOUSTICAL CEILING TILE	OI OI	CONTRACTOR INSTALLED	LBS. OR #	POUNDS
	ANODIZED	GFGI	GOVERNMENT FURNISHED	PSF	POUNDS / SQUARE FOOT
ANOD		GFGI		PSI	
AL / ALUM.	ALUMINUM	OI.	GOVERNMENT INSTALLED		POUNDS / SQUARE INCH
APPROX	APPROXIMATE	GL	GLASS / GLAZING	PEMB	PRE-ENGINEERED
AR/ARCH	ARCHITECTURAL	GOVT	GOVERNMENT		METAL BUILDING
AT / FP	ANTI TERRORISM /	GYP	GYPSUM	PRE-FAB	PREFABRICATED
	FORCE PROTECTION	GWB	GYPSUM WALL BOARD	Q.T.	QUARRY TILE
AVG	AVERAGE	HDW	HARDWARE	RAF	RAISED ACCESS FLOOR
A/V	AUDIO/VISUAL	HGT	HEIGHT	RCPT	RECEPTIONIST / RECEPTION
BLKG	BLOCKING	HM	HOLLOW METAL	REF	REFERENCE
BD	BOARD	HORIZ	HORIZONTAL	REINF	REINFORCEMENT /
BTM	BOTTOM	HB	HOSE BIBB		REINFORCED
B/O	BOTTOM OF	HVAC	HEATING VENTILATION &	REQ'D	REQUIRED
BLDG	BUILDING		AIR CONDITIONING	REV	REVISIONS / REVISED
CFCI	CONTRACTOR FURNISHED	IMP	INSULATED METAL PANEL	R/D	ROOF DRAIN
	CONTRACTOR INSTALLED	IN	INCH	RH	RIGHT HAND
CFMF	COLD FORMED	INSUL	INSULATION	RHR	RIGHT HAND REVERSE
	METAL FRAMING	INT	INTERIOR	RM	ROOM
CPT	CARPET	JAN	JANITOR	RO	ROUGH OPENING
CLG	CEILING	JC	JANITOR'S CLOSET	RB	RUBBER BASE
CLG HT	CEILING HEIGHT	JT	JOINT	SG	SAFETY GLASS / GLAZING
CTR	CENTER	KP	KICK PLATE	SC	SEALED CONCRETE
¢.	CENTER LINE			SCHED	SCHEDULE
CT	CERAMIC TILE	LAM	LAMINATE	SECT	SECTION
CLR	CLEAR	LDG	LANDING	SSK	SERVICE SINK
CO	CLEANOUT	LAV	LAVATORY	SIM	SIMILAR
		LH	LEFT HAND	STC	SOUND TRANSMISSION C
COL	COLUMN	LHR	LEFT HAND REVERSE	SPEC(S)	SPECIFICATION
CONC	CONCRETE	LGT	LENGTH	SFRM	SPRAYED FIRE
CORR	CORRIDOR	LT	LIGHT	OFFRIN	RESISTIVE MATERIAL
CMU	CONCRETE MASONRY UNIT	LTG	LIGHTING	SQ	SQUARE
CONF	CONFERENCE	LONG	LONGITUDINAL	ST	STAIN
CONST	CONSTRUCTION	LVR	LOUVER	S.S.	STAINLESS STEEL
CONT	CONTINUOUS	L/V	LOW VOLTAGE	STD	STANDARD
CONTR	CONTRACTOR	MAS	MASONRY	STL	STEEL
CJ	CONTROL JOINT	MO	MASONRY OPENING	STOR	STORAGE
CY	CUBIC YARD	MGR	MANAGER	STR	STRUCTURAL
DET	DETAIL	MANUF	MANUFACTURER	SUSP	SUSPENDED
DIA	DIAMETER	MATL	MATERIAL		
DIM	DIMENSION				TELECOMMUNICATIONS
DISP	DISPENSER	MAX	MAXIMUM	TEL	TELEPHONE
DN	DOWN	MECH	MECHANICAL	THK	THICK / THICKNESS
DS	DOWNSPOUT	MTL	METAL MALL BANEL	TLT	TOILET
DESC	DESCRIPTION	MWP	METAL WALL PANEL	T/O	TOP OF
DWG	DRAWING	MB	MINI BLIND	TYP	TYPICAL
EA	EACH	MIN	MINIMUM	U.L.	UNDERWRITERS
ELEC	ELECTRICAL OR ELECTRIC	MIR	MIRROR		LABORATORIES
EL	ELEVATION	MISC	MISCELLANEOUS	UNFIN	UNFINISHED
EWC	ELECTRIC WATER COOLER	N.I.C.	NOT IN CONTRACT	U.N.O.	UNLESS NOTED OTHERW
EP	EPOXY PAINT	NO. (#)	NUMBER	VERT	VERTICAL
ENGR	ENGINEER	NTS	NOT TO SCALE	VEST	VESTIBULE
EOS	EDGE OF SLAB	NFPA	NATIONAL FIRE	VCT	VINYL COMPOSITION TILE
EQUIP	EQUIPMENT		PROTECTION ASSOCIATION	VCB	VINYL COVE BASE
EQ	EQUAL	O.C.	ON CENTER	WDT	WIDTH
EXIST	EXISTING	OFCI	OWNER FURNISHED	W /	WITH
EXP	EXPOSED		CONTRACTOR INSTALLED	WC	WATER CLOSET
EJ	EXPANSION JOINT	OFGI	OWNER FURNISHED	WD	WOOD
EXP ST	EXPOSED TO STRUCTURE		GOVERNMENT INSTALLED	WDW	WINDOW
EXT	EXTERIOR	O.H.	OPPOSITE HAND	W/O	WITHOUT
FDC	FIRE DEPARTMENT	OPNG	OPENING	WRGB	WATER RESISTANT
	CONNECTION	OPP	OPPOSITE		GYPSUM BOARD
FT	FEET	O.D.	OUTSIDE DIAMETER	YD	YARD
		$\triangle$ H2 $\bigcirc$	OCCUPATIONAL SAFETY		

OSHA

O/D

PNL

**PART** 

PLAS

PLAM

PT / PNT

OVHD / OH OVERHEAD

PAINT

PAIR

**PANEL** 

**PARTITION** 

**PLASTIC** 

### ARCHITECTURAL GENERAL NOTES:

- THE DRAWINGS INDICATE THE GENERAL EXTENT OF WORK. THE DRAWINGS ARE NOT INTENDED TO INDICATE OR DESCRIBE ALL WORK REQUIRED FOR THE FULL PERFORMANCE AND COMPLETION OF THE REQUIREMENTS OF THE CONTRACT DOCUMENTS.
- 2. THE ENUMERATION OF PARTICULAR ITEMS OF WORK IN ONE PORTION OF THE CONTRACT DOCUMENTS SHALL NOT BE CONSTRUED TO EXCLUDE OTHER ITEMS NECESSARY OR IMPLIED THEREFROM.
- 3. THE CONTRACTOR IS RESPONSIBLE FOR THE COORDINATION OF THE WORK SO THAT NO WORK SHALL BE LEFT IN AN UNFINISHED OR INCOMPLETE CONDITION.
- 4. WORK SHALL CONFORM TO APPLICABLE INDUSTRY AND MANUFACTURER'S PUBLISHED STANDARDS FOR QUALITY OF MATERIALS AND WORKMANSHIP AS WELL AS REQUIREMENTS IN THE CONSTRUCTION DOCUMENTS. ANY CONFLICTING REQUIREMENTS OF THE SOURCES LISTED ABOVE SHALL BE BROUGHT TO THE CONTRACTING OFFICER'S ATTENTION PRIOR TO PROCEEDING WITH
- THE CONTRACTOR SHALL PROTECT EXISTING, IN-PLACE, AND NEW WORK.
- WORK NOTED "N.I.C." IS NOT MEANT TO BE PART OF THE CONSTRUCTION SCOPE OF WORK AGREEMENT.
- THE CONTRACTOR SHALL PAY FOR AND COORDINATE THE REMOVAL AND LEGAL DISPOSAL OF MATERIALS AND RUBBISH.
- ONCE ON SITE, THE CONTRACTOR SHALL VERIFY EXISTING CONDITIONS THAT CORRESPOND TO THOSE SHOWN ON THE CONSTRUCTION DOCUMENTS. THE CONTRACTOR SHALL NOTIFY THE CONTRACTING OFFICER IN WRITING OF ANY DIFFERING CONDITIONS BEFORE COMMENCEMENT OF WORK
- DO NOT SCALE DRAWINGS; DIMENSIONS GOVERN, LARGE SCALE DETAILS GOVERN OVER SMALL SCALE DETAILS. THE CONTRACTOR SHALL NOTIFY THE CONTRACTING OFFICER IN WRITING OF ANY DIFFERING CONDITIONS BEFORE COMMENCEMENT OF WORK.
- 10. DIMENSIONS NOTED AS 'HOLD' SHALL NOT VARY BY MORE THAN 1/8" FROM SIDE TO SIDE OR FROM FRONT TO BACK, FINISHED
- SURFACE TO FINISHED SURFACE. 11. WALL AND/OR CEILING ASSEMBLIES THAT ARE IDENTIFIED WITH A FIRE RESISTIVE RATING SHALL BE CONSTRUCTED AS
- DETAILED HEREIN
- 12. DIMENSIONS SHOWN ARE TO FACE OF STUD OR CMU (U.N.O.). 13. THE CONTRACTOR SHALL PERFORM WORK IN ACCORDANCE WITH APPLICABLE CODES, ORDINANCES AND REGULATORY
- AGENCIES AND SHALL OBTAIN NECESSARY BUILDING AND FIRE PERMITS FROM AUTHORITIES HAVING JURISDICTION 14. INTERIOR FINISH MATERIALS SHALL COMPLY WITH THE REQUIREMENTS OF APPLICABLE CODES, ORDINANCES AND REGULATORY **AGENCIES**
- 15. DISSIMILAR METALS SHALL BE ISOLATED FROM EACH OTHER TO AVOID GALVANIC CORROSION.
- 16. NOTES APPEAR ON VARIOUS SHEETS FOR DIFFERENT SYSTEMS AND MATERIALS. SHEETS ARE TO BE REVIEWED AND NOTES ON INDIVIDUAL SHEETS SHALL BE APPLIED TO RELATED DRAWINGS AND DETAILS.
- 17. A FINISH INDICATION ON A WALL SHALL MEAN THE ENTIRE LENGTH AND HEIGHT OF WALL IS TO BE FINISHED OR FIRE-RATED AS INDICATED.
- 18. WHEN NON-DIMENSIONED PARTITIONS APPEAR IN CONJUNCTION WITH DOOR OPENINGS, THE DOOR WIDTH AND THE DOOR
- FRAME DETAILS DETERMINE THE LOCATION OF ADJACENT WALLS AND FRAMES.
- 19. DETAILS NOT SHOWN ARE SIMILAR IN CHARACTER TO THOSE DETAILED. WHERE SPECIFIC DIMENSIONS, DETAILS OR DESIGN INTENT CANNOT BE DETERMINED, CONSULT THE CONTRACTING OFFICER BEFORE PROCEEDING WITH THE WORK.
- 20. THE CONTRACTOR SHALL COORDINATE MECHANICAL AND ELECTRICAL FLOOR AND WALL SLEEVES INCLUDING CONDUITS WITH MECHANICAL, ELECTRICAL, PLUMBING, FIRE PROTECTION, STRUCTURAL AND ARCHITECTURAL DRAWINGS
- 21. PROVIDE ACCESS PANELS AS REQUIRED BY APPLICABLE CODES AND AS REQUIRED FOR MECHANICAL EQUIPMENT AND PLUMBING WORK. ACCESS PANELS SHALL BE CONCEALED AND LOCATIONS SHALL BE REVIEWED WITH THE ARCHITECT PRIOR TO PROCEEDING.
- 22. PIPE DUCTS AND BUS DUCTS THAT PENETRATE FLOOR SLABS OR WALL PARTITIONS SHALL BE INSTALLED IN A MANNER THAT WILL PRESERVE THE MOISTURE RESISTIVENESS, FIRE RATING, AND STRUCTURAL INTEGRITY OF THE BUILDING.
- 23. DO NOT CUT INTO, REMOVE OR ALTER ANY STRUCTURAL MEMBER OR PORTION OF THE FLOOR SYSTEM UNLESS IT IS
- SPECIFICALLY NOTED OR SHOWN ON THE STRUCTURAL DRAWINGS
- 24. PROVIDE EXPANSION AND CONTROL JOINTS IN WORK AS PER PRODUCT MANUFACTURER'S STANDARDS.
- 25. INTERIOR PARTITION MOVEMENT CONTROL:
- A. VERTICAL CONTROL JOINTS FOR ANY WALL LENGTH ARE TO OCCUR AT NOT MORE THAN 30'-0" O.C. IN THE HORIZONTAL DIRECTION, UNLESS NOTED OTHERWISE
- PROVISIONS SHALL BE MADE IN THE DESIGN, FABRICATION, AND INSTALLATION OF INTERIOR PARTITIONS FOR TYPICAL FLOOR DEFLECTIONS OF THE STRUCTURE UNDER SUPERIMPOSED LOADS AS FOLLOWS: a. TYPICAL ROOF/FLOOR MEMBERS: SPAN/360 BUT NOT LESS THAN 1/2".
- 26. THE CONTRACTOR SHALL PLAN HIS/HER WORK TO PROVIDE ADEQUATE PROTECTION FOR PERSONS AND PROPERTY AT ALL
- TIMES, AND EXECUTE THE WORK IN SUCH A MANNER TO AVOID ANY HAZARD TO PERSONS AND PROPERTY AS NECESSARY. 27. THE CONTRACTOR SHALL COORDINATE THE PHASING OF THE WORK TO BE PERFORMED IN OR ABOUT EXISTING FACILITIES, IF
- APPLICABLE, WITH THE OWNER PRIOR TO START OF SUCH WORK.
- 28. WHEREVER IN THE SPECIFICATIONS AND/OR DRAWINGS A CERTAIN BRAND, MAKE, MANUFACTURER, OR DEFINITE SPECIFICATION IS IDENTIFIED AS "BASIS OF DESIGN": THE REFERENCE IS USED ONLY TO DENOTE THE QUALITY STANDARD OF PRODUCT DESIRED AND DOES NOT RESTRICT BIDDERS TO THE SPECIFIC BRAND, MAKE, MANUFACTURER, OR SPECIFICATION NAMED. THE REFERENCE IS USED ONLY TO SET FORTH AND CONVEY TO PROSPECTIVE BIDDERS THE GENERAL STYLE, TYPE, CHARACTER, AND QUALITY OF PRODUCT DESIRED; AND THAT EQUIVALENT PRODUCTS WILL BE ACCEPTABLE. NOTE: THE GENERAL CONTRACTOR WILL BE RESPONSIBLE FOR DEVELOPING, DETAILING, COORDINATING, AND PROVIDING REVISIONS REQUIRED BY USE OF ALTERNATE MANUFACTURES PRODUCTS SHOULD REVISIONS TO DETAILING, AND UTILITIES BE REQUIRED

### **MATERIALS**

**COMPACTED EARTH** 

MAMA **ROCK** 

**ROCKFILL** 

SAND / MORTAR

4 4 **CONCRETE** 

CONCRETE BLOCK(CMU)

**EXTERIOR INSULATION** FINISH SYSTEM

**BRICK** 

METAL-SMALL SCALE

METAL-LARGE SCALE

**WOOD-FRAMING (CONTINUOUS)** 

**WOOD-BLOCKING** (DISCONTINUOUS)

**WOOD-FINISH** 

**ACOUSTICAL TILE** 

**GYPSUM BOARD** 

**INSULATION BATT** 

**INSULATION RIGID** 

**CERAMIC TILE** 

PLYWOOD

GLASS

PLASTER/ROCK LATH

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3500 Parkway Lane Suite 500

CONSULTANT

**CLIENT INFORMATION** FISH & WILDLII SERVICE US Fish & Wildlife Service

**PROJECT NAME** 

Cameron Prairie National Wildlife Refuge Bunkhouse

LA-27

Bell City, LA 70630

**DRAWING ISSUE** 

DESIGNED BY: R. ELLIOTT

DRAWN BY: U. MARGULL CHECKED BY: K. KOTELLOS SUBMITTED BY: C. CUSICK 02/12/2025 PROJECT #: 1220834

**SHEET TITLE** 

**GENERAL NOTES ABBREVIATIONS &** SYMBOLS

SHEET NUMBER A-001

**ORIGINAL SHEET SIZE:** 24" X 36"

## SYMBOLS:

SECTION NUMBER DWG. NO. WHERE SECTION IS DRAWN **BUILDING SECTION MARK** 

FINISH

**FLOOR** 

FACE OF

**FOOTING** 

FV

FIN

FEC

FLR

FD

F/O

FTG

FP

FIELD VERIFY


**FLOOR DRAIN** 


FINISHED FLOOR


FIRE EXTINGUISHER

FIRE PROTECTION

FIRE EXTINGUISHER CABINET

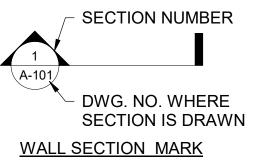


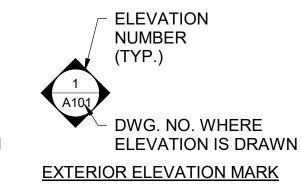


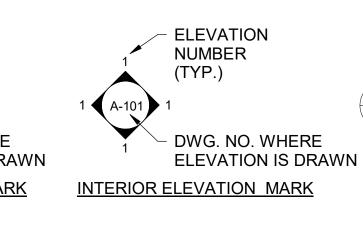

**CEILING TYPE** 

CEILING HGT

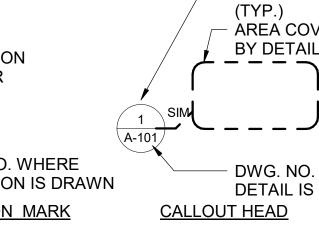

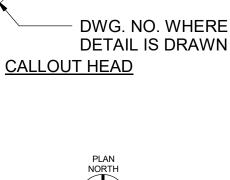

**DETAIL NUMBER** 

AREA COVERED

(TYP.)



DETAIL IDENTIFIER (MODULE LETTER AND NUMBER) FLOOR PLANS, ELEVATIONS & DETAILS SCALE: 1/8" = 1'-0"

FLOOR PLANS, ELEVATIONS, SECTIONS AND DETAIL VIEWS TITLE

## PLAN SYMBOLS:

**NEW & EXISTING** 

**COLUMN BUBBL** 

**ROOM NAME** ID# 101

**ROOM TAG** 

(A101A) DOOR TAG

+ A1-X | REQ)WINDOW & LOUVER TAG

PARTITION TYPE (REFER TO PARTITION SHEET FOR DESCRIPTION)

TYPE (AS

- PARTITION TYPE

SUBSCRIPT

OCCUPATIONAL SAFETY

AND HEALTH ACT

OVERFLOW DRAIN

PLASTIC LAMINATE

**KEYNOTE TAG** 

( 1t | 12'-0" A.F.F.) CEILING TAG (TYPE & HEIGHT)

SOUND TRANSMISSION CLASS


UNLESS NOTED OTHERWISE

RECEPTIONIST / RECEPTION

<u>EQUIPMENT</u> REVISION **TAG TAG** 

**1i** 

**NORTH ARROW** 

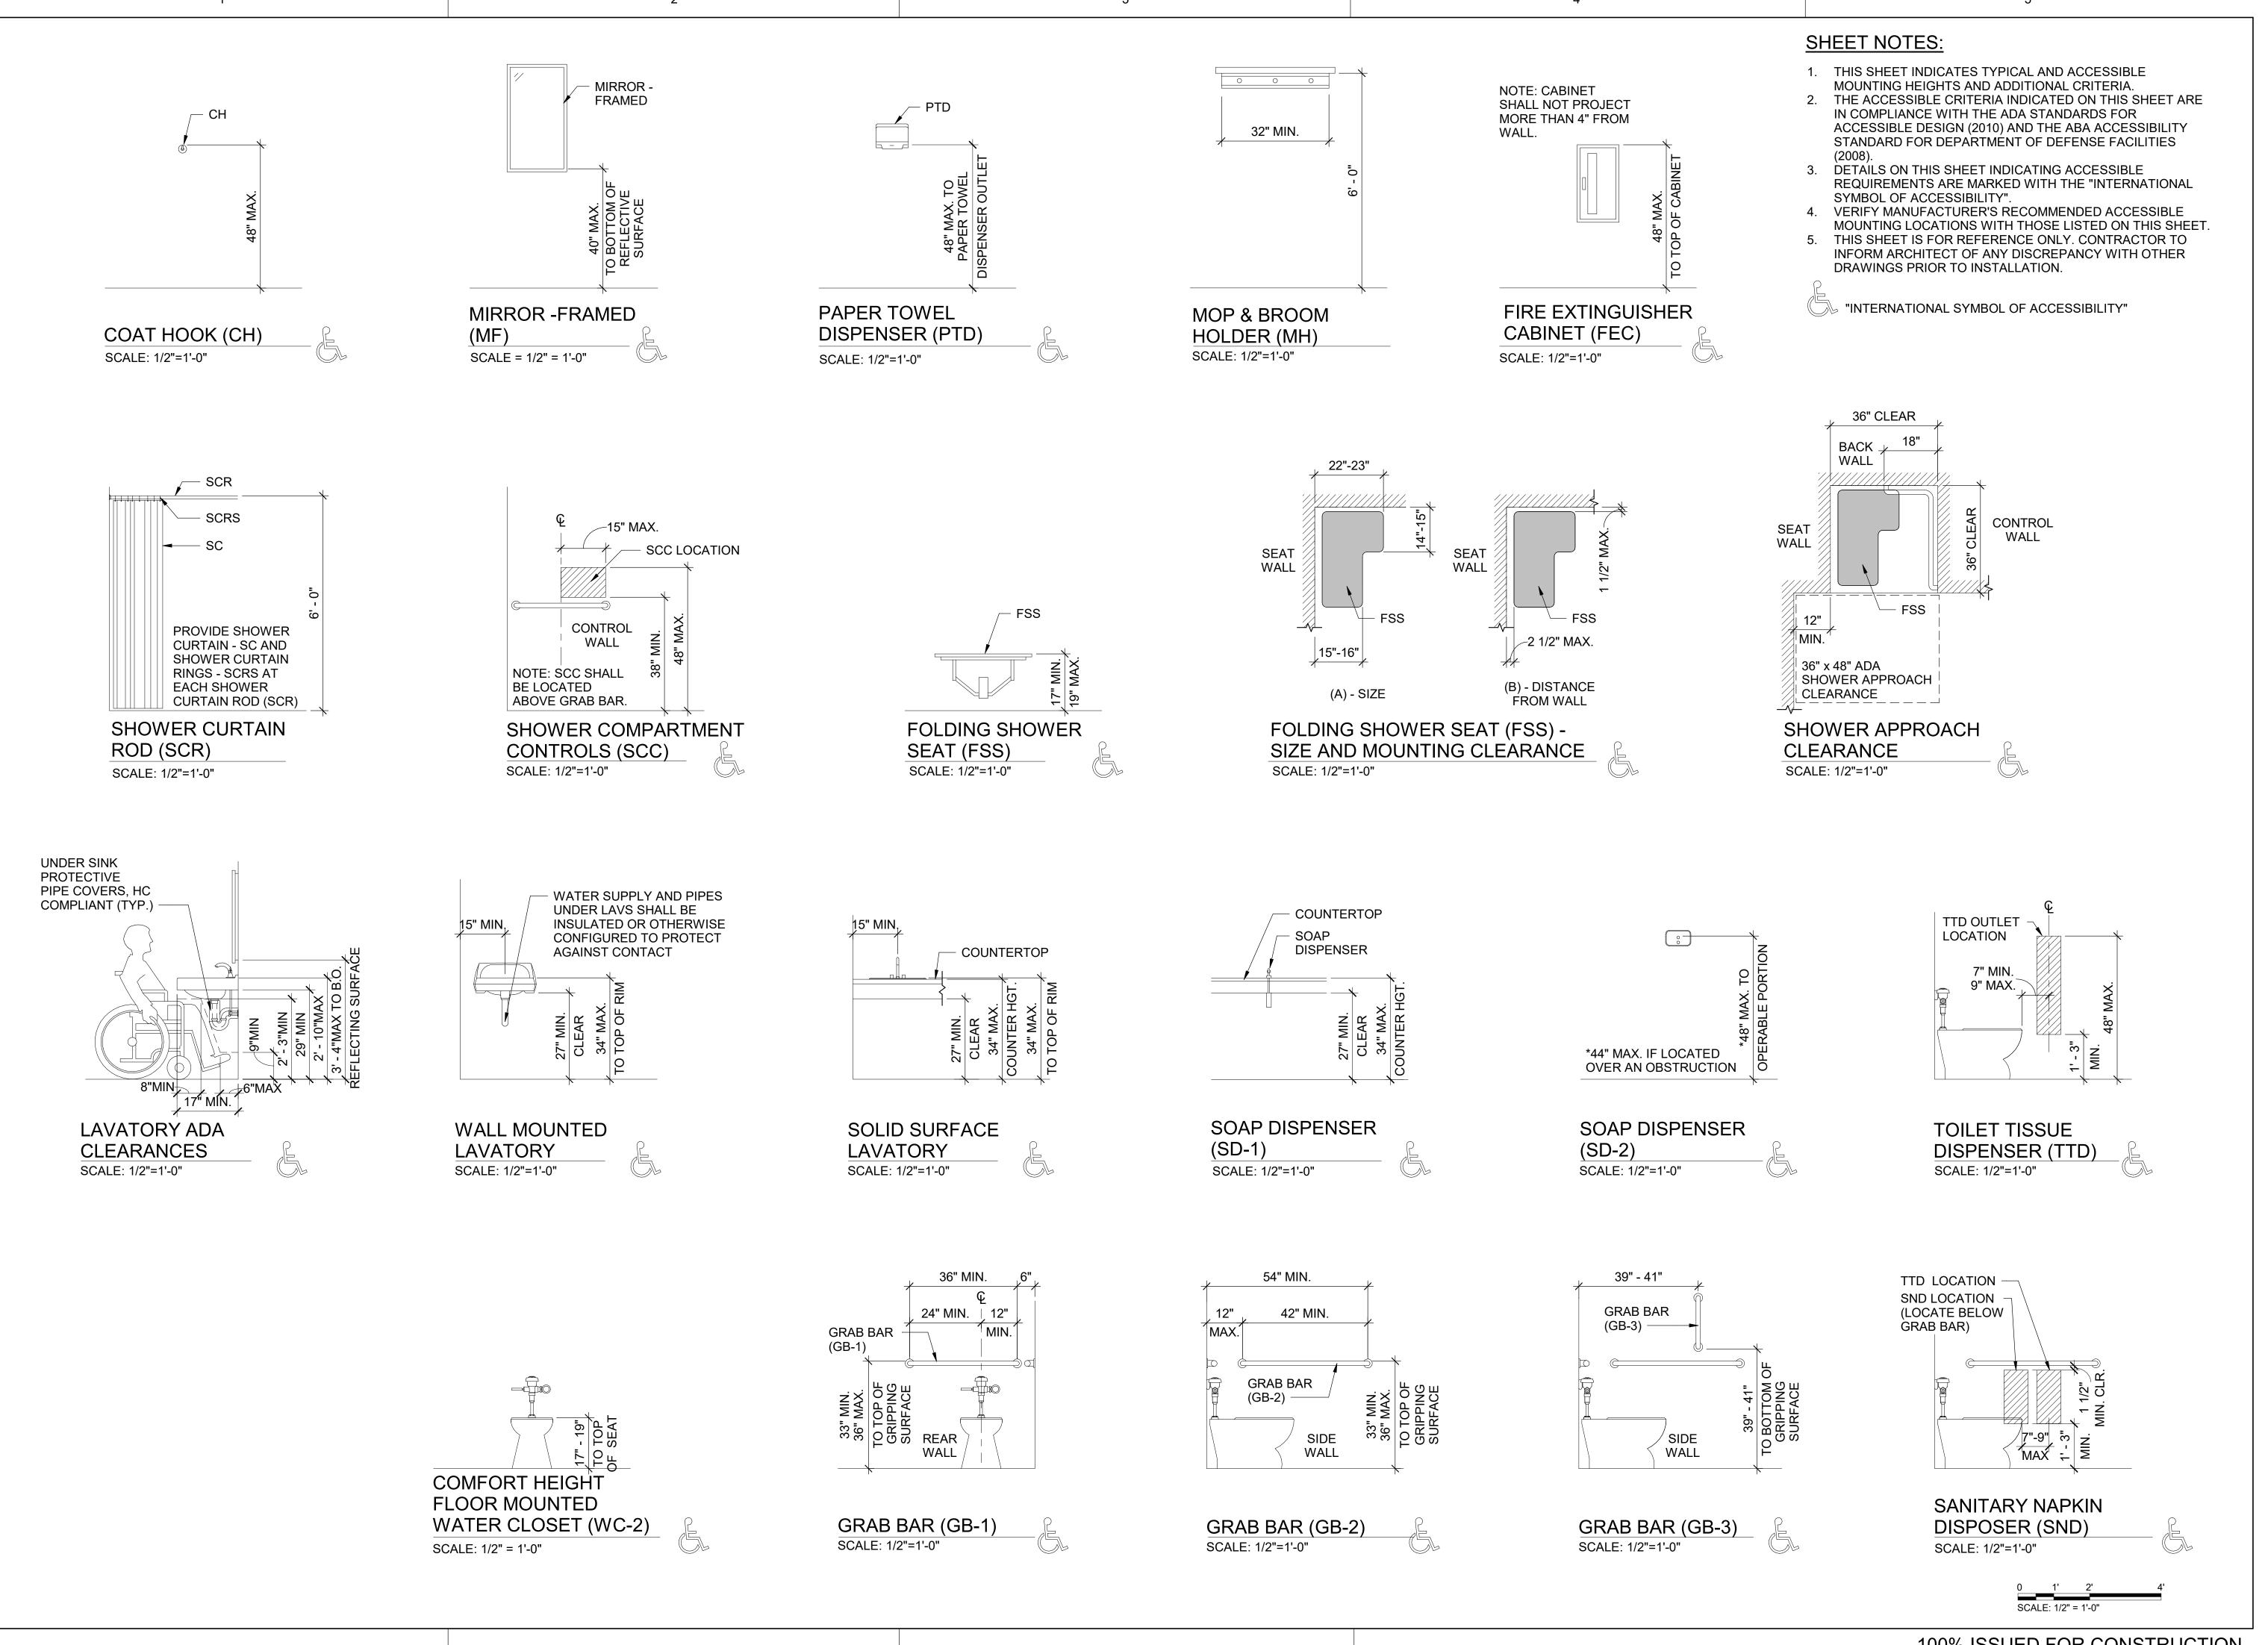

3500 Parkway Lane Suite 500

**Peachtree Corners** Georgia 30092

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**CLIENT INFORMATION** 

US Fish & Wildlife Service

**PROJECT NAME** 

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LA-27 Bell City, LA 70630

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SHEET TITLE


PROJECT #:

02/12/2025

1220834

**TYPICAL** MOUNTING HEIGHTS & LOCATIONS

SHEET NUMBER A-002

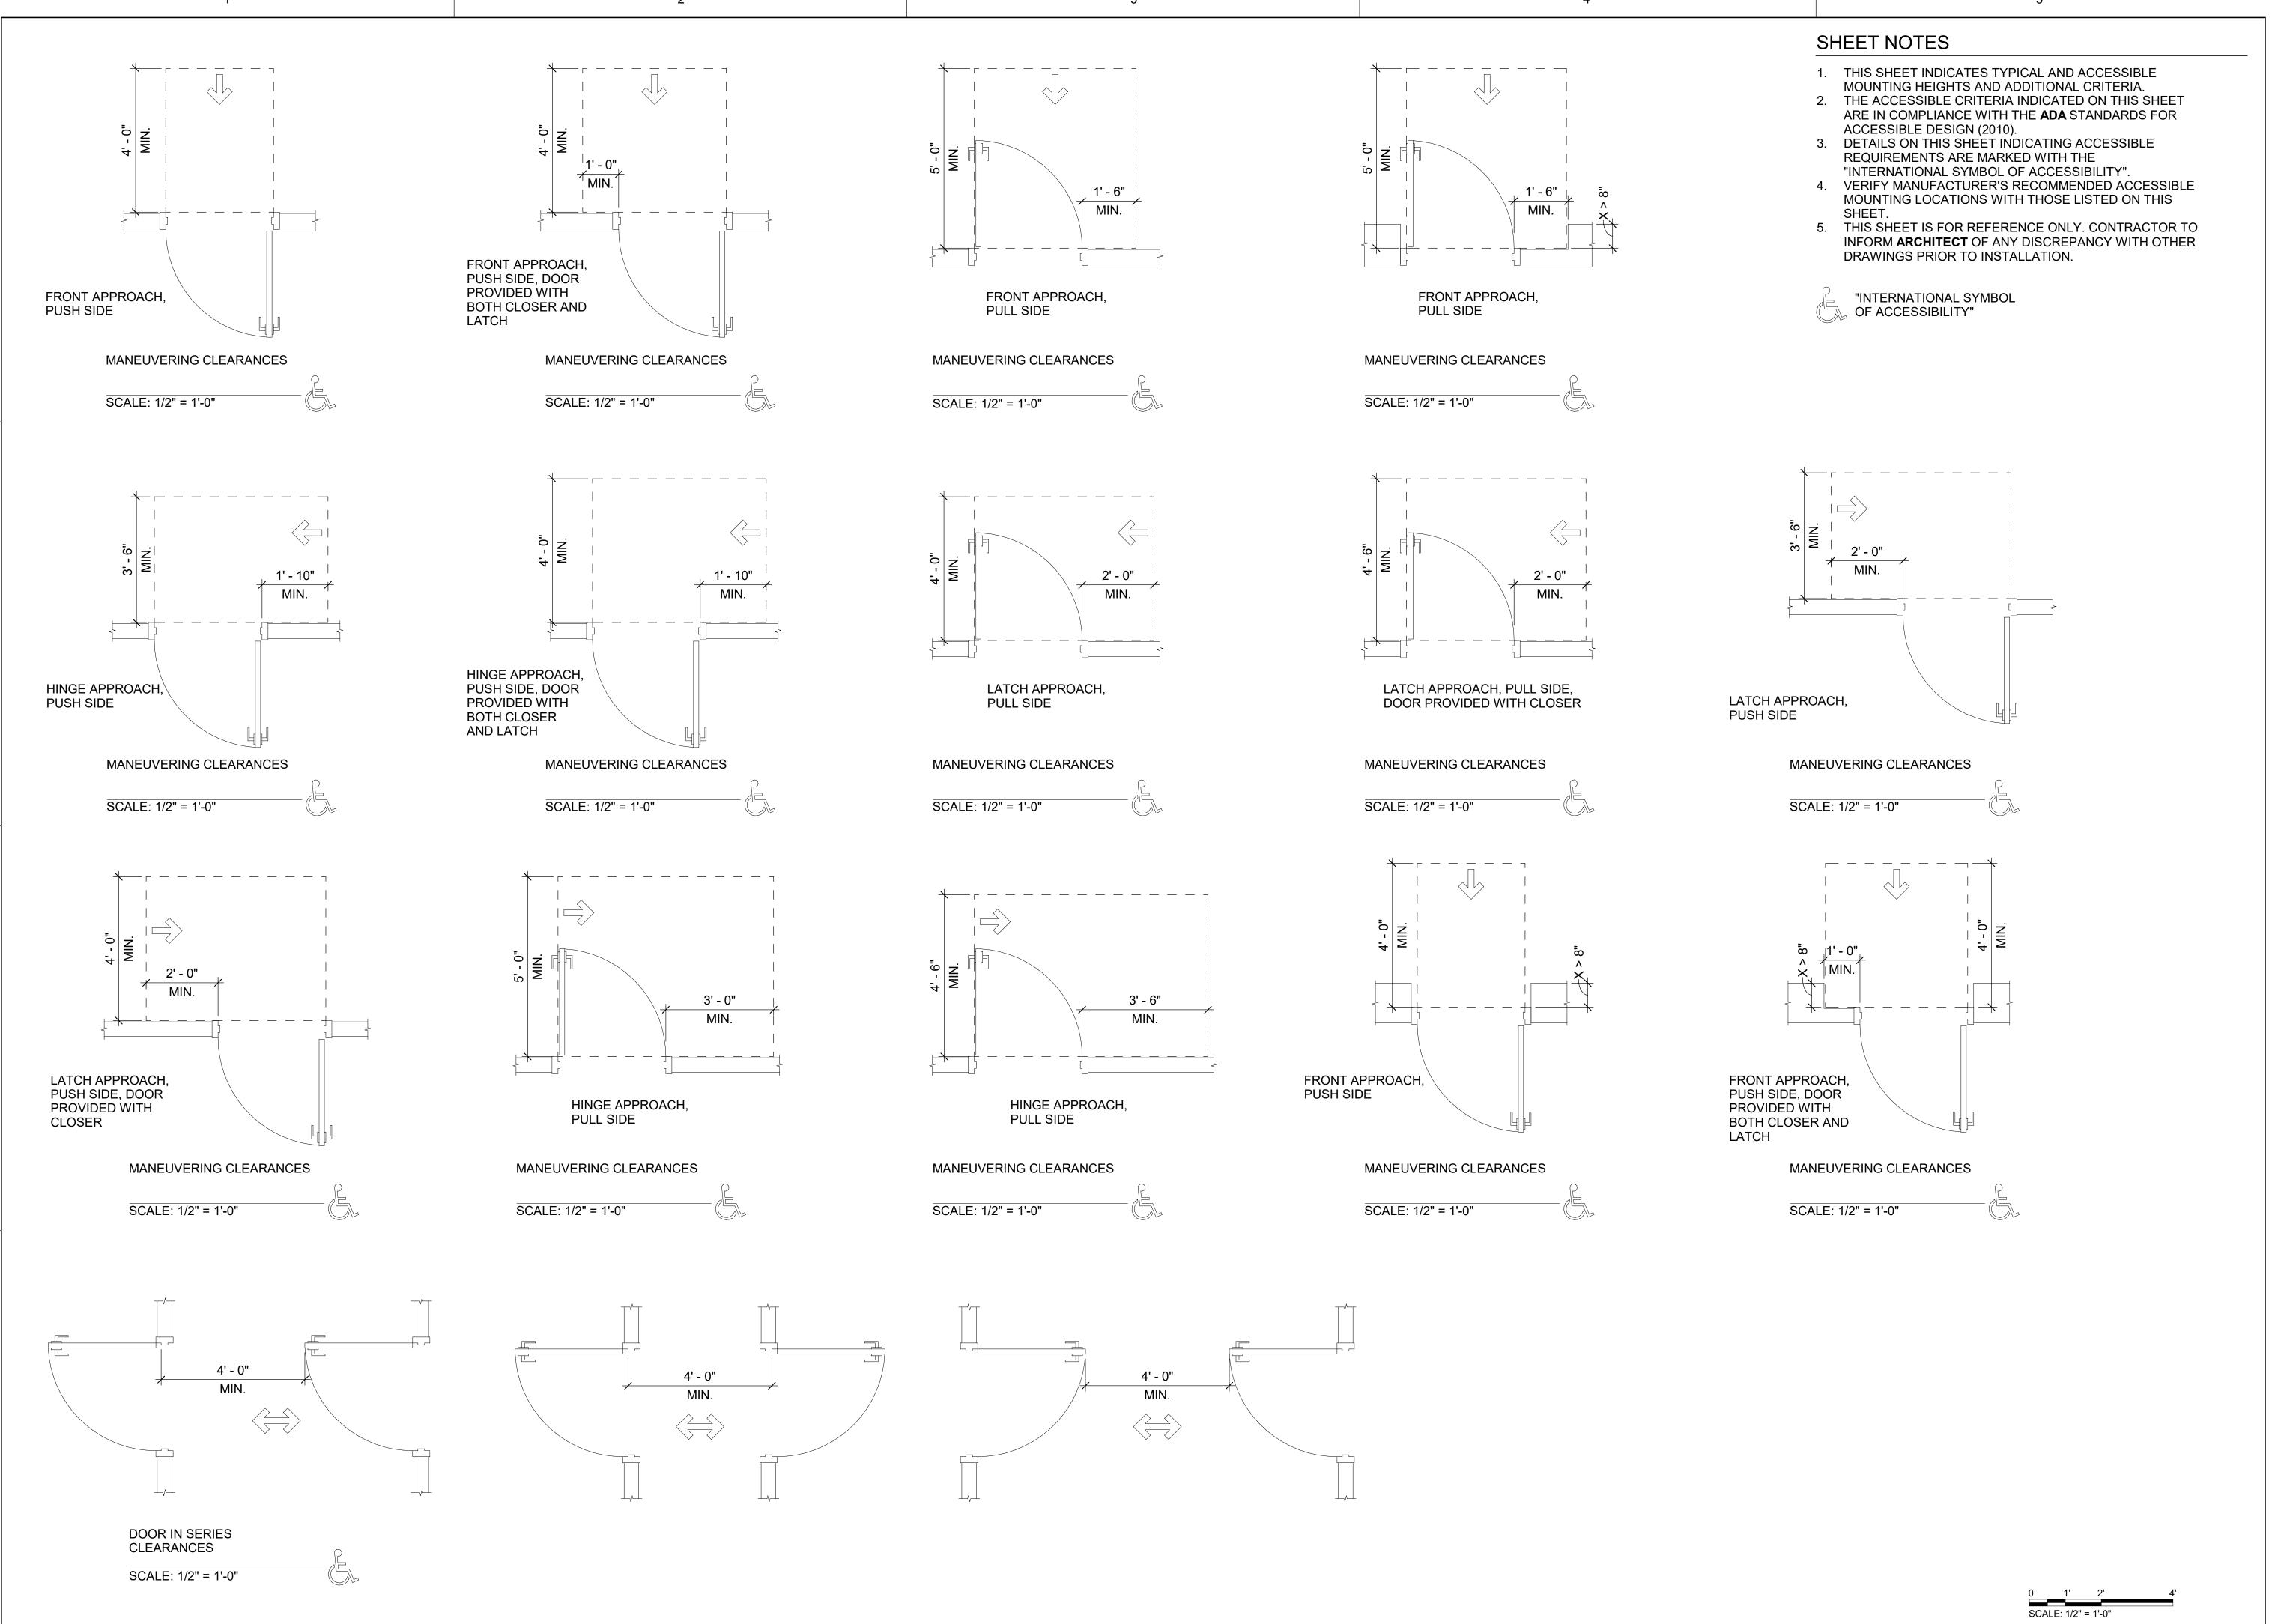

\_ PC

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Georgia 30092

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CLIENT INFORMATION

U.S.
FISH & WILDLIFE SERVICE

US Fish & Wildlife Service

PROJECT NAME

Cameron Prairie
National Wildlife
Refuge
Bunkhouse

LA-27 Bell City, LA 70630

DRAWING ISSUE

DATE

DESCRIPTION

DESIGNED BY: R. ELLIOTT
DRAWN BY: U. MARGULL
CHECKED BY: K. KOTELLOS
SUBMITTED BY: C. CUSICK

SHEET TITLE

02/12/2025

1220834

MANEUVERING CLEARANCES

PROJECT #:

A-004

LINE OF — REFER TO PARTITION HEAD FLOOR/ROOF CONNECTION DETAILS FOR STRUCTURE RATED CONDITIONS WOOD STUD TOP PLATE - LINE OF CEILING WOOD STUD TOP PLATE **CEILING**  LINE OF -CEILING WOOD STUD TOP PLATE LINE OF CEILING ABOVE REFER TO PLANS FOR PARTITION HEIGHT AND CAP FINISH DETAILS - WOOD STUD TOP PLATE

#### ADDITIONAL LAYERS GYPSUM BOARD (EACH SIDE) FOR FIRE RATING PER SCHEDULE BELOW GYPSUM BOARD, EACH SIDE WOOD STUD **BOTTOM PLATE** LINE OF FLOOR CAULK STRUCTURE

REFER TO WOOD STUD

PARTITION WIDTH

SCHEDULE BELOW FOR

## PARTITION TYPE W

WOOD STUD SCHEDULE										
MARK	STUD WIDTH	GWB (LAYERS EACH SIDE)	PARTITION WIDTH	FIRE RATING	UL LISTING					
W4C	3 1/2"	(1) 5/8"	4 3/4"	0 HR	N/A					
W4C-1	3 1/2"	(1) 5/8"	4 3/4"	0 HR	N/A					
W4C-2	3 1/2"	(1) 5/8"	4 1/8"	0 HR	N/A					
W6C	5 1/2"	(1) 5/8"	6 3/4"	0 HR	N/A					
W6C-1	5 1/2"	(1) 5/8"	6 3/4"	0 HR	N/A					
1W4C-3	3 1/2"	(1) 5/8" TYPE X	4 3/4"	1 HR	U305					
1W6C-3	5 1/2"	(1) 5/8" TYPE X	6 3/4"	1 HR	U305					

UL FIRE RATED CEILING

**UL P522** Wood Truss Fire Rating System Thickness STC 1 hours

Varies

n/a null

ASSEMBLY DETAILS

Roofing System: 1 layer Any UL Class A, B or C Roofing System (TGFU) or prepared Roof Covering (TFWZ)

Roof Sheathing: 1 layer Nom. 15/32" Thick Wood Structural Panels, Min. Grade "C-D" or "Sheathing"

Trusses: 1 layer Pitched or Parallel Chord Wood Trusses, Spaced 24" Max. O.C., Fabricated from Nom. 2x4 Lumber, Oriented Vertically or Horizontally. Min. Truss depth shall be 5-1/4" with a Min. Roof Slope of 3/12

Air Duct: 1 layer Any UL Class 0 or Class 1 Flexible Air Duct

Ceiling Damper: 1 layer Max. Nom. Area, 324 SQ IN., Max. square size, 18" by 18", Rectangular sizes not to exceed 324 SQ IN. with width of 18" Max., Damper height 14" Max.

Insulation: 1 layer 3-1/2" Thick Min. Batts and Blankets draped over Resilient Channel and Gypsum Board Ceiling Membrane

Resilient Channel: 1 layer 1/2" Deep, 25ga., Installed perpendicular to the Trusses, Spaced 16" Max. O.C.

Gypsum Panel: 1 layer 5/8" [15.9 mm] Sheetrock® EcoSmart Gypsum Panel (UL Type ULIX™)

INTERIOR PARTITION GENERAL NOTES

PARTITION TYPES DESCRIBE GENERAL REQUIREMENTS FOR PARTITIONS. REFER TO THE MANUFACTURER'S SPECIFICATIONS AND REQUIREMENTS OF APPLICABLE TESTING AGENCIES FOR SPECIFICS OF PARTITION CONSTRUCTION.

REFER TO "PARTITION TYPE NOMENCLATURE" FOR SYMBOLS USED TO IDENTIFY ADDITIONAL REQUIREMENTS AND MODIFIERS TO BASIC PARTITION TYPES.

"LINE OF STRUCTURE" INDICATED FOR EACH PARTITION IS DIAGRAMMATIC ONLY AND DOES NOT INDICATE EXACT CONSTRUCTION CONDITIONS OR GEOMETRY. TYPICAL FLOOR PLAN DIMENSIONS OF PARTITIONS ARE TO

FACE OF STUD OR CMU UNLESS NOTED OTHERWISE. WHERE A CLEAR OPENING DIMENSION IS INDICATED, THE DIMENSION IS MEASURED FACE-TO-FACE BETWEEN FINISHED SURFACES.

REFER TO SPECIFICATIONS FOR MINIMUM STUD DESIGN CRITERIA, MAXIMUM SPACING AND ALLOWABLE LIMITING HEIGHTS DEFLECTION CRITERIA FOR GYPSUM BOARD.

METAL STUD GAUGE (IF NOTED) AND UL TEST NUMBERS WILL VARY DEPENDING ON THE MANUFACTURER OF COMPONENTS ACTUALLY USED.

REFER TO FLOOR PLANS FOR FIRE PROTECTION RATINGS. RATED PARTITIONS SHALL BE LABELED ABOVE CEILING WITH LABELS PER AHJ AS REQUIRED. IBC CHAPTER 7 AT MINIMUM.

D. PENETRATIONS IN RATED PARTITIONS AND CONNECTIONS OF THE PARTITIONS TO OTHER PORTIONS OF THE WORK TO BE IN ACCORDANCE WITH MANUFACTURER'S RECOMMENDED DETAILS AND IN COMPLIANCE WITH APPLICABLE TESTING AGENCY REQUIREMENTS.

 INSTALLATION OF GYPSUM BOARD, BACKER BOARD AND BASE BOARD TO CONFORM TO REQUIREMENTS FOR FIRE RATINGS AND ACOUSTICAL RATINGS.

2. PROVIDE WATER RESISTANT TYPE GYPSUM BOARD AT AREAS THAT ARE NOTED IN ROOM FINISH SCHEDULE TO RECEIVE CERAMIC OR PORCELAIN TILE FINISH.

3. INSTALL BLOCKING OR BACKER MATERIAL FOR ATTACHMENT  $\prime$ MOUNTING OF WALL HUNG ITEMS OR EQUIPMENT DESCRIBED IN THE DOCUMENTS. ALL BLOCKING TO BE FIRE RETARDANT TREATED.

4. PARTITIONS THAT ARE REQUIRED TO EXTEND TO THE DECK ABOVE ARE TO HAVE THE GYPSUM BOARD CUT TO FIT WITHIN A 1/4" MAXIMUM TOLERANCE TO THE SHAPE OF THE DECK ABOVE. GYPSUM BOARD SHALL BE CONTINUOUSLY SEALED FOR THE FULL DEPTH OF THE GYPSUM BOARD WITH FLEXIBLE SEALANT.

15. PROVIDE METAL STRAPPING @ 24" VERT. TO HOLD BATT INSULATION FOR AREAS WITHOUT GYPSUM WALLBOARD. 6. GYPSUM BOARD IS TO BE CUT SO THAT THE CLEARANCE BETWEEN METALLIC ELECTRICAL OUTLET BOXES AND THE

GYPSUM BOARD DOES NOT EXCEED 1/8". 7. THE BOTTOM OF THE GYPSUM BOARD AT INTERIOR PARTITIONS IS TO BE 1/4" MINIMUM AND 1/2" MAXIMUM ABOVE THE FLOOR STRUCTURE AND IS TO BE SEALED FOR THE FULL DEPTH OF

THE GYPSUM BOARD WITH FLEXIBLE SEALANT. . AT WALLS WITH SOUND ATTENUATION BLANKETS PROVIDE SOUND ATTENUATION BLANKETS ON CEILING TO 2'-0" ON BOTH SIDES OF WALL EXCEPT AT WALLS WITH SOUND ATTENUATION

BLANKETS EXTENDING TO STRUCTURE. 19. REFER TO INTERIOR FINISH SCHEDULE FOR WALL FINISHES 20. REFER TO PARTITION TYPE MODIFIERS FOR STC RATED PARTITIONS

#### **PARTITION TYPE NOMENCLATURE**

PARTITION TYPE MODIFIER (WHERE APPLICABLE) PARTITION HEAD CONDITION PARTITION STRUCTURE SIZE (SEE SCHEDULE) PARTITION TYPE PARTITION RATING (WHERE APPLICABLE)

Р	ARTITION TYPE	S		Р	ARTITION HEAD	CONDITION	
M	CONCRETE	F	FURRING	Α	BOTTOM OF S	TRUCTURE	
	MASONRY UNIT (CMU)	W	WOOD STUD	В	6" ABOVE CEILING		
G	METAL STUD	Р	INSULATED	С	BOTTOM OF CEILING ABOVI		
S	SHAFTWALL		METAL PANEL (IMP)		PARTIAL HEIGI	HT	
Р	ARTITION STRU	JCT	URE WIDTH (FU	JRR	ING MEMBER *)		
#	METAL		WOOD		CMU	IMP	
0	*0-7/8"						
1	*1-1/2"						
2	2-1/2"		*1-1/2"			2"	
3	3-5/8"		2-1/2"			3"	
4	4"		3-1/2"		3-5/8"	4"	
6	6"		5-1/2"		5-5/8"	6"	
7						7"	
				_			

PARTITION TYPE MODIFIER
-------------------------

10"

12"

1	SOUND BATT MINIMUM STC RATING - 42	4	
2	GYPSUM BOARD - EXPOSED SIDE ONLY	5	
3	SOUND BATT & SMOKE PARTITION	6	

7-1/4"

9-1/4"

11-1/4"

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CONSULTANT

**CLIENT INFORMATION** 



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Bell City, LA 70630

**DRAWING ISSUE** 

DESIGNED BY: R. ELLIOTT DRAWN BY: U. MARGULL CHECKED BY: K. KOTELLOS SUBMITTED BY: C. CUSICK 02/12/2025

SHEET TITLE

PARTITION TYPES & DETAILS


PROJECT #:

A-005

ORIGINAL SHEET SIZE: 24" X 36"

7-5/8"

11-5/8"

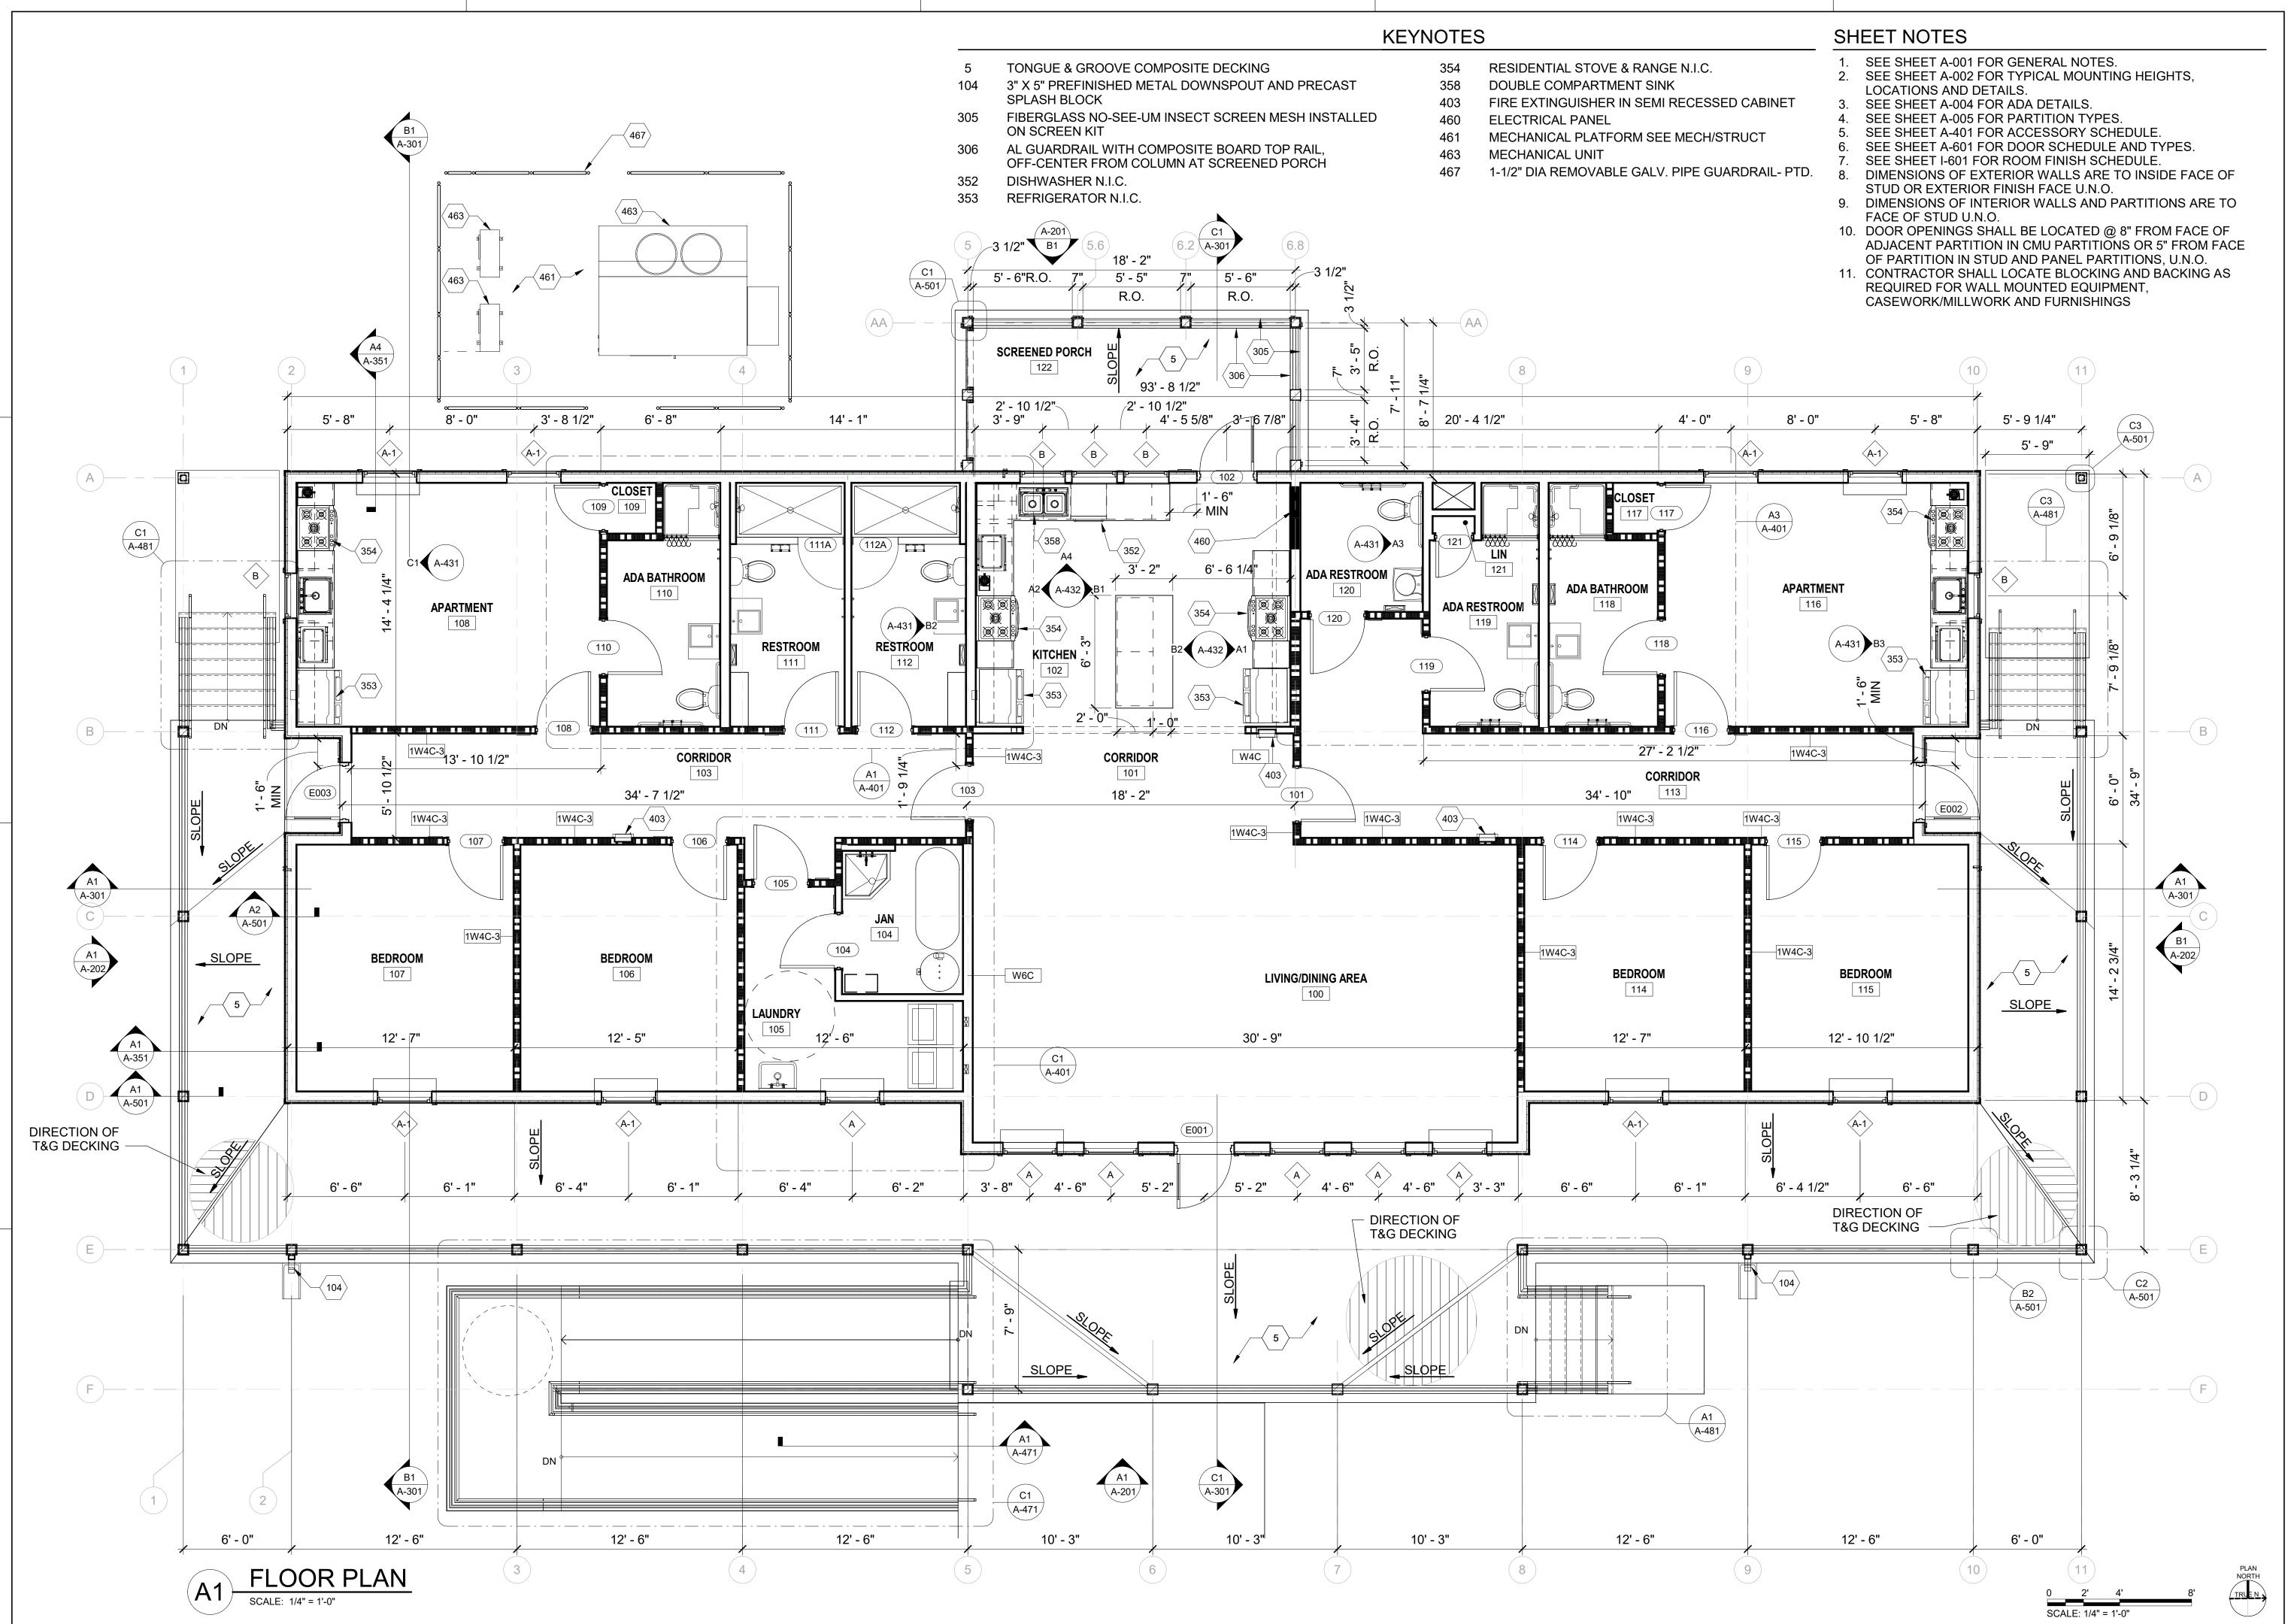

3500 Parkway Lane

Suite 500
Peachtree Corners
Georgia 30092

Georgia 30092

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EOR/AOR SEAL

CONSULTANT

CLIENT INFORMATION

U.S.
FISH & WILDLIFE
SERVICE

US Fish & Wildlife Service

PROJECT NAME

Cameron Prairie National Wildlife Refuge Bunkhouse

> LA-27 Bell City, LA 70630

DRAWING ISSUE


DESCRIPTION

DESIGNED BY: R. ELLIOTT
DRAWN BY: U. MARGULL
CHECKED BY: K. KOTELLOS
SUBMITTED BY: C. CUSICK
DATE: 02/12/2025
PROJECT #: 1220834

SHEET TITLE

FLOOR PLAN

A-101

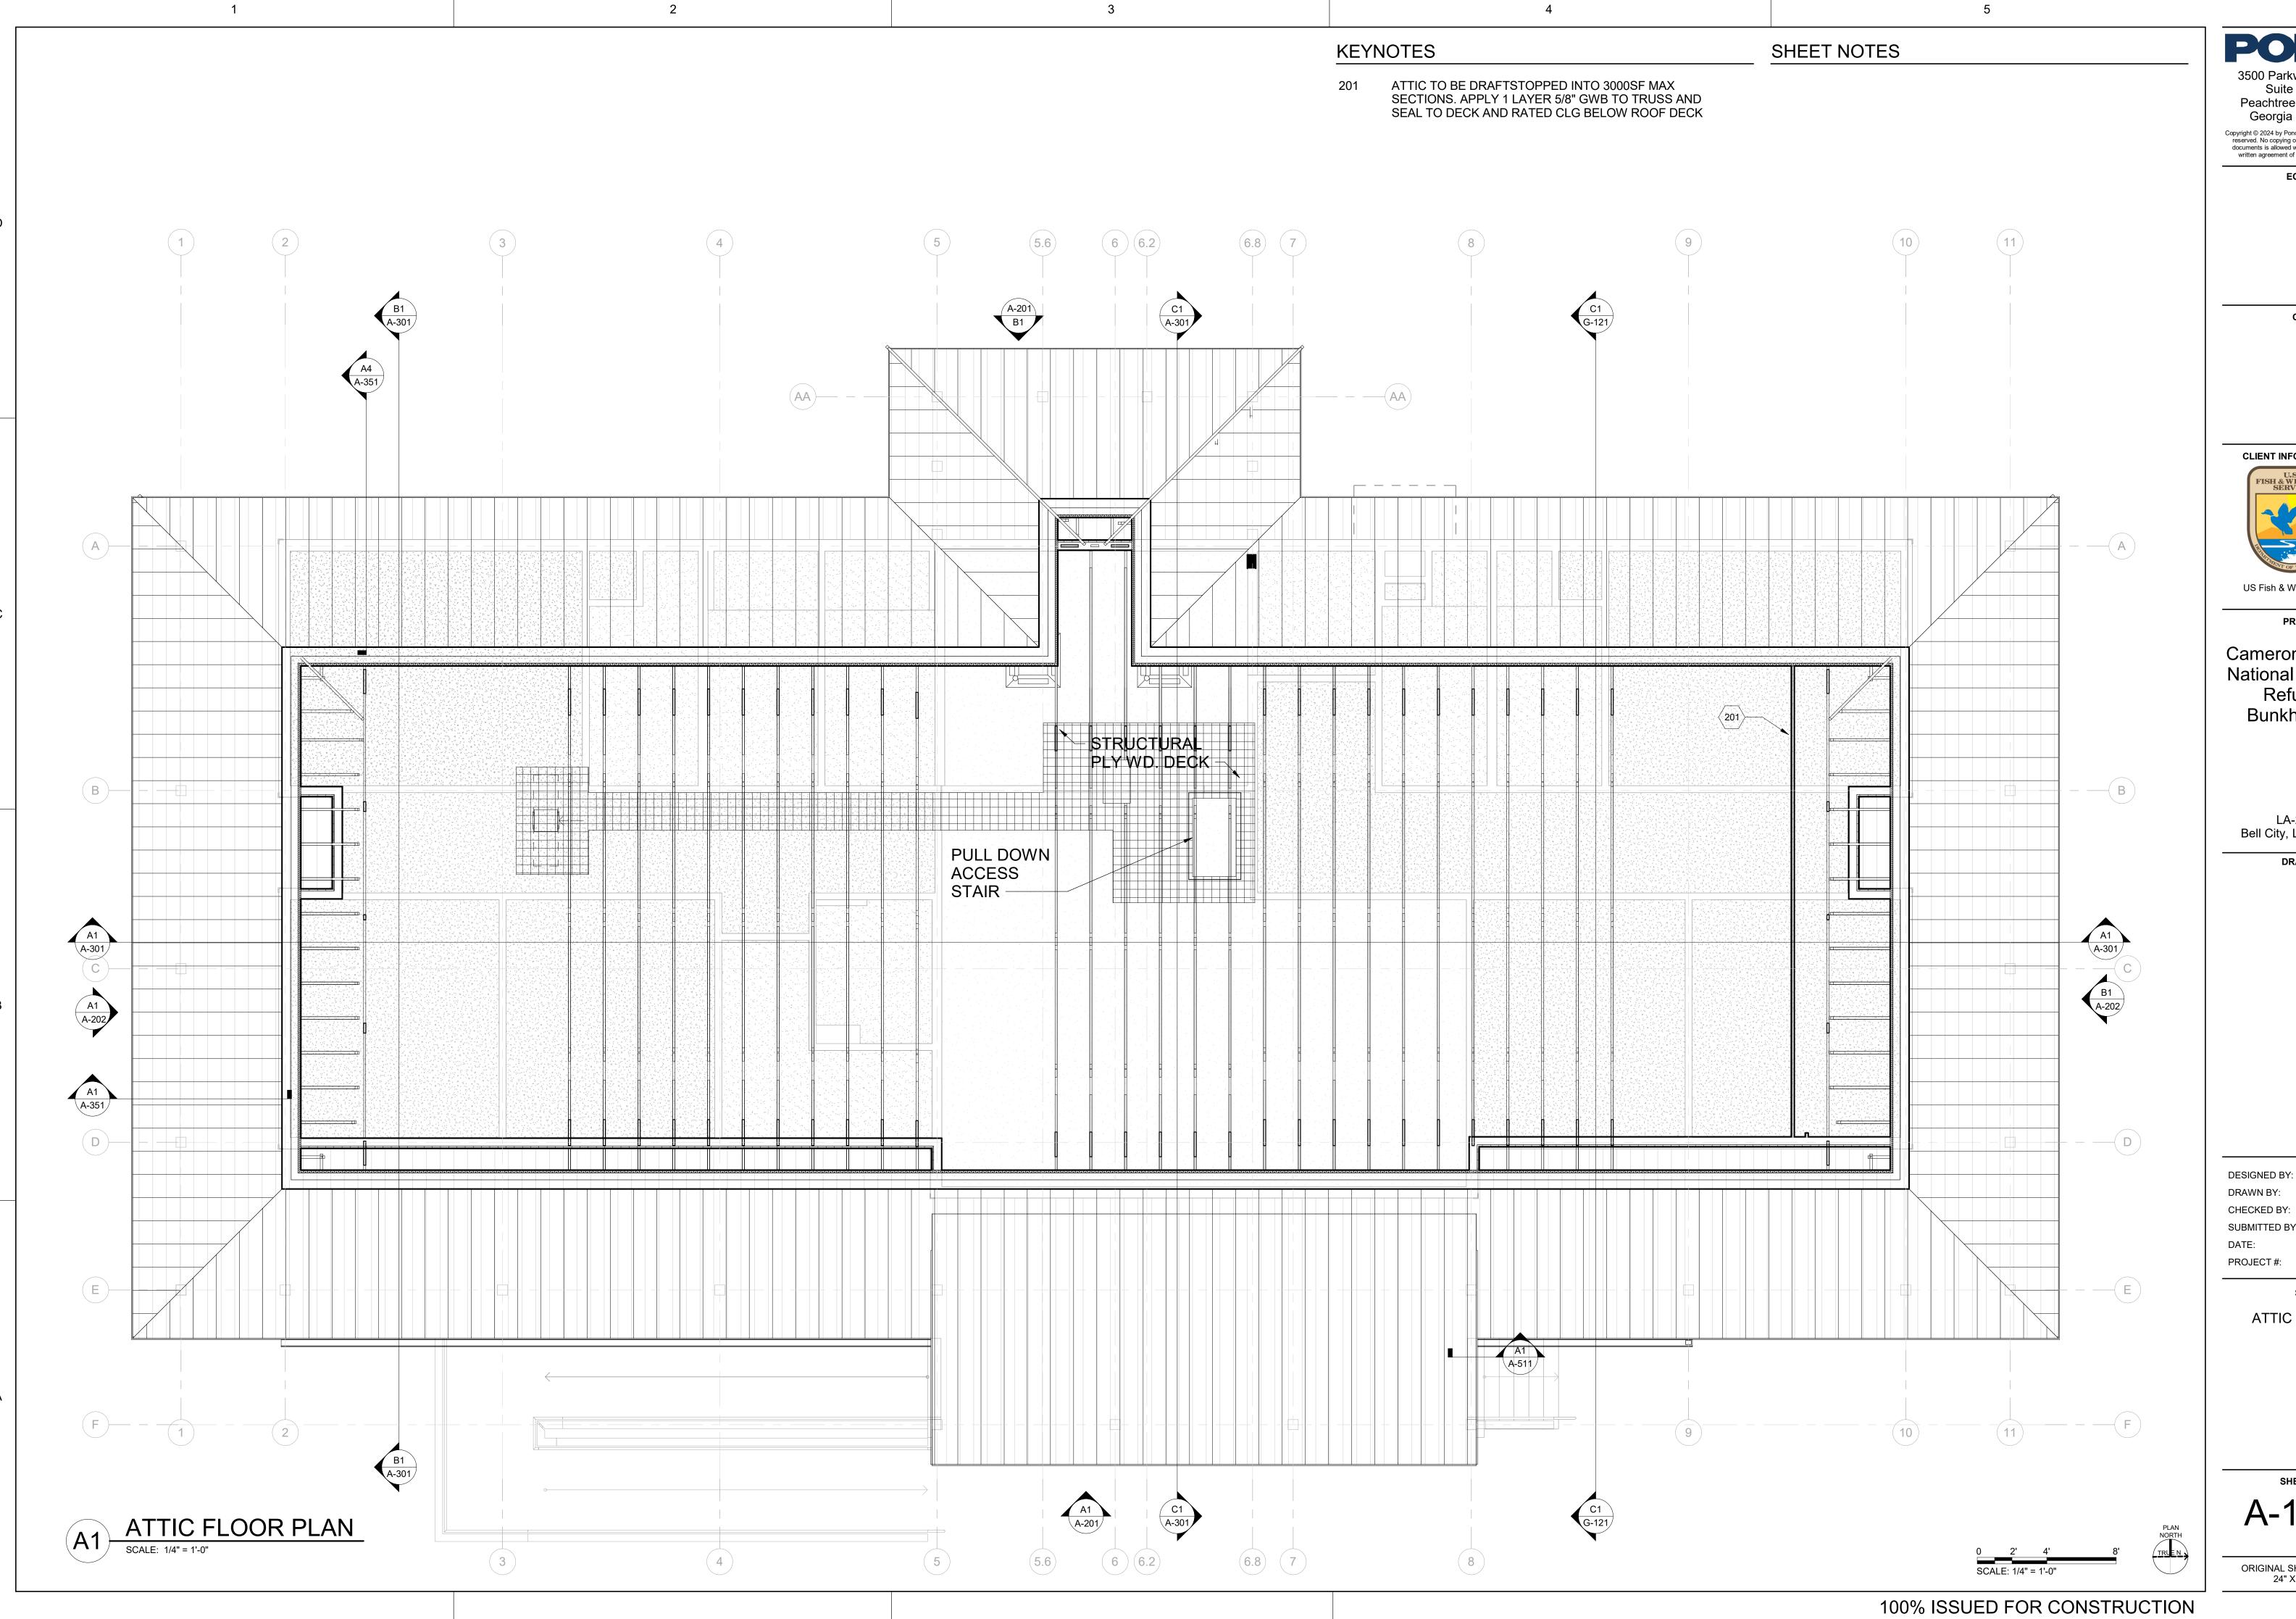

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PROJECT NAME

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LA-27 Bell City, LA 70630


DRAWING ISSUE

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SHEET TITLE

ATTIC PLAN

A-111

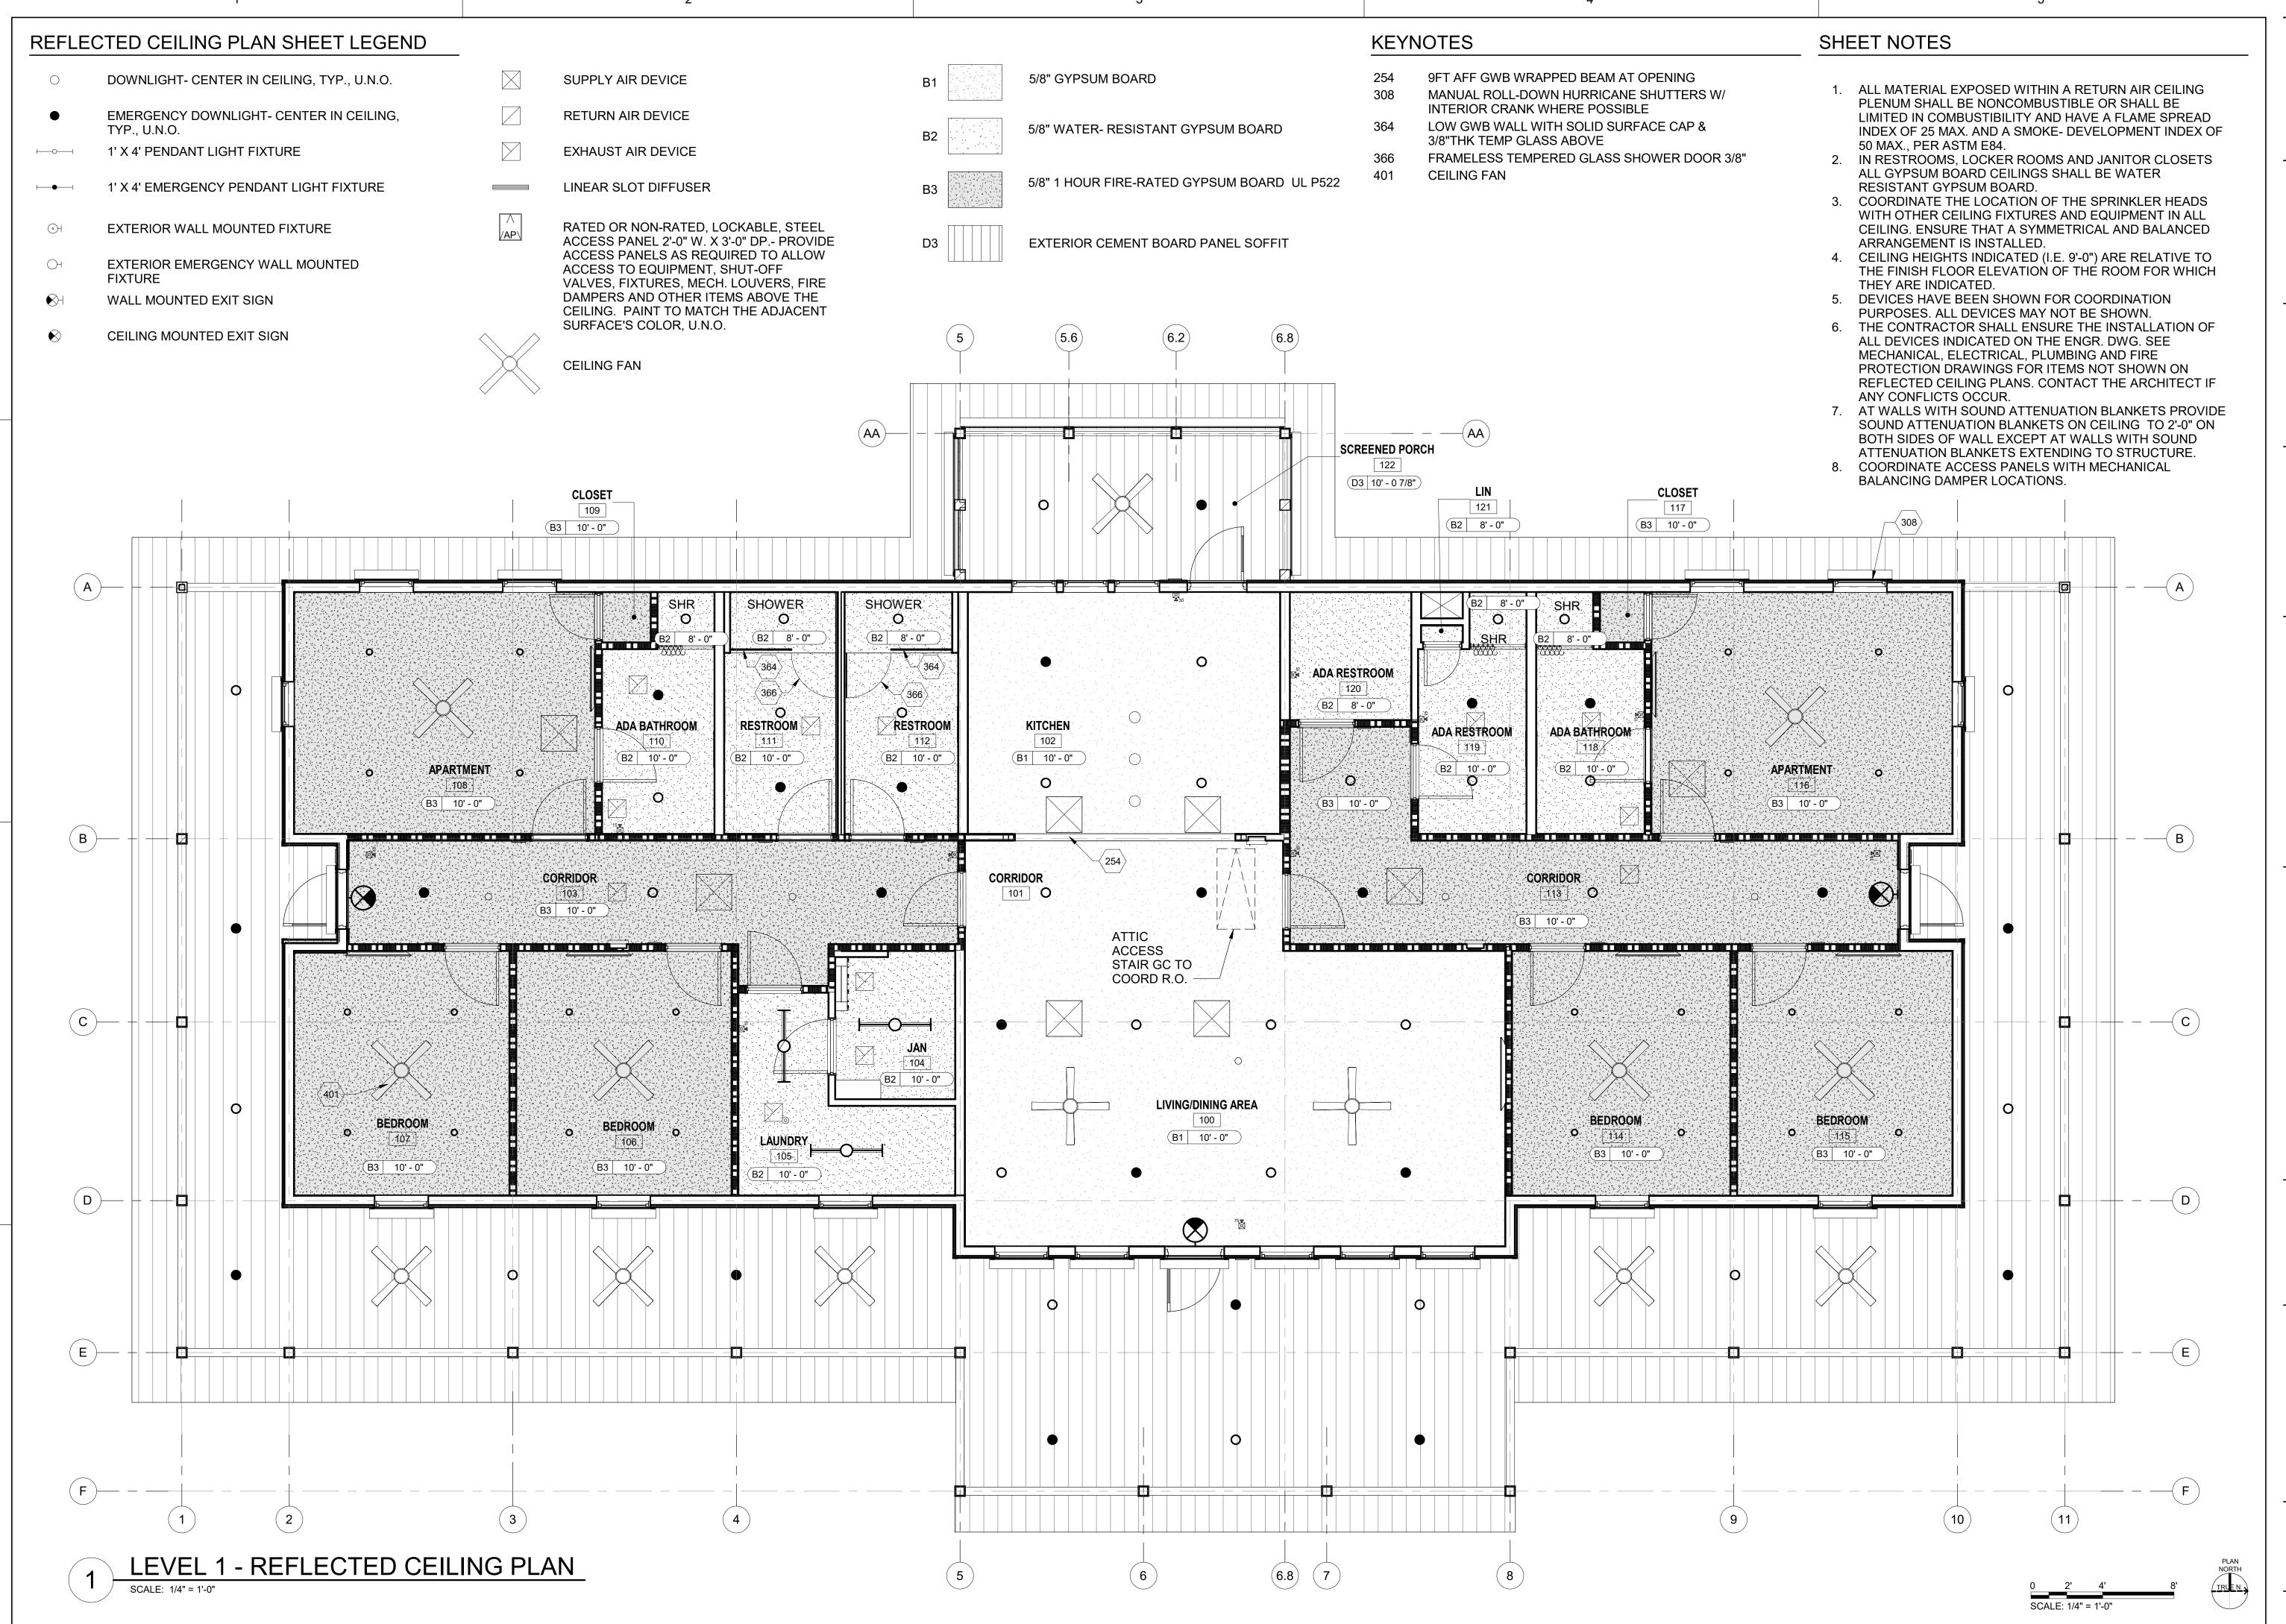

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U.S.
FISH & WILDLIFE
SERVICE

US Fish & Wildlife Service

PROJECT NAME

Cameron Prairie
National Wildlife
Refuge
Bunkhouse

LA-27 Bell City, LA 70630

DRAWING ISSUE

DESCRIPTION

DESIGNED BY: R. ELLIOTT
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CHECKED BY: K. KOTELLOS
SUBMITTED BY: C. CUSICK


SHEET TITLE

02/12/2025

REFLECTED CEILING PLAN

PROJECT #:

SHEET NUM

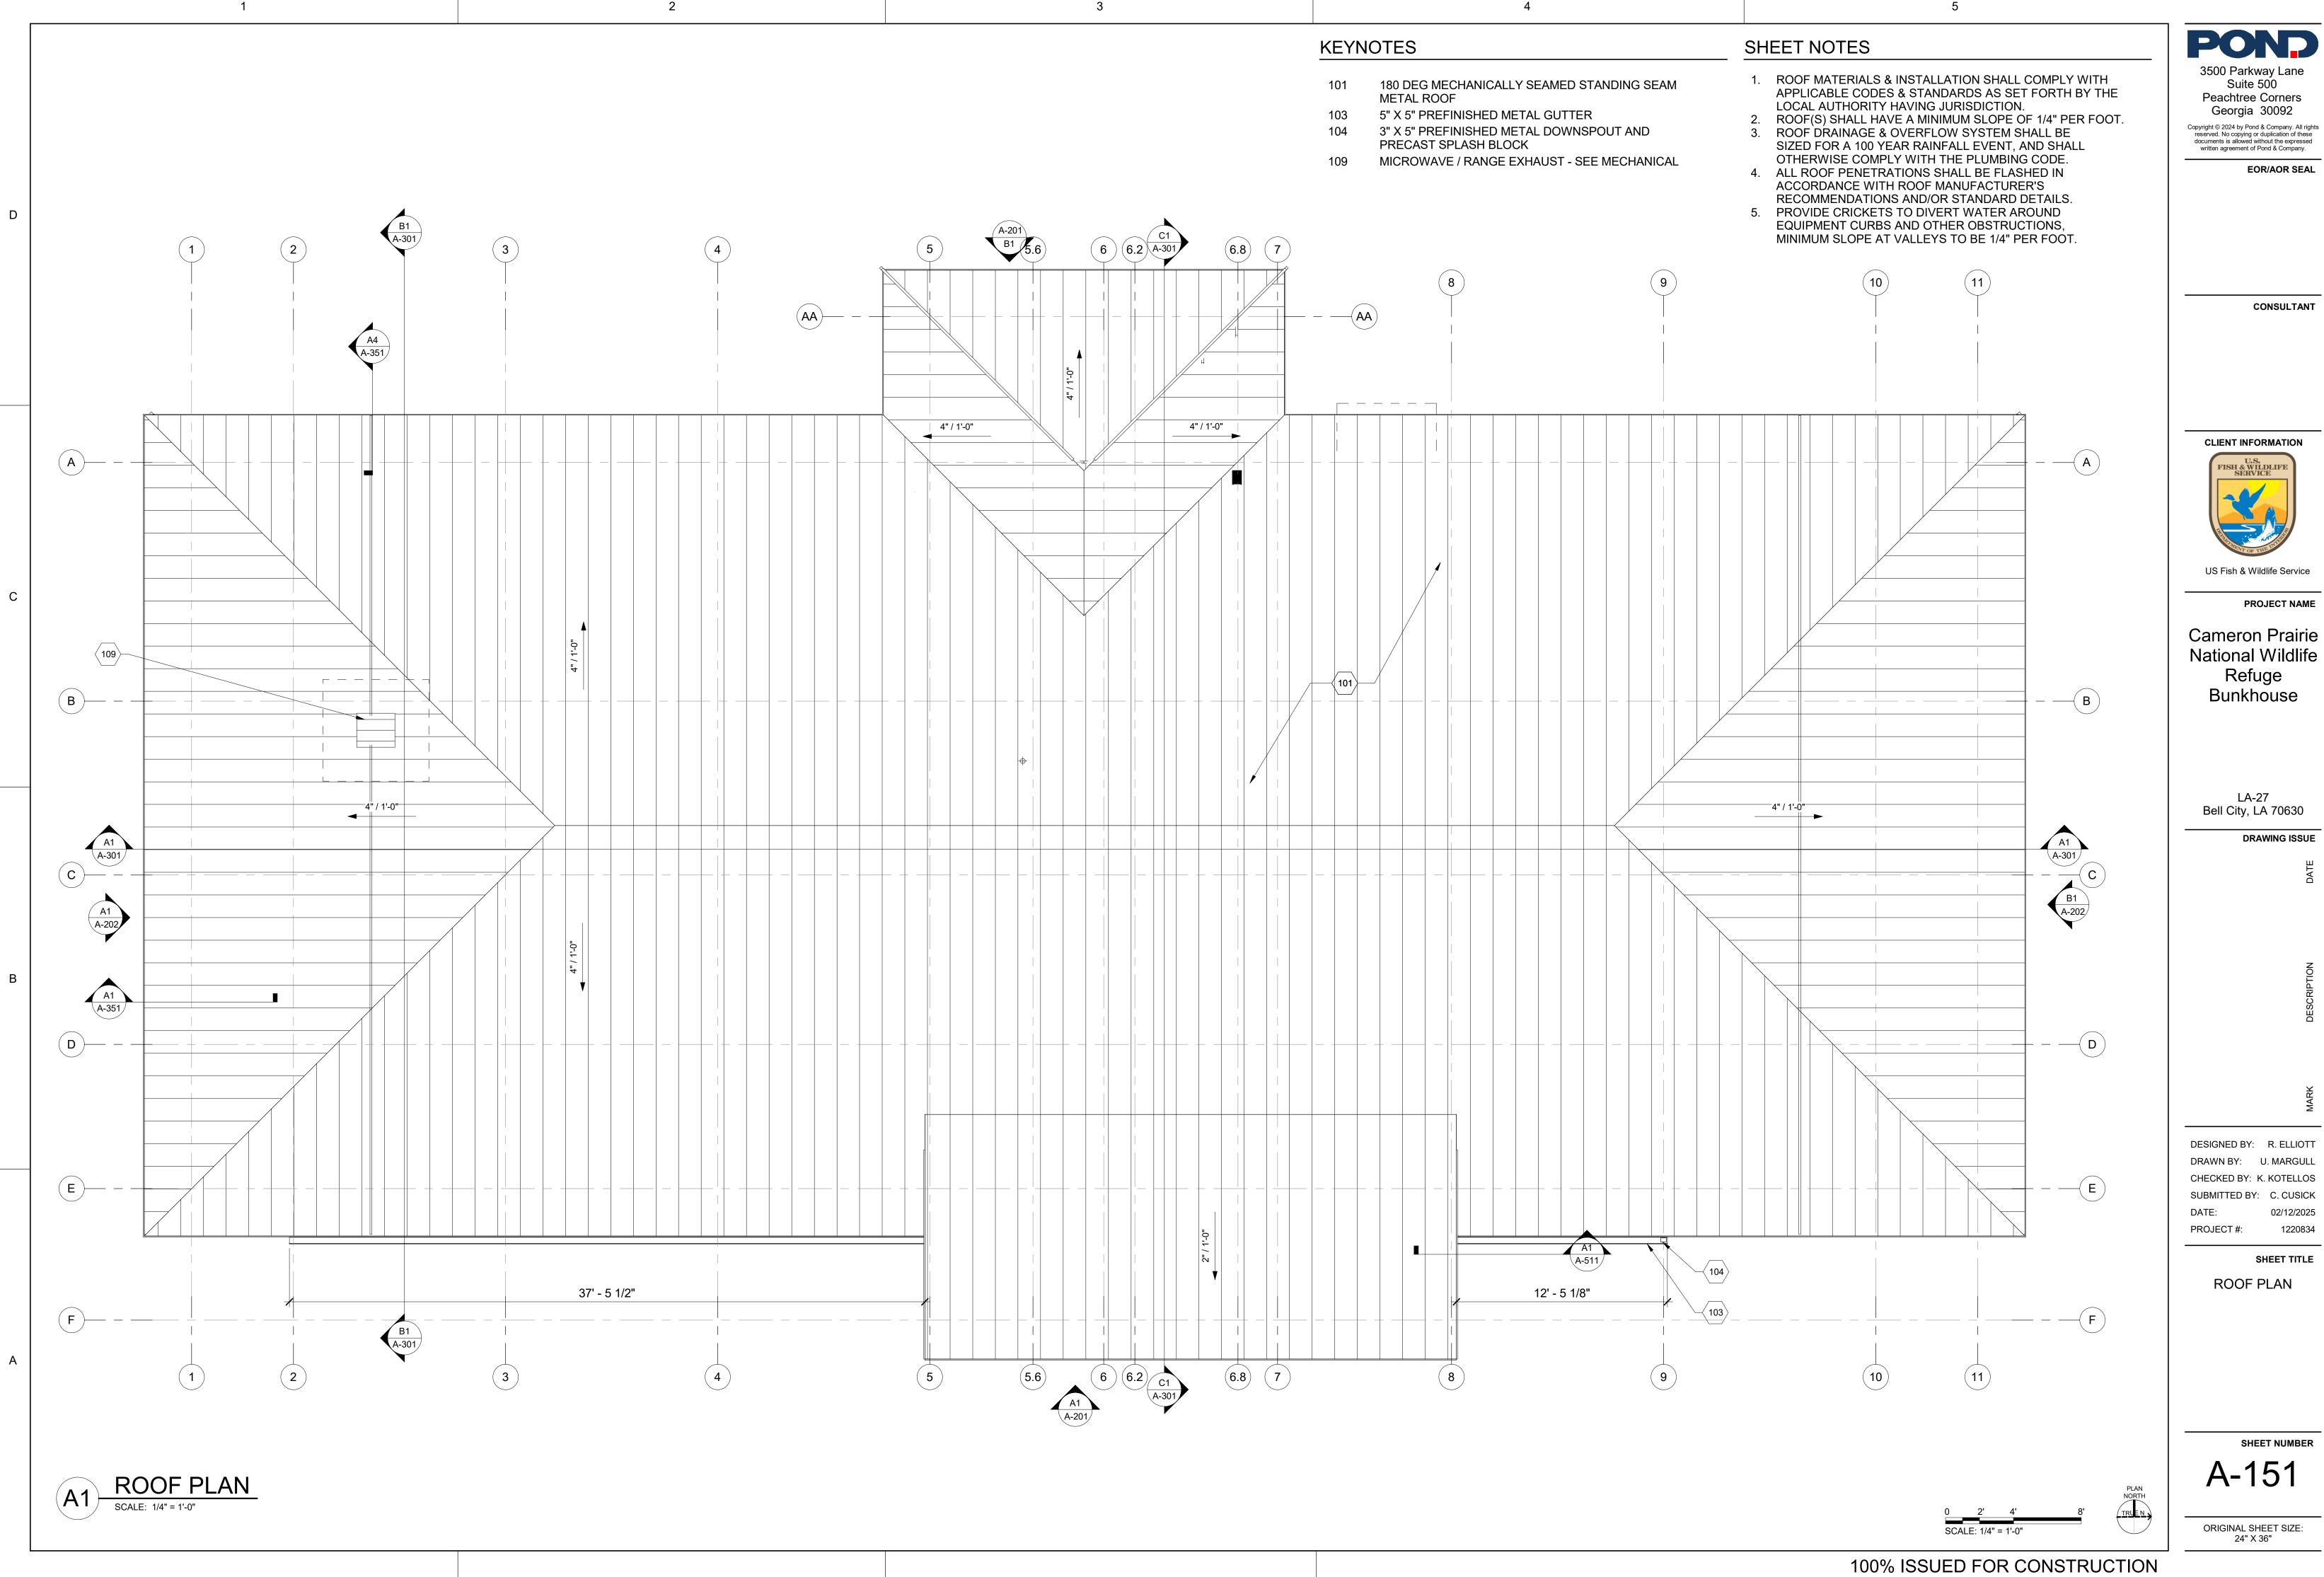

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**EOR/AOR SEAL** 

Suite 500

CLIENT INFORMATION

US Fish & Wildlife Service

**PROJECT NAME** 

**Cameron Prairie** National Wildlife Refuge Bunkhouse

> LA-27 Bell City, LA 70630

DRAWING ISSUE


DESIGNED BY: R. ELLIOTT DRAWN BY: U. MARGULL

CHECKED BY: K. KOTELLOS SUBMITTED BY: C. CUSICK 02/12/2025 PROJECT #:

SHEET TITLE

**ROOF PLAN** 

A-151

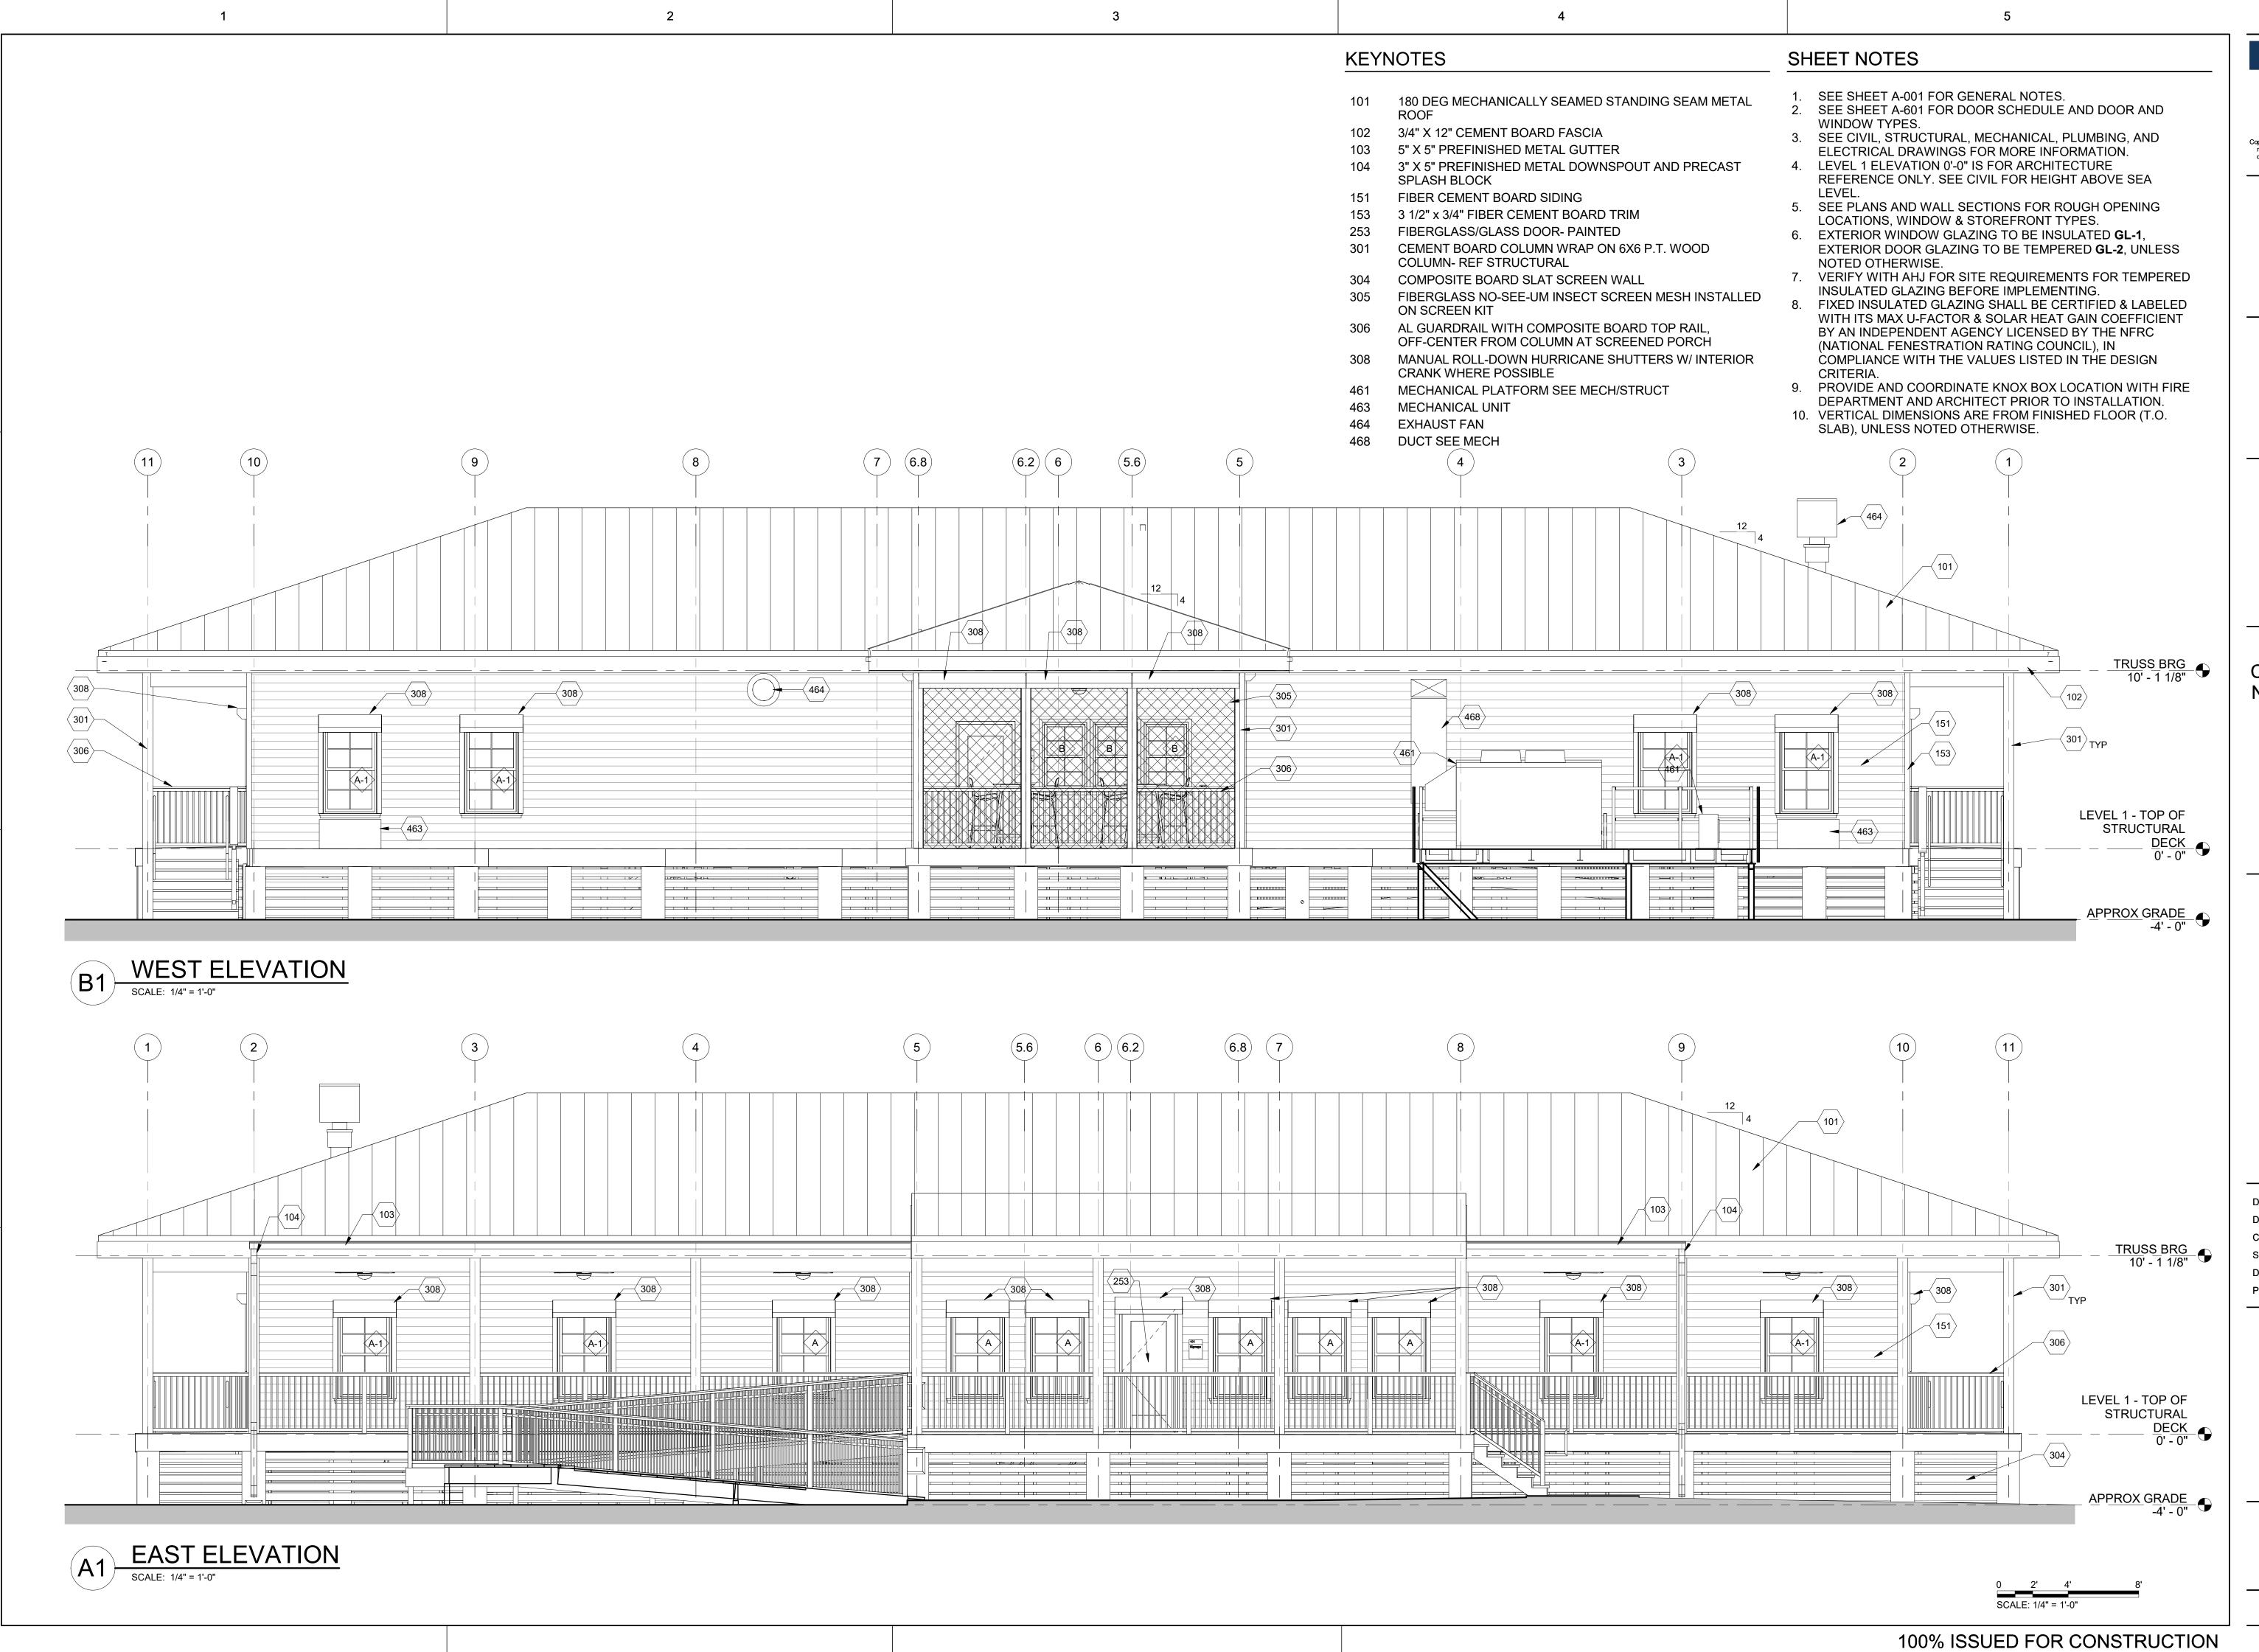

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**PROJECT NAME** 

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> LA-27 Bell City, LA 70630

**DRAWING ISSUE** 

DESIGNED BY: R. ELLIOTT DRAWN BY: U. MARGULL CHECKED BY: K. KOTELLOS SUBMITTED BY: C. CUSICK 02/12/2025 PROJECT #:

SHEET TITLE

**EXTERIOR ELEVATIONS** 

A-201

ORIGINAL SHEET SIZE:

24" X 36"

#### SHEET NOTES

- 1. SEE SHEET A-001 FOR GENERAL NOTES.
- 2. SEE SHEET A-601 FOR DOOR SCHEDULE AND DOOR AND
- WINDOW TYPES.

  3. SEE CIVIL, STRUCTURAL, MECHANICAL, PLUMBING, AND ELECTRICAL DRAWINGS FOR MORE INFORMATION.
- 4. LEVEL 1 ELEVATION 0'-0" IS FOR ARCHITECTURE REFERENCE ONLY. SEE CIVIL FOR HEIGHT ABOVE SEA
- SEE PLANS AND WALL SECTIONS FOR ROUGH OPENING LOCATIONS, WINDOW & STOREFRONT TYPES.
- 6. EXTERIOR WINDOW GLAZING TO BE INSULATED **GL-1**, EXTERIOR DOOR GLAZING TO BE TEMPERED **GL-2**, UNLESS NOTED OTHERWISE.
- 7. VERIFY WITH AHJ FOR SITE REQUIREMENTS FOR TEMPERED INSULATED GLAZING BEFORE IMPLEMENTING.
- 8. FIXED INSULATED GLAZING SHALL BE CERTIFIED & LABELED WITH ITS MAX U-FACTOR & SOLAR HEAT GAIN COEFFICIENT BY AN INDEPENDENT AGENCY LICENSED BY THE NFRC (NATIONAL FENESTRATION RATING COUNCIL), IN COMPLIANCE WITH THE VALUES LISTED IN THE DESIGN
- 9. PROVIDE AND COORDINATE KNOX BOX LOCATION WITH FIRE DEPARTMENT AND ARCHITECT PRIOR TO INSTALLATION.
- 10. VERTICAL DIMENSIONS ARE FROM FINISHED FLOOR (T.O. SLAB), UNLESS NOTED OTHERWISE.

#### # KEYNOTES

- 101 180 DEG MECHANICALLY SEAMED STANDING SEAM METAL ROOF
- 22 3/4" X 12" CEMENT BOARD FASCIA
- 103 5" X 5" PREFINISHED METAL GUTTER
- 104 3" X 5" PREFINISHED METAL DOWNSPOUT AND
- PRECAST SPLASH BLOCK
- 151 FIBER CEMENT BOARD SIDING153 3 1/2" x 3/4" FIBER CEMENT BOARD TRIM
- 253 FIBERGLASS/GLASS DOOR- PAINTED
- 301 CEMENT BOARD COLUMN WRAP ON 6X6 P.T. WOOD
- COLUMN- REF STRUCTURAL
- 303 2X12 P.T. ADA RAMP- PTD.
- 304 COMPOSITE BOARD SLAT SCREEN WALL
   305 FIBERGLASS NO-SEE-UM INSECT SCREEN MESH
  - INSTALLED ON SCREEN KIT
- 306 AL GUARDRAIL WITH COMPOSITE BOARD TOP RAIL, OFF-CENTER FROM COLUMN AT SCREENED PORCH
- 308 MANUAL ROLL-DOWN HURRICANE SHUTTERS W/
- INTERIOR CRANK WHERE POSSIBLE

  COMPOSITE BOARD SLAT SCREEN WITH
- FIBERGLASS NO-SEE-UM INSECT SCREEN
- MECHANICAL PLATFORM SEE MECH/STRUCT EXHAUST FAN
- 5 EXHAUST LOUVER



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**EOR/AOR SEAL** 

CONSULTANT

US Fish & Wildlife Service

PROJECT NAME

Cameron Prairie
National Wildlife
Refuge
Bunkhouse

LA-27 Bell City, LA 70630

DRAWING ISSUE

NOIFGIGOOG

DESIGNED BY: R. ELLIOTT
DRAWN BY: U. MARGULL
CHECKED BY: K. KOTELLOS

SUBMITTED BY: C. CUSICK
DATE: 02/12/2025
PROJECT#: 1220834


EXTERIOR

**ELEVATIONS** 

SHEET TITLE


A-202

ORIGINAL SHEET SIZE: 24" X 36"

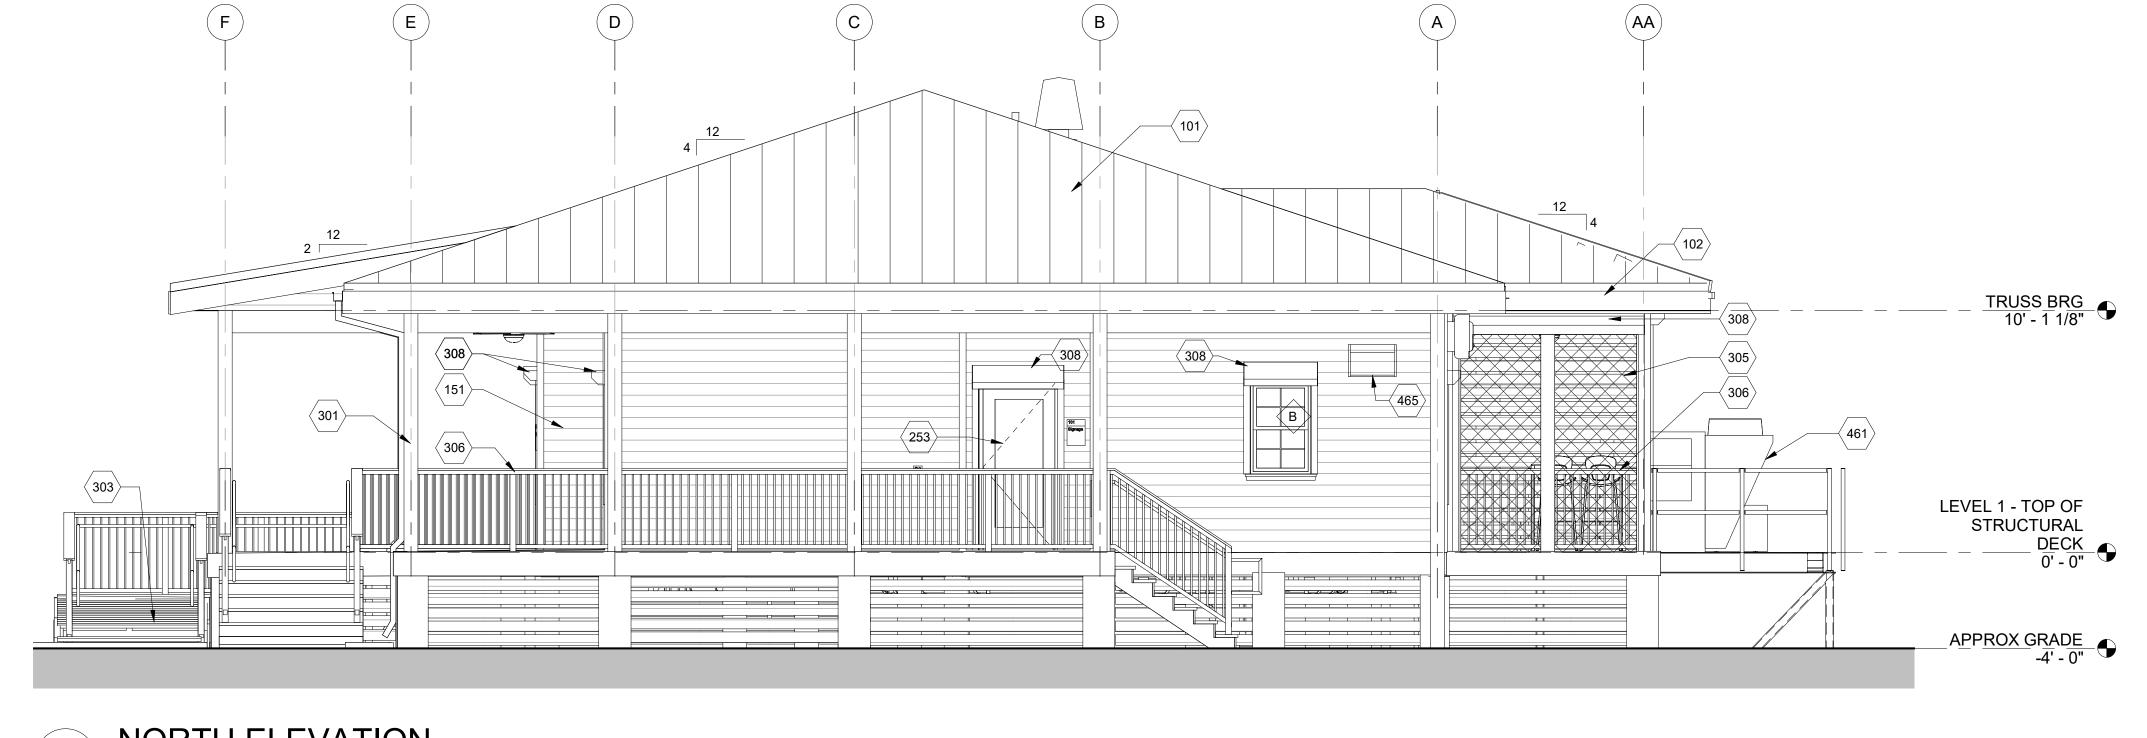


NORTH ELEVATION

SCALE: 1/4" = 1'-0"

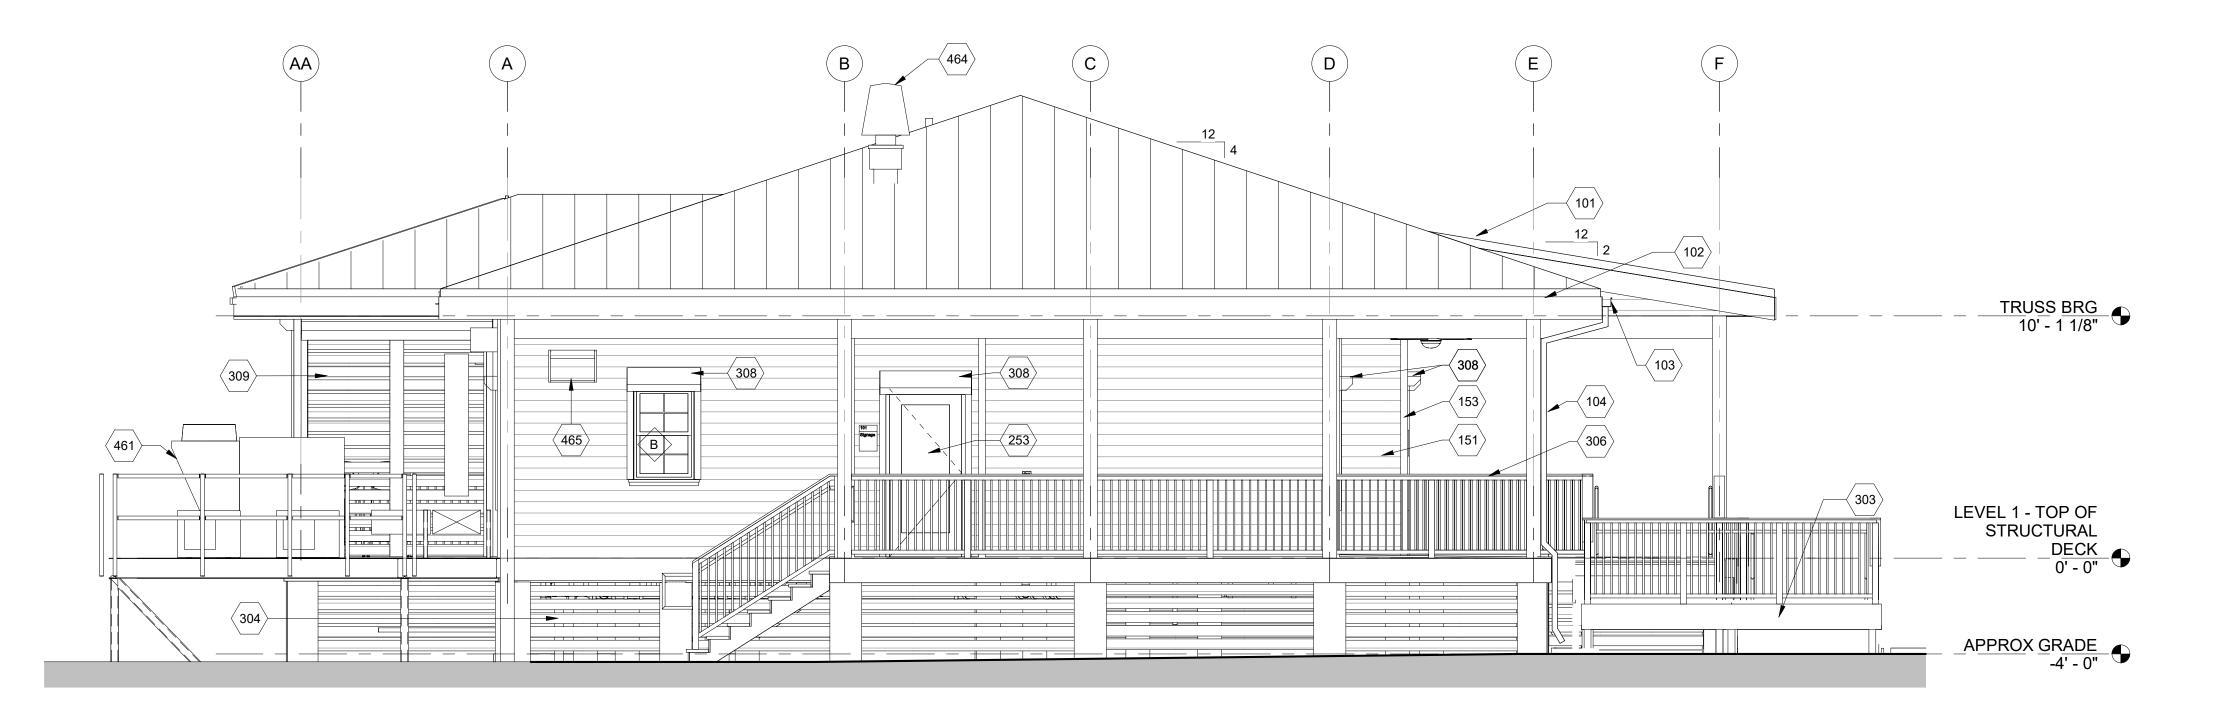

A1 SOUTH ELEVATION

SCALE: 1/4" = 1'-0"

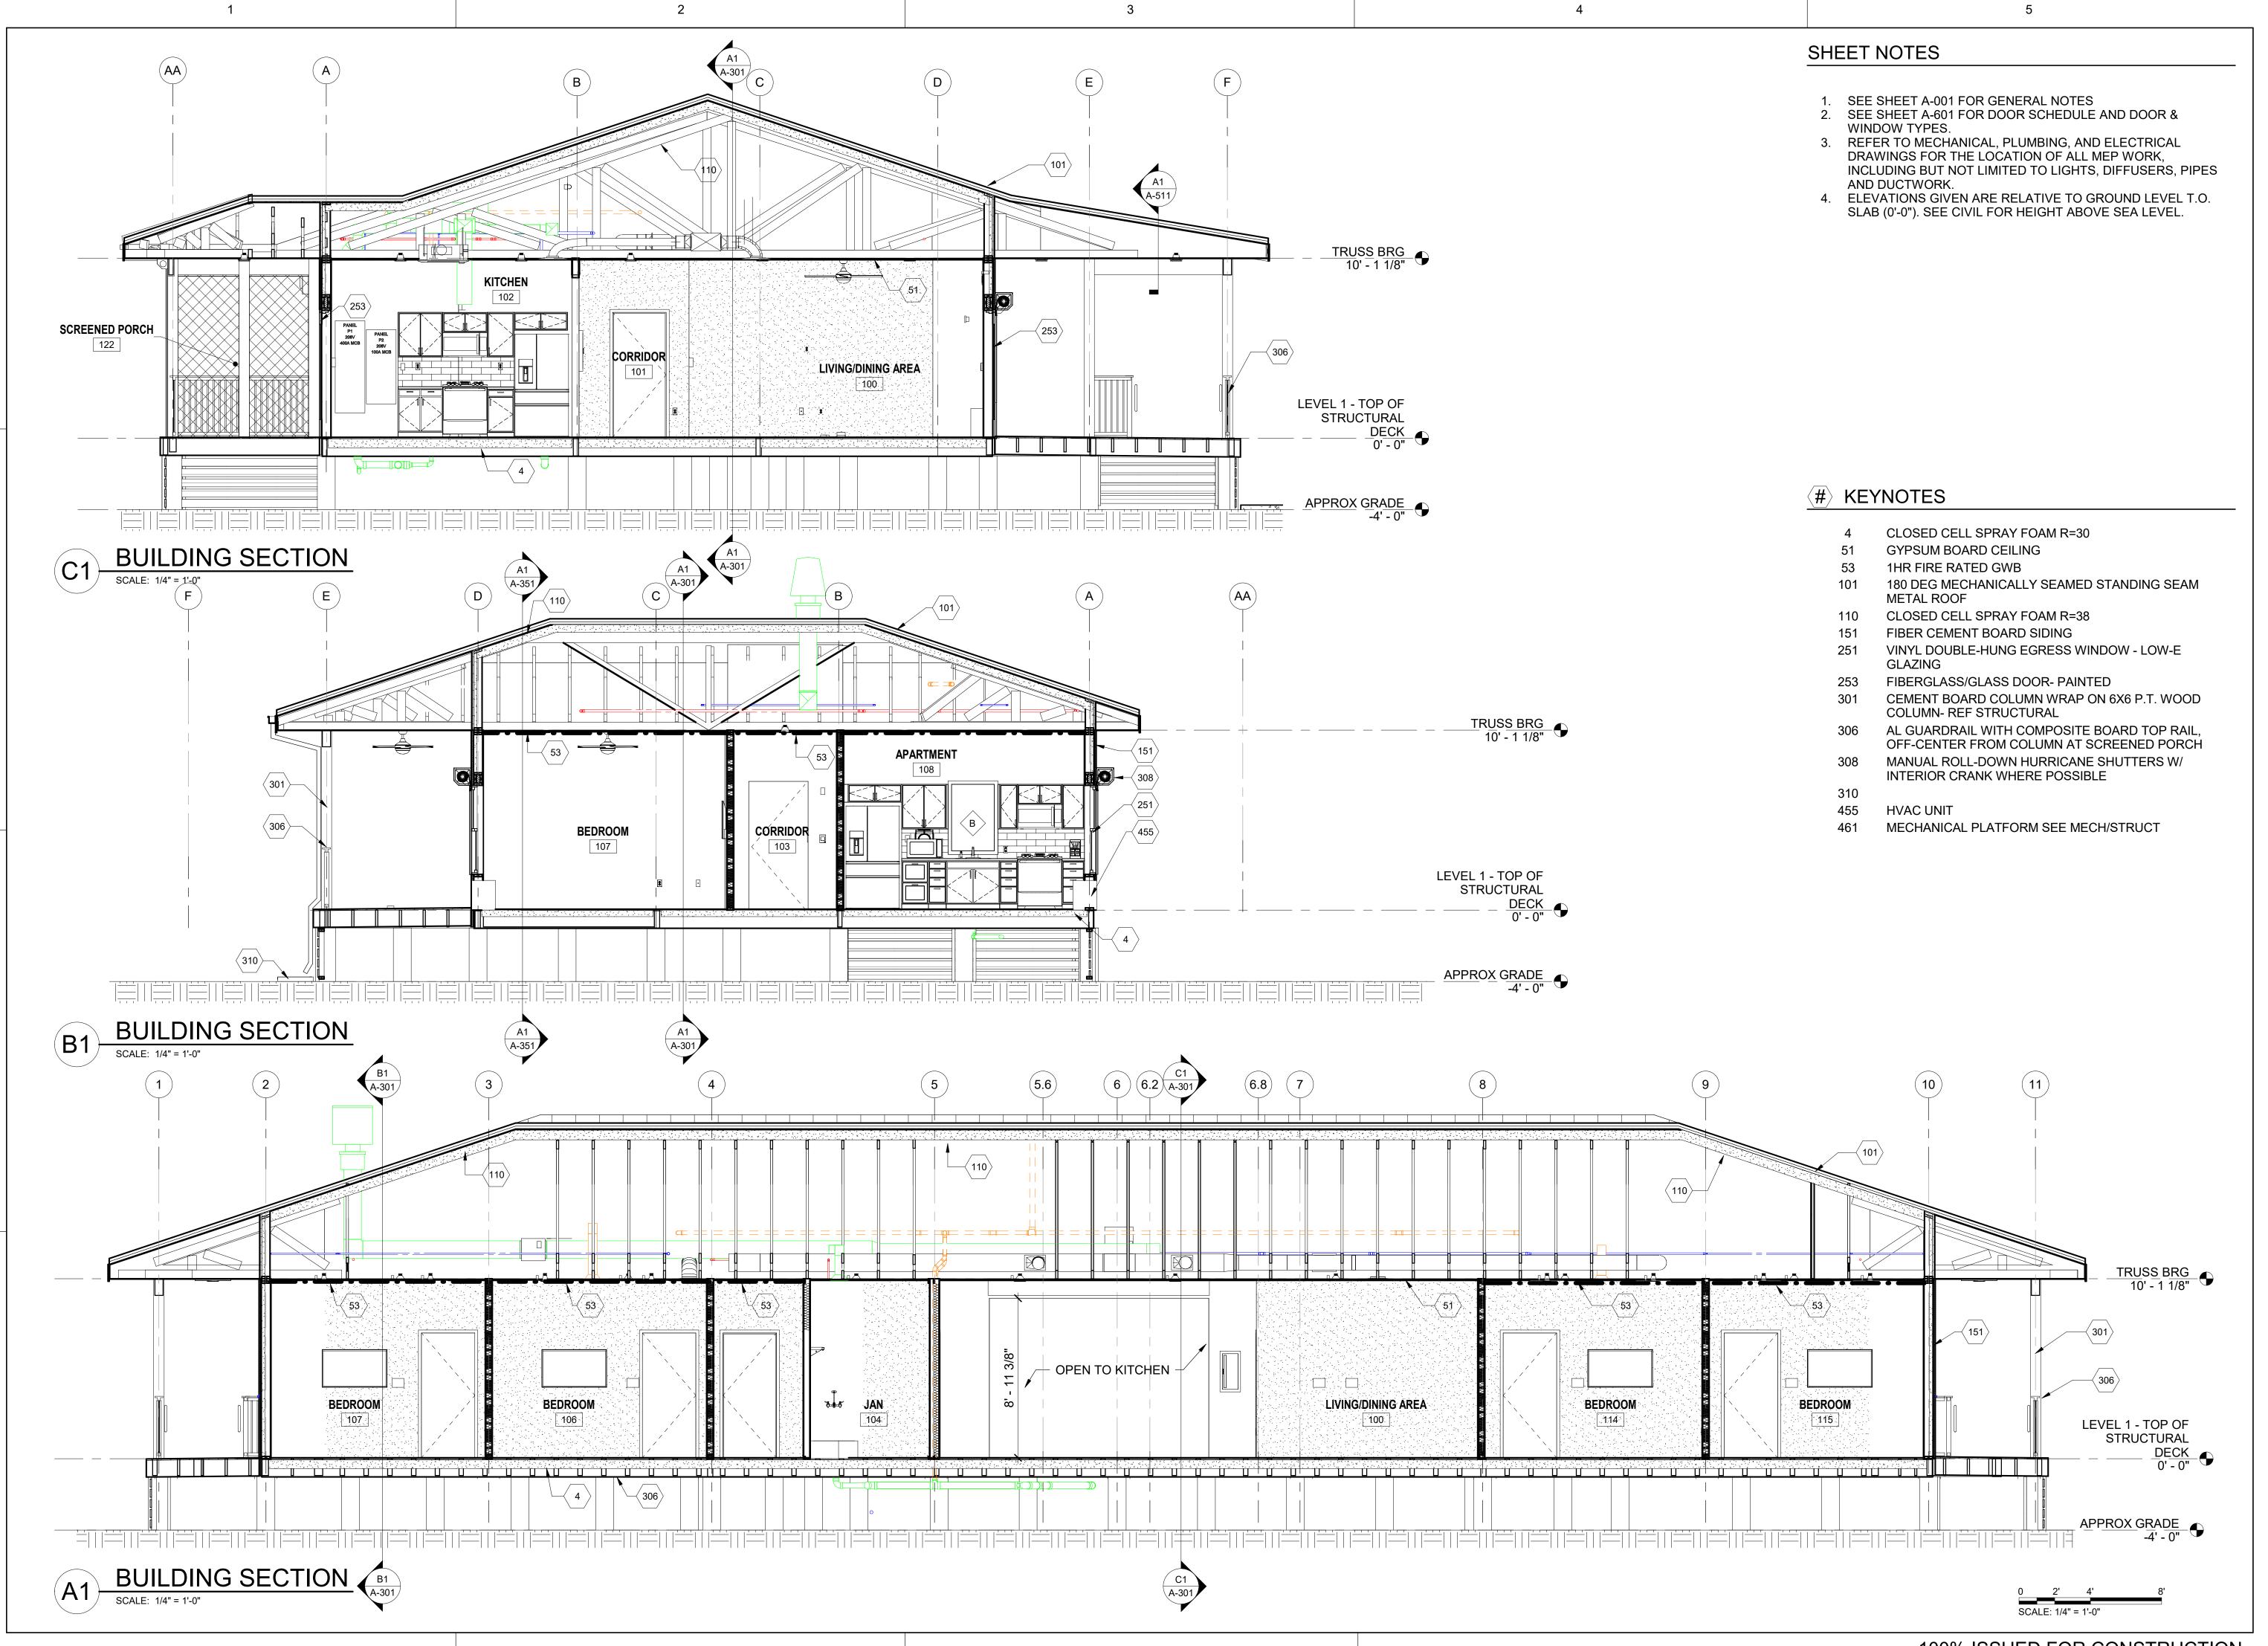

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**PROJECT NAME** 

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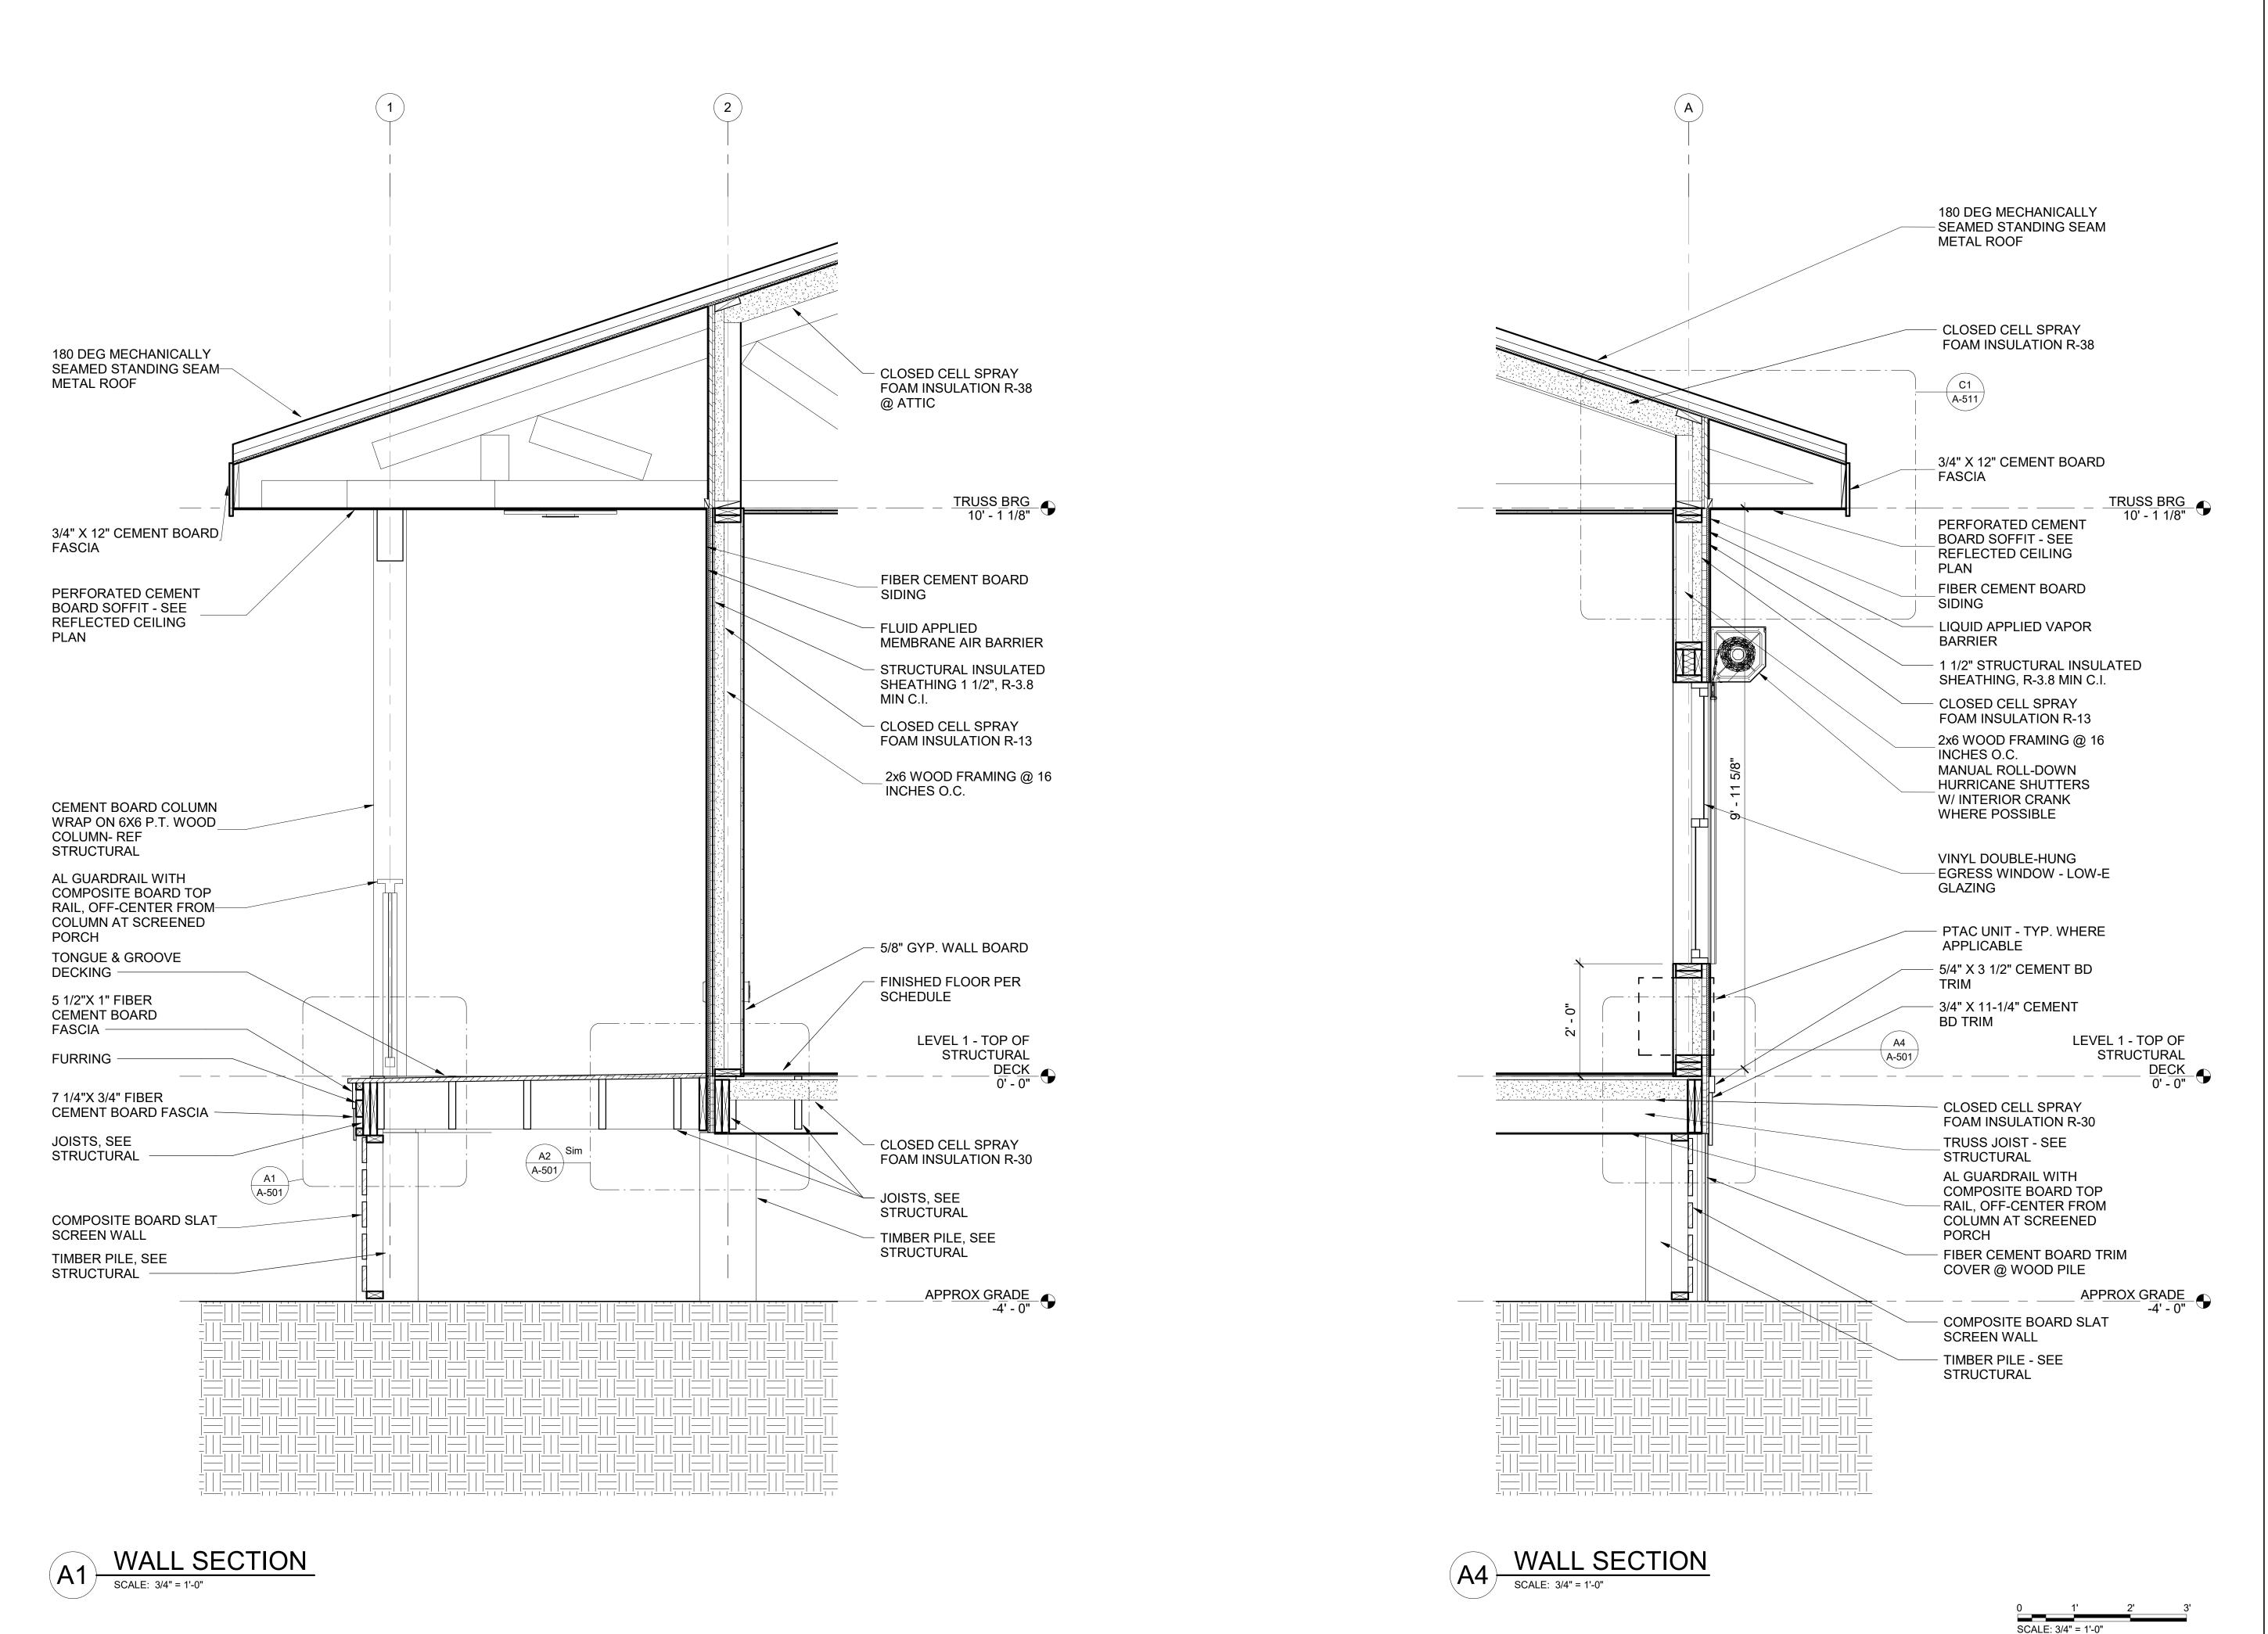
**DRAWING ISSUE** 

DESIGNED BY: R. ELLIOTT DRAWN BY: U. MARGULL CHECKED BY: K. KOTELLOS SUBMITTED BY: C. CUSICK 02/12/2025 PROJECT #:

SHEET TITLE

BUILDING SECTIONS

A-301



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> LA-27 Bell City, LA 70630

**DRAWING ISSUE** 


DESIGNED BY: R. ELLIOTT DRAWN BY: U. MARGULL CHECKED BY: K. KOTELLOS SUBMITTED BY: C. CUSICK 02/12/2025 PROJECT #: 1220834

SHEET TITLE

WALL SECTIONS

SHEET NUMBER

A-351

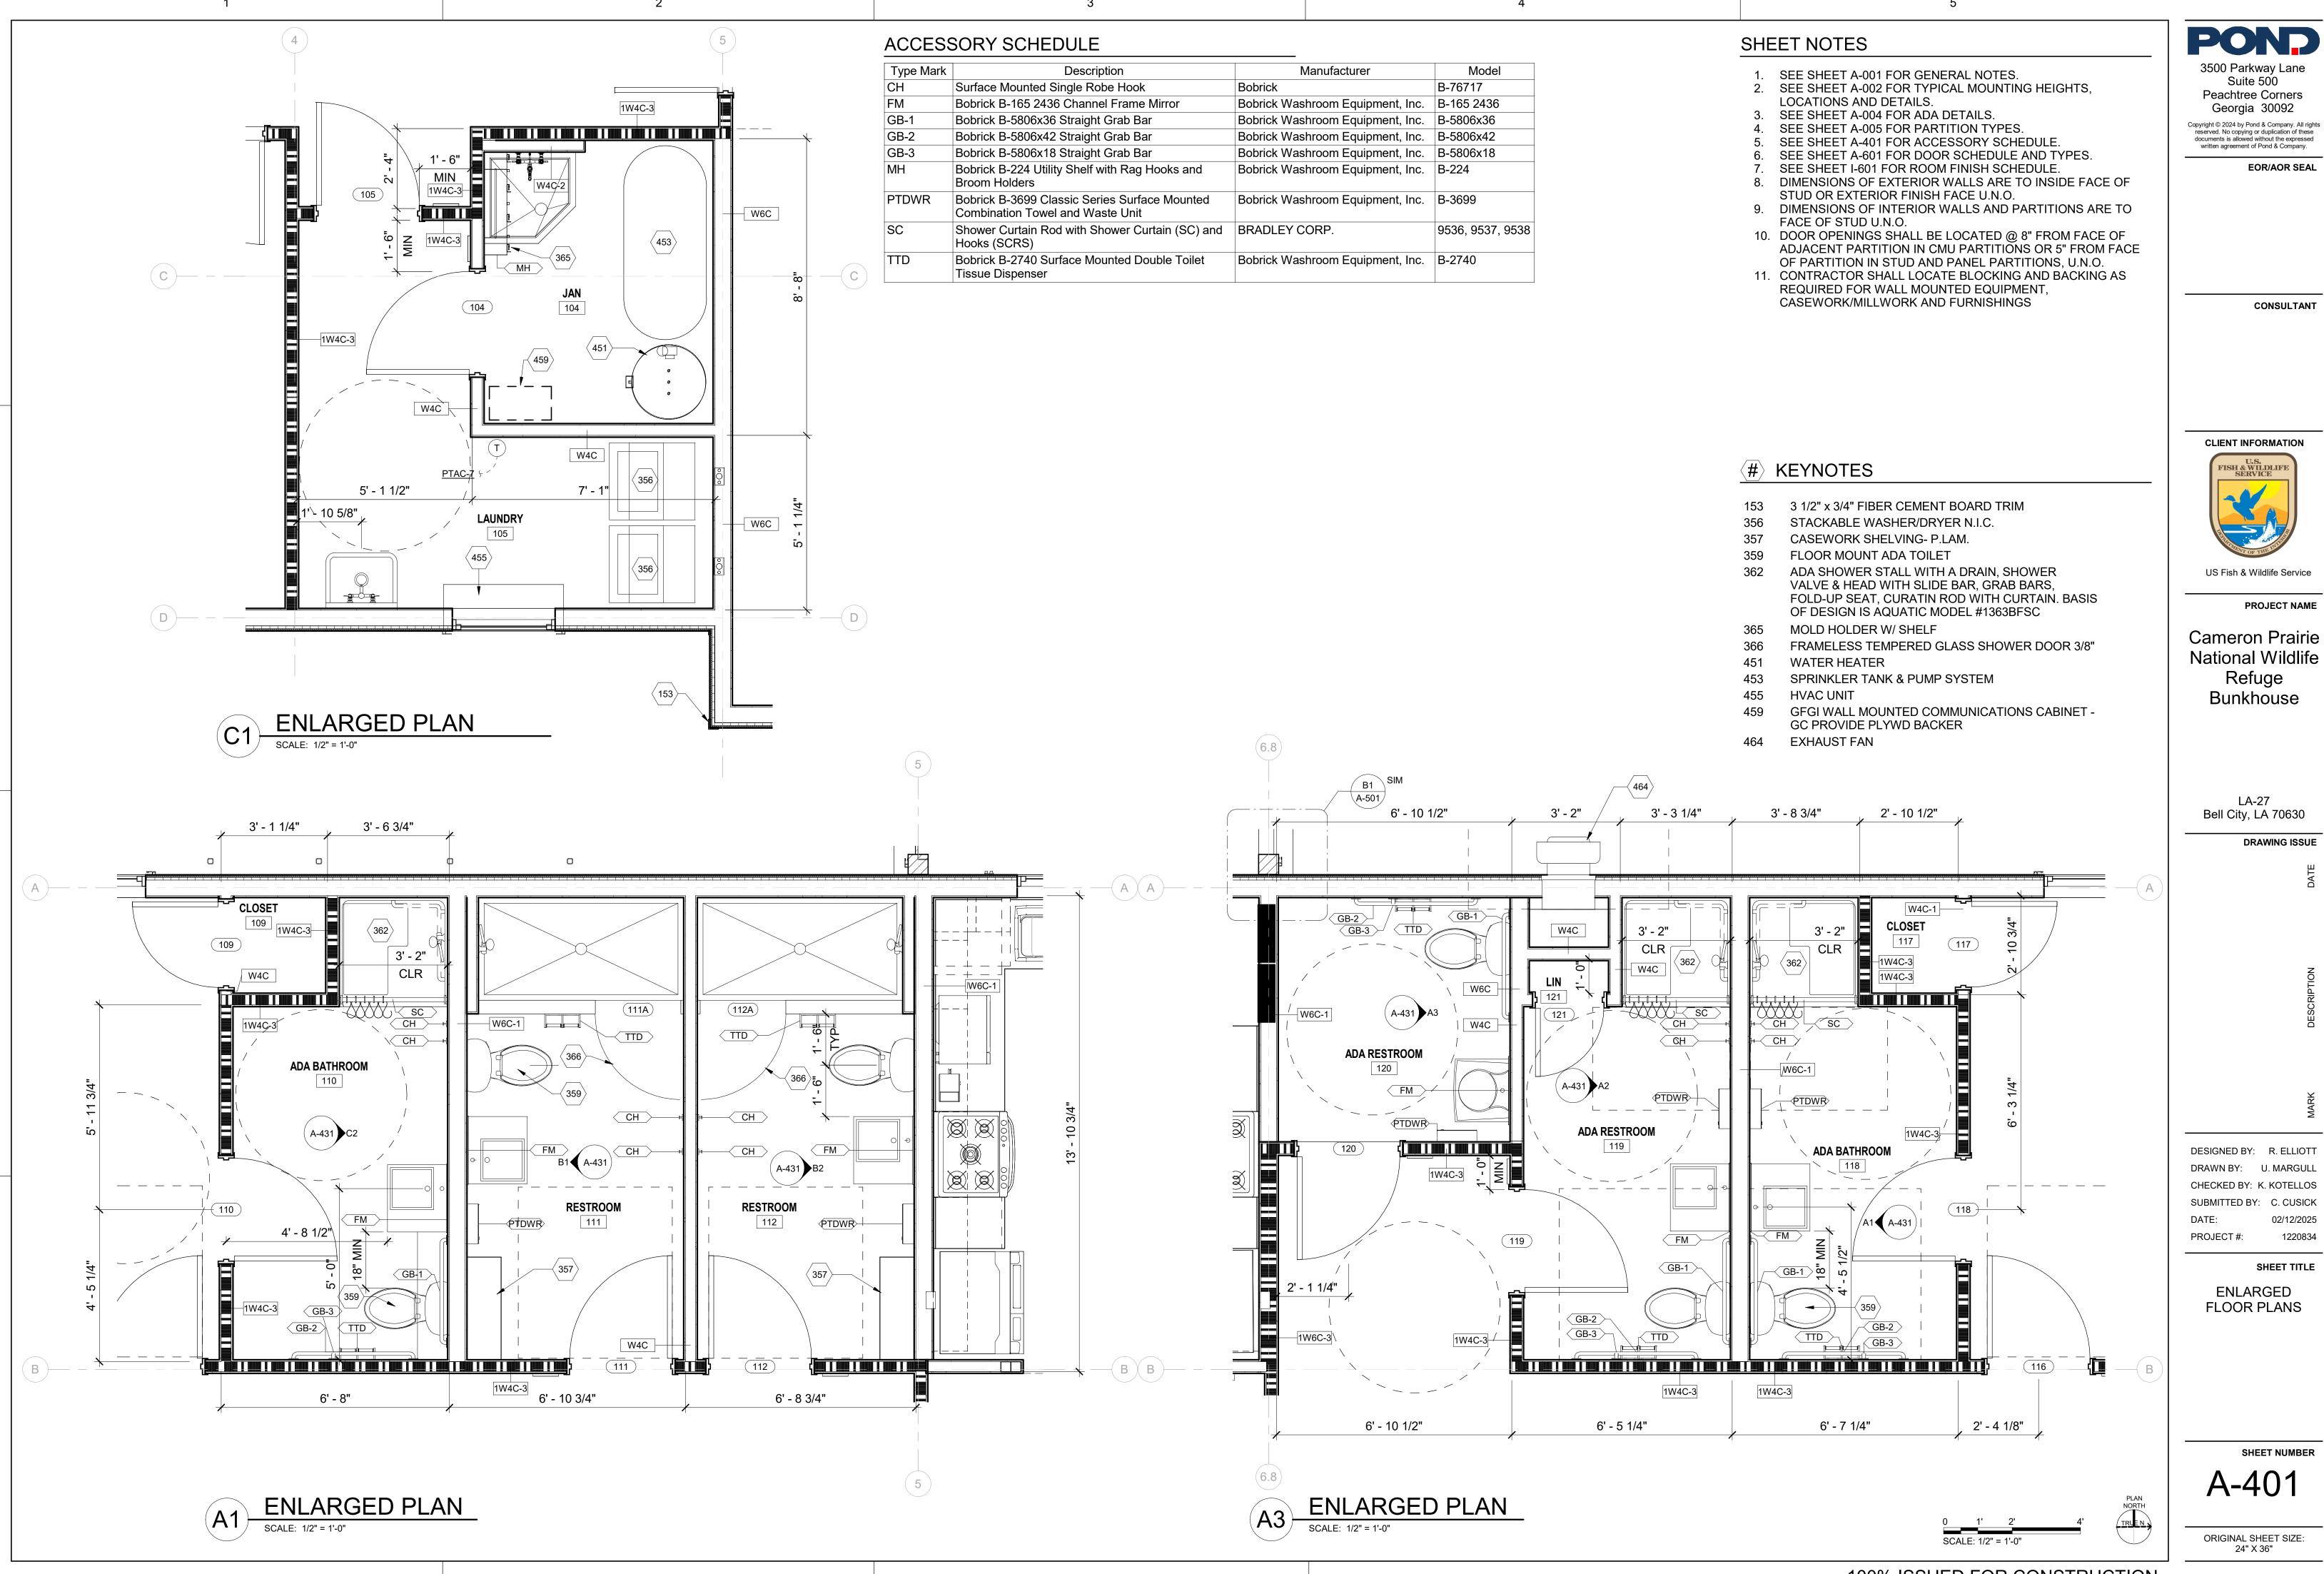

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**PROJECT NAME** 

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LA-27 Bell City, LA 70630

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DESIGNED BY: R. ELLIOT DRAWN BY: U. MARGULL CHECKED BY: K. KOTELLOS 02/12/2025 PROJECT #:

SHEET TITLE

**ENLARGED FLOOR PLANS** 

SHEET NUMBER

A-401

D

SHEET NOTES

SEE SHEET A-001 FOR GENERAL NOTES. 2. SEE SHEET A-002 FOR TYPICAL MOUNTING HEIGHTS,

LOCATIONS AND DETAILS.

3. SEE SHEET A-004 FOR ADA DETAILS.

SEE SHEET A-401 FOR ACCESSORY SCHEDULE.

DIMENSIONS OF EXTERIOR WALLS ARE TO INSIDE FACE OF

FACE OF STUD U.N.O.

10. DOOR OPENINGS SHALL BE LOCATED @ 8" FROM FACE OF ADJACENT PARTITION IN CMU PARTITIONS OR 5" FROM FACE

11. CONTRACTOR SHALL LOCATE BLOCKING AND BACKING AS REQUIRED FOR WALL MOUNTED EQUIPMENT, CASEWORK/MILLWORK AND FURNISHINGS

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MICROWAVE N.I.C.

RESIDENTIAL STOVE & RANGE N.I.C.

WALL-MOUNTED LAVATORY

ADA SHOWER STALL WITH A DRAIN, SHOWER VALVE & HEAD WITH SLIDE BAR, GRAB BARS, FOLD-UP SEAT, CURATIN ROD WITH CURTAIN. BASIS OF DESIGN IS AQUATIC MODEL #1363BFSC

LOW GWB WALL WITH SOLID SURFACE CAP & 3/8"THK TEMP

US Fish & Wildlife Service

**CLIENT INFORMATION** 

**PROJECT NAME** 

Cameron Prairie National Wildlife Refuge Bunkhouse

> LA-27 Bell City, LA 70630

CHECKED BY: K. KOTELLOS

INTERIOR **ELEVATIONS** 

A-431

ORIGINAL SHEET SIZE: 24" X 36"

SEE SHEET A-005 FOR PARTITION TYPES.

SEE SHEET A-601 FOR DOOR SCHEDULE AND TYPES.

SEE SHEET I-601 FOR ROOM FINISH SCHEDULE.

STUD OR EXTERIOR FINISH FACE U.N.O. DIMENSIONS OF INTERIOR WALLS AND PARTITIONS ARE TO

OF PARTITION IN STUD AND PANEL PARTITIONS, U.N.O.

#> KEYNOTES

REFRIGERATOR N.I.C.

FLOOR MOUNT ADA TOILET

**GLASS ABOVE** 

ADA PIPE COVER

**DRAWING ISSUE** 

DESIGNED BY: R. ELLIOTT

SHEET TITLE

SCALE: 1/2" = 1'-0"

SEE SHEET A-001 FOR GENERAL NOTES.
 SEE SHEET A-002 FOR TYPICAL MOUNTING HEIGHTS,

LOCATIONS AND DETAILS.

SEE SHEET A-004 FOR ADA DETAILS.
 SEE SHEET A-005 FOR PARTITION TYPES.

5. SEE SHEET A-401 FOR ACCESSORY SCHEDULE.

6. SEE SHEET A-601 FOR DOOR SCHEDULE AND TYPES.7. SEE SHEET I-601 FOR ROOM FINISH SCHEDULE.

8. DIMENSIONS OF EXTERIOR WALLS ARE TO INSIDE FACE OF STUD OR EXTERIOR FINISH FACE U.N.O.

9. DIMENSIONS OF INTERIOR WALLS AND PARTITIONS ARE TO FACE OF STUD U.N.O.

10. DOOR OPENINGS SHALL BE LOCATED @ 8" FROM FACE OF ADJACENT PARTITION IN CMU PARTITIONS OR 5" FROM FACE OF PARTITION IN STUD AND PANEL PARTITIONS, U.N.O.

11. CONTRACTOR SHALL LOCATE BLOCKING AND BACKING AS REQUIRED FOR WALL MOUNTED EQUIPMENT, CASEWORK/MILLWORK AND FURNISHINGS

**EOR/AOR SEAL** 

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## #> KEYNOTES

351 MICROWAVE N.I.C.

352 DISHWASHER N.I.C.353 REFRIGERATOR N.I.C.

354 RESIDENTIAL STOVE & RANGE N.I.C.

358 DOUBLE COMPARTMENT SINK

# CLIENT INFORMATION U.S. FISH & WILDLIFE SERVICE

US Fish & Wildlife Service

PROJECT NAME

Cameron Prairie National Wildlife Refuge Bunkhouse

LA-27 Bell City, LA 70630

DRAWING ISSUE

.

DESCF

DESIGNED BY: R. ELLIOTT
DRAWN BY: U. MARGULL
CHECKED BY: K. KOTELLOS
SUBMITTED BY: C. CUSICK
DATE: 02/12/2025


SHEET TITLE

INTERIOR ELEVATIONS

SHEET NUI

A-432

ORIGINAL SHEET SIZE: 24" X 36"

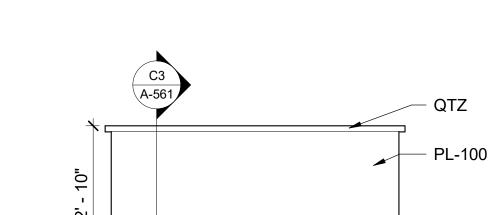

6' - 0"

PL-100

353

3' - 0"

SCHLUTER EDGE TRIM - 3' - 0"

KITCHEN ISLAND NORTH ELEVATION


SCALE: 1/2" = 1'-0"

2' - 6"


A1 MAIN KITCHEN NORTH ELEVATION

SCALE: 1/2" = 1'-0"

## B2 KITCHEN ISLAND SOUTH ELEVATION SCALE: 1/2" = 1'-0"

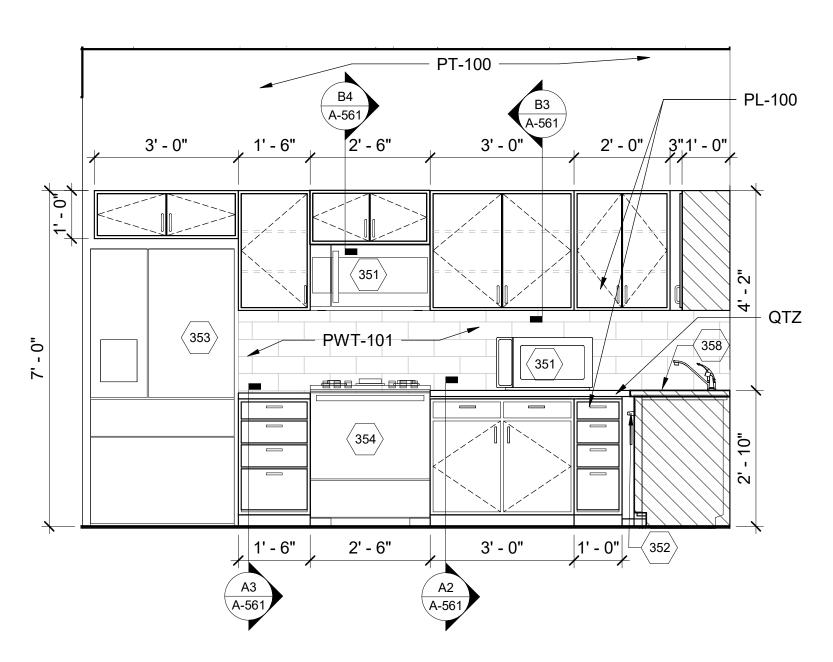



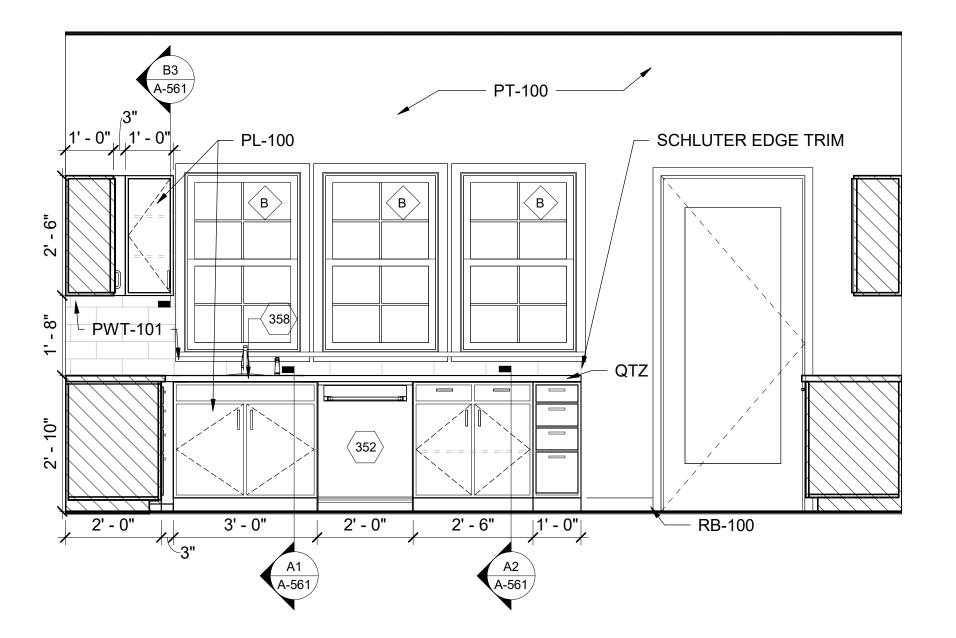


A4 MAIN KITCHEN WEST ELEVATION

SCALE: 1/2" = 1'-0"

11:53:08 AM BIM 360://1220834 Cameron Prairie NWR/1220834\_Camerc

100% ISSUED FOR CONSTRUCTION

SCALE: 1/2" = 1'-0"

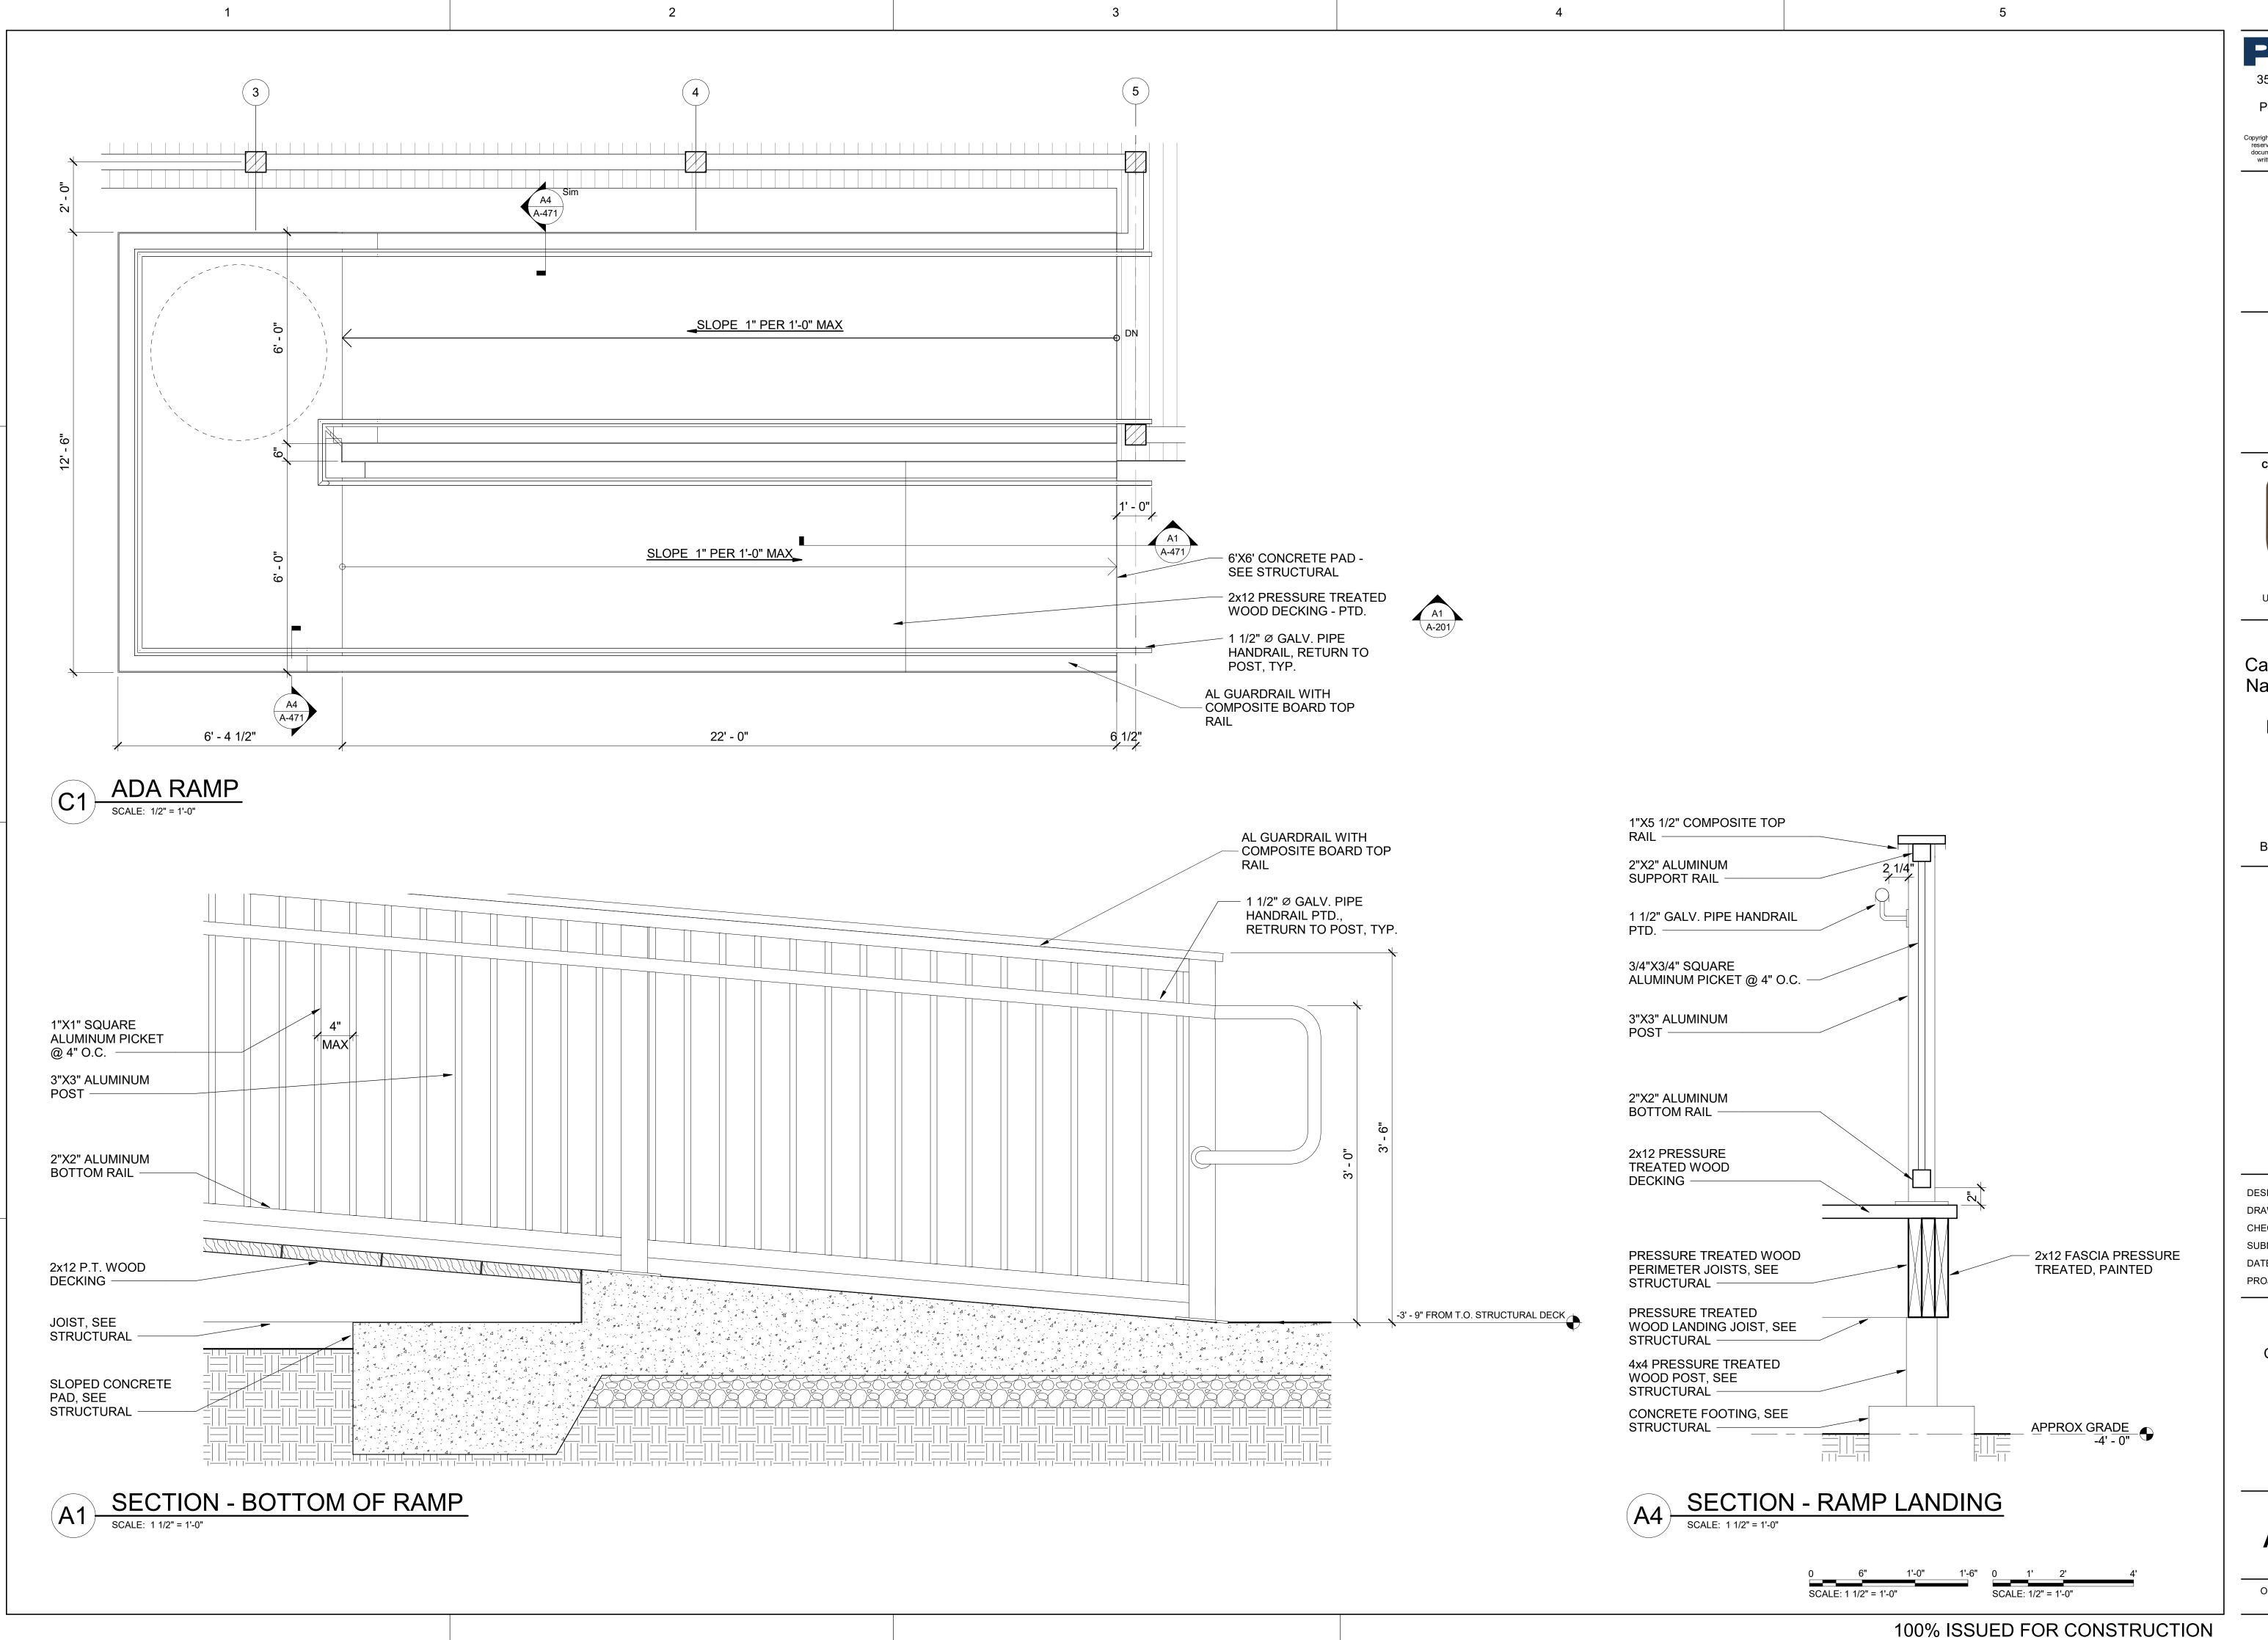

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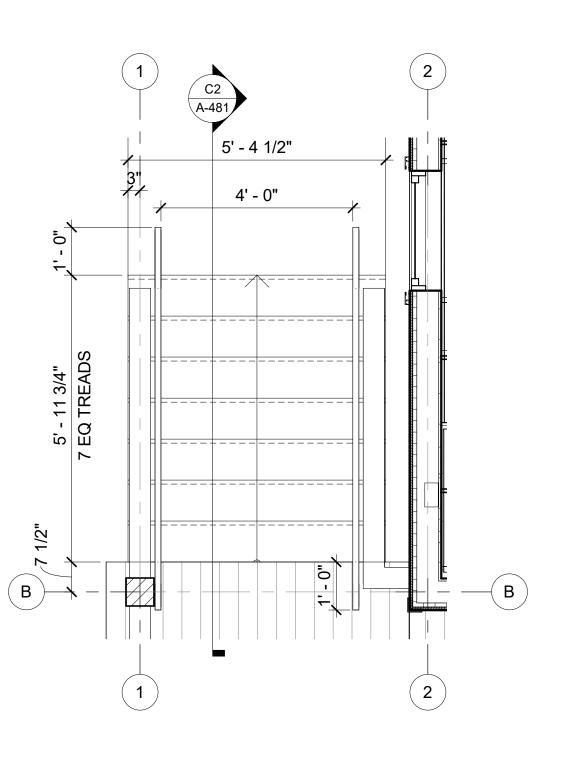
PROJECT#: 1220834

SHEET TITLE

02/12/2025

VERTICAL CIRCULATION PLANS

A-471




AL GUARDRAIL WITH
COMPOSITE BOARD TOP
RAIL

3/4" AL TUBE
PICKET

1 1/2" Ø AL PIPE
HANDRAIL, RETURN
TO POST

6" Ø MAX

4' 4 3/16" FROM T.O. STRUCTURAL DECK

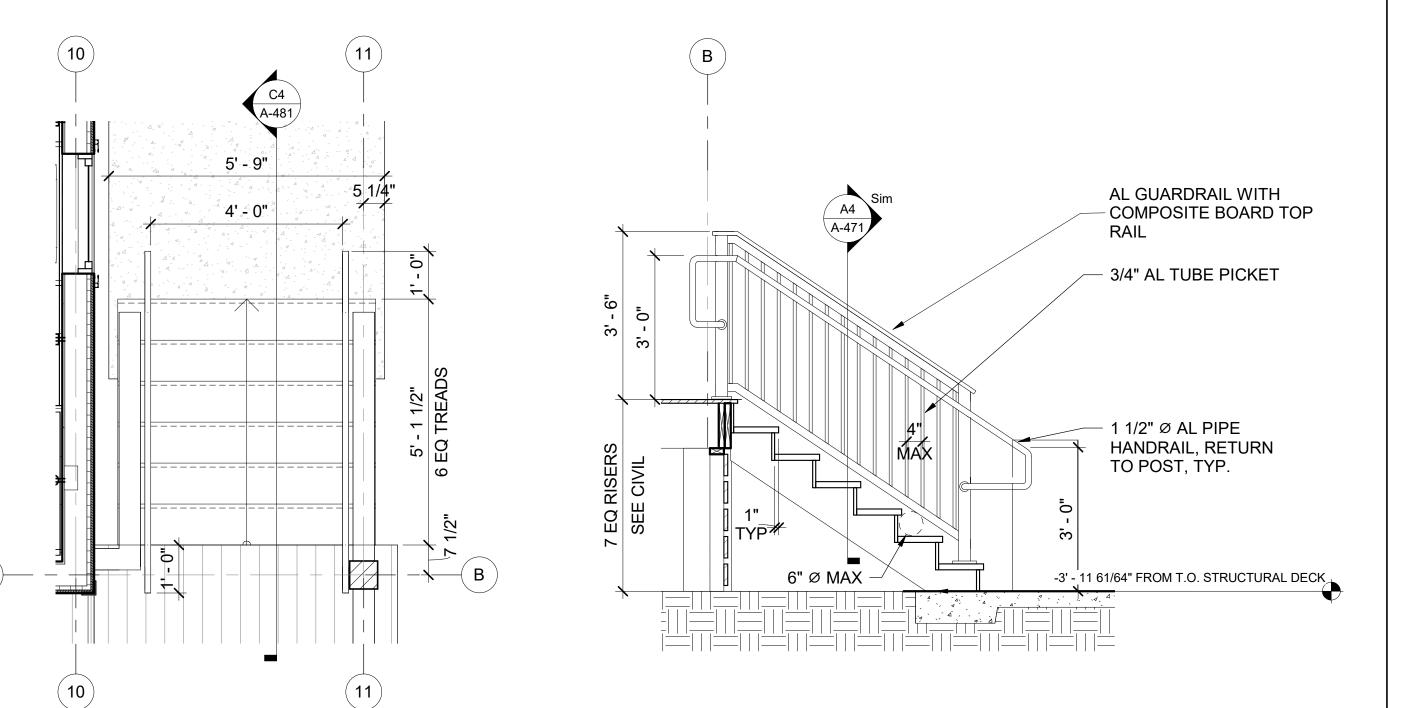

C1 PLAN DETAIL - SIDE STAIR SOUTH

SCALE: 1/2" = 1'-0"

C2 SECTION - SIDE STAIR SOUTH


SCALE: 1/2" = 1'-0"

C3 PLAN DETAIL - SIDE STAIR NORTH

SCALE: 1/2" = 1'-0"

C4 SECTON - SIDE STAIR NORTH

SCALE: 1/2" = 1'-0"

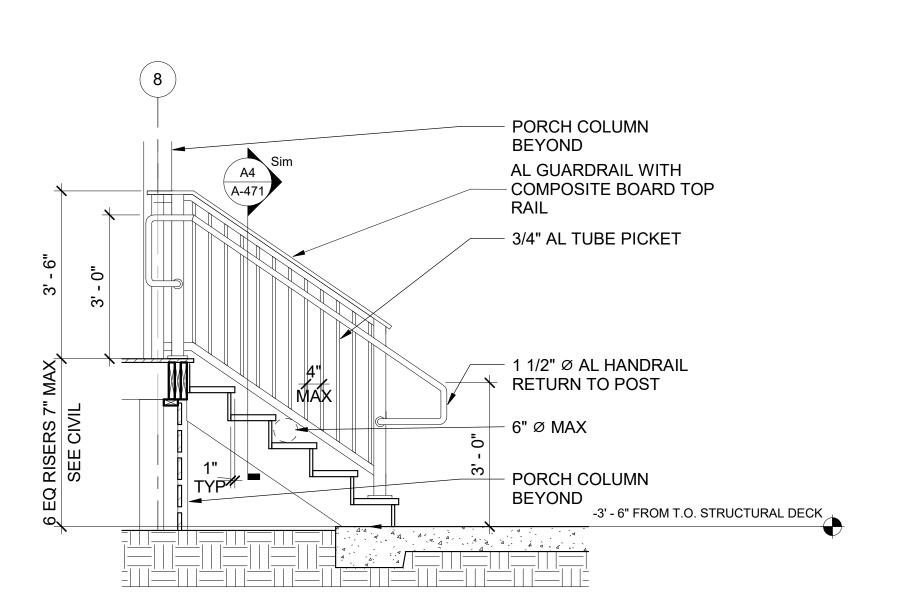

PLAN DETAIL - ENTRY STAIR

SCALE: 1/2" = 1'-0"

A2 SECTION - ENTRY STAIR

SCALE: 1/2" = 1'-0"

0 1' 2' 4' SCALE: 1/2" = 1'-0" 3500 Parkway Lane
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Georgia, 30092

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US Fish & Wildlife Service

PROJECT NAME

Cameron Prairie National Wildlife Refuge Bunkhouse

LA-27 Bell City, LA 70630

DRAWING ISSUE

Q

DESCRIPT


DESIGNED BY: R. ELLIOTT
DRAWN BY: U. MARGULL
CHECKED BY: K. KOTELLOS
SUBMITTED BY: C. CUSICK
DATE: 02/12/2025

SHEET TITLE

STAIR PLANS & SECTIONS

PROJECT #: 1220834

A-481

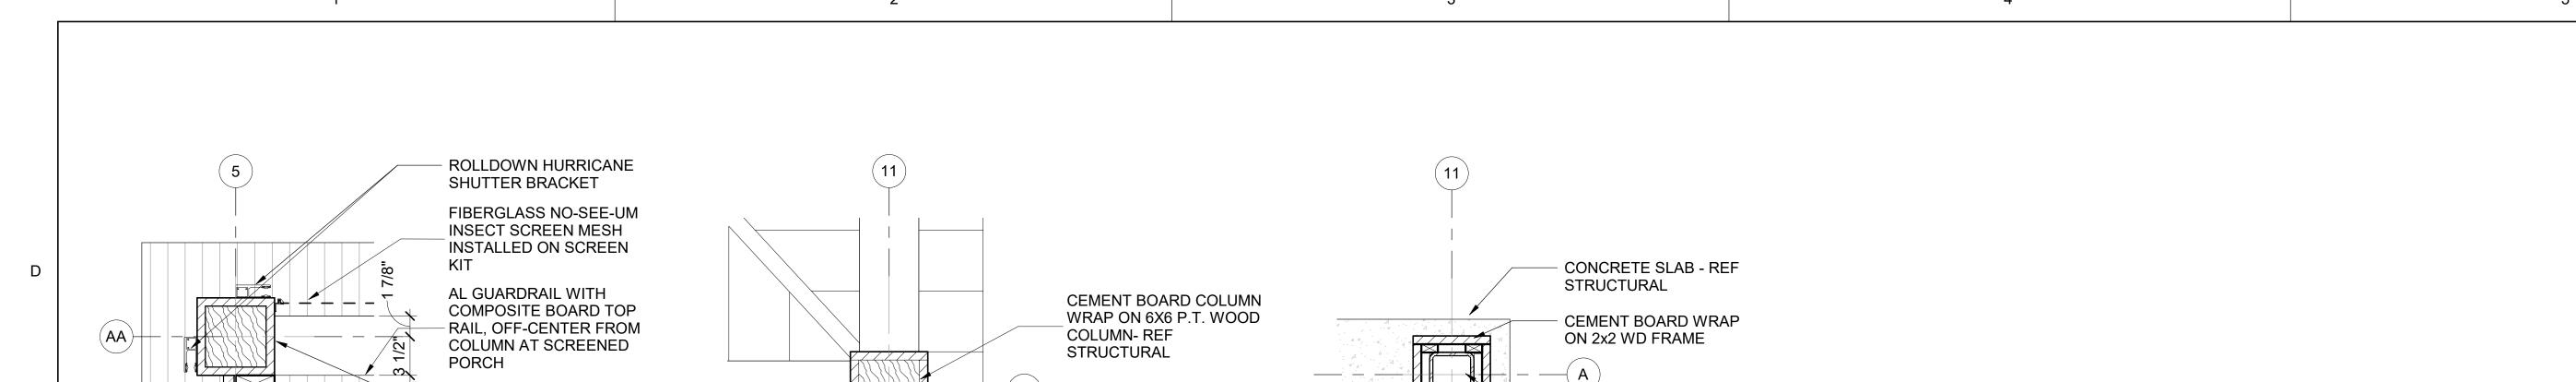

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US Fish & Wildlife Service

PROJECT NAME

Cameron Prairie National Wildlife Refuge

Bunkhouse

LA-27 Bell City, LA 70630

**DRAWING ISSUE** 

DESIGNED BY: R. ELLIOTT DRAWN BY: U. MARGULL CHECKED BY: K. KOTELLOS SUBMITTED BY: C. CUSICK 02/12/2025 PROJECT #: 1220834

SHEET TITLE

PLAN & SECTION **DETAILS** 

SHEET NUMBER A-501

ORIGINAL SHEET SIZE: 24" X 36"

4x4 HSS COLUMN - REF STRUCTURAL COMPOSITE BOARD DECKING (11)

PLAN DETAIL - CORNER WOOD COLUMN

PLAN DETAIL - CORNER STEEL COLUMN

5 5/8" 1"X5 1/2" **COMPOSITE BOARD SLAT WALL** WITH 1 1/2" GAP 2X4 WOOD **BLOCKING** 4"X4" SLOTTED ANGLE TIMBER PILE, SEE **STRUCTURAL CENTERLINE OF PILE** 

PLAN DETAIL - SCREEN WALL

@ INSIDE CORNER TYP.

PLAN DETAIL - SCREEN PORCH

6" X 6" CEMENT BOARD

COMPOSITE BOARD DECK

COMPOSITE BOARD SLAT

FIBERGLASS NO-SEE-UM

**TONGUE & GROOVE** 


WRAPPED POST

SCREEN WITH

INSECT SCREEN

BELOW

TIMBER PILE, SEE STRUCTURAL 4"X4" SLOTTED ANGLE 2X6 WOOD BLOCKING 2X4 WOOD **BLOCKING** \_1"X5 1/2" COMPOSITE **BOARD SLAT WALL FIBER CEMENT** 10 **BOARD TRIM** COVER @ WOOD

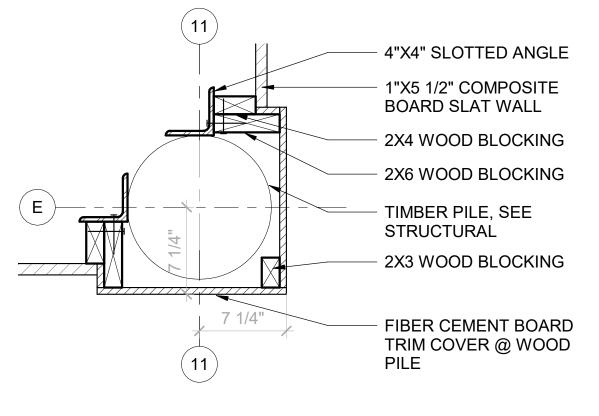

PLAN DETAIL - SCREEN WALL

5/8" GWB (UL TYPE

ULIX) EACH SIDE

MINERAL WOOL

**INSULATION BATTS** 

5/8" GYP. WALL BOARD

INCHES O.C.

INTERIOR

SCHEDULE -

2x6 WOOD FRAMING @ 16

RUBBER WALL BASE, SEE


FINISHED FLOOR PER


**CLOSED CELL SPRAY** 

PLAN DETAIL - SCREEN WALL TYP.

B3 @ CORNER TYP.

SCALE: 1 1/2" = 1'-0"

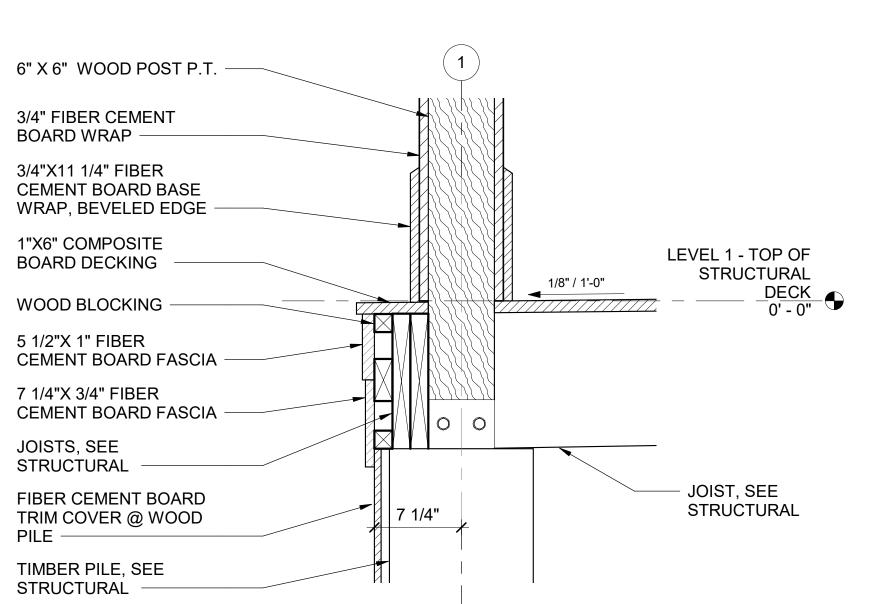

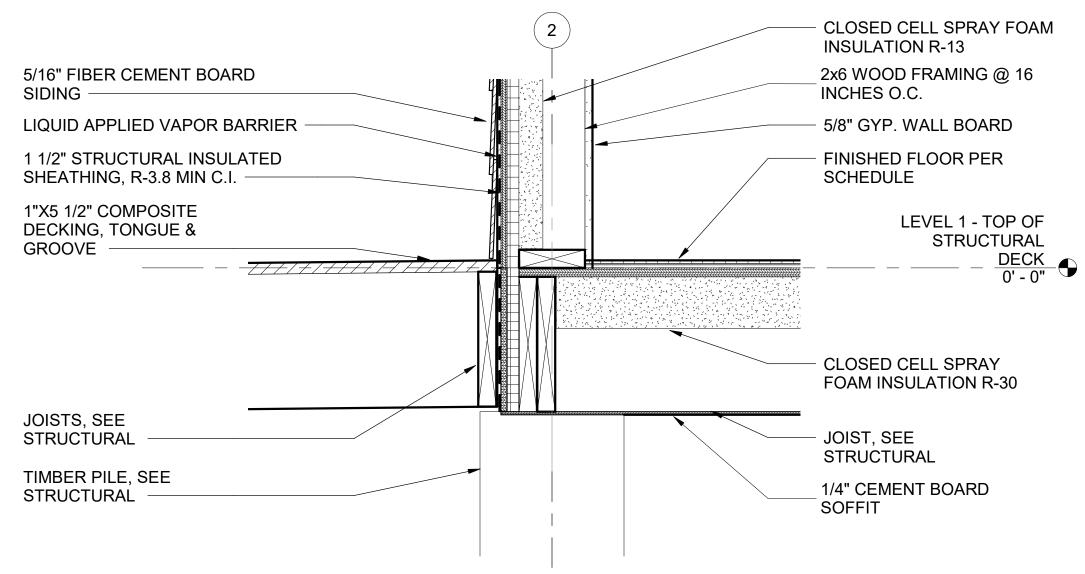

SECTION DETAIL - DECK AT EXT. WALL

SCALE: 1 1/2" = 1'-0"

1/2" 25GA RESILIENT CHANNEL

SPACED 16" MAX O.C.

5/8" GWB (UL TYPE ULIX)

2x WD STUD TOP PLATE

PARTITION HEAD CONNECTION FOR RATING UL P522

100% ISSUED FOR CONSTRUCTION

FIBER CEMENT BOARD

LIQUID APPLIED VAPOR

INSULATED SHEATHING,

CLOSED CELL SPRAY

FOAM INSULATION R-13

3 1/2" X 5/4" CEMENT BD TRIM

LEVEL 1 - TOP OF

STRUCTURAL

DECK 0' - 0"

1 1/2" STRUCTURAL


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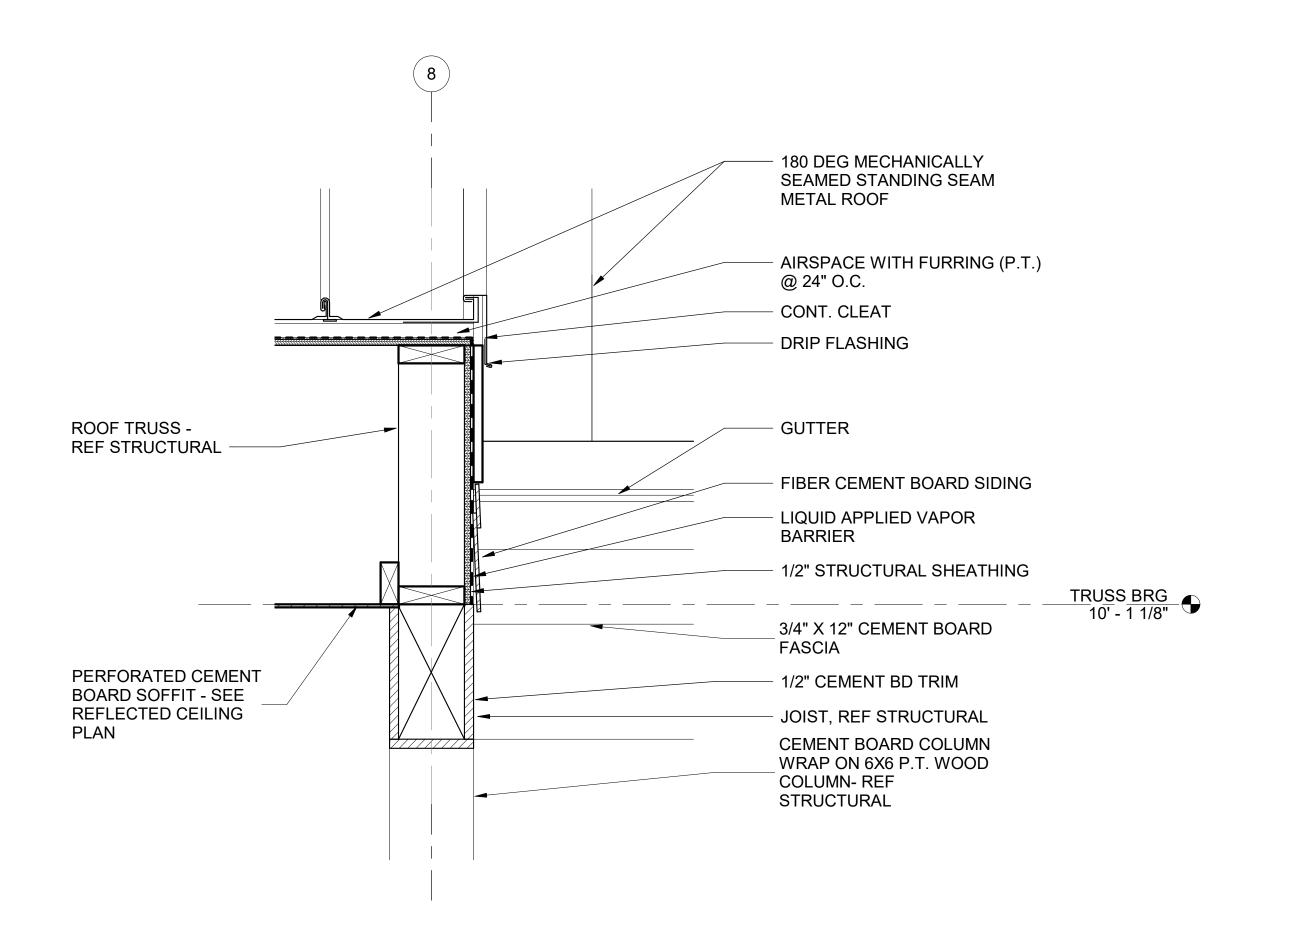
**BARRIER** 

R-3.8 MIN C.I.

SECTION DETAIL - PORCH POST AND DECK

A1) SCALE: 1 1/2" = 1'-0"



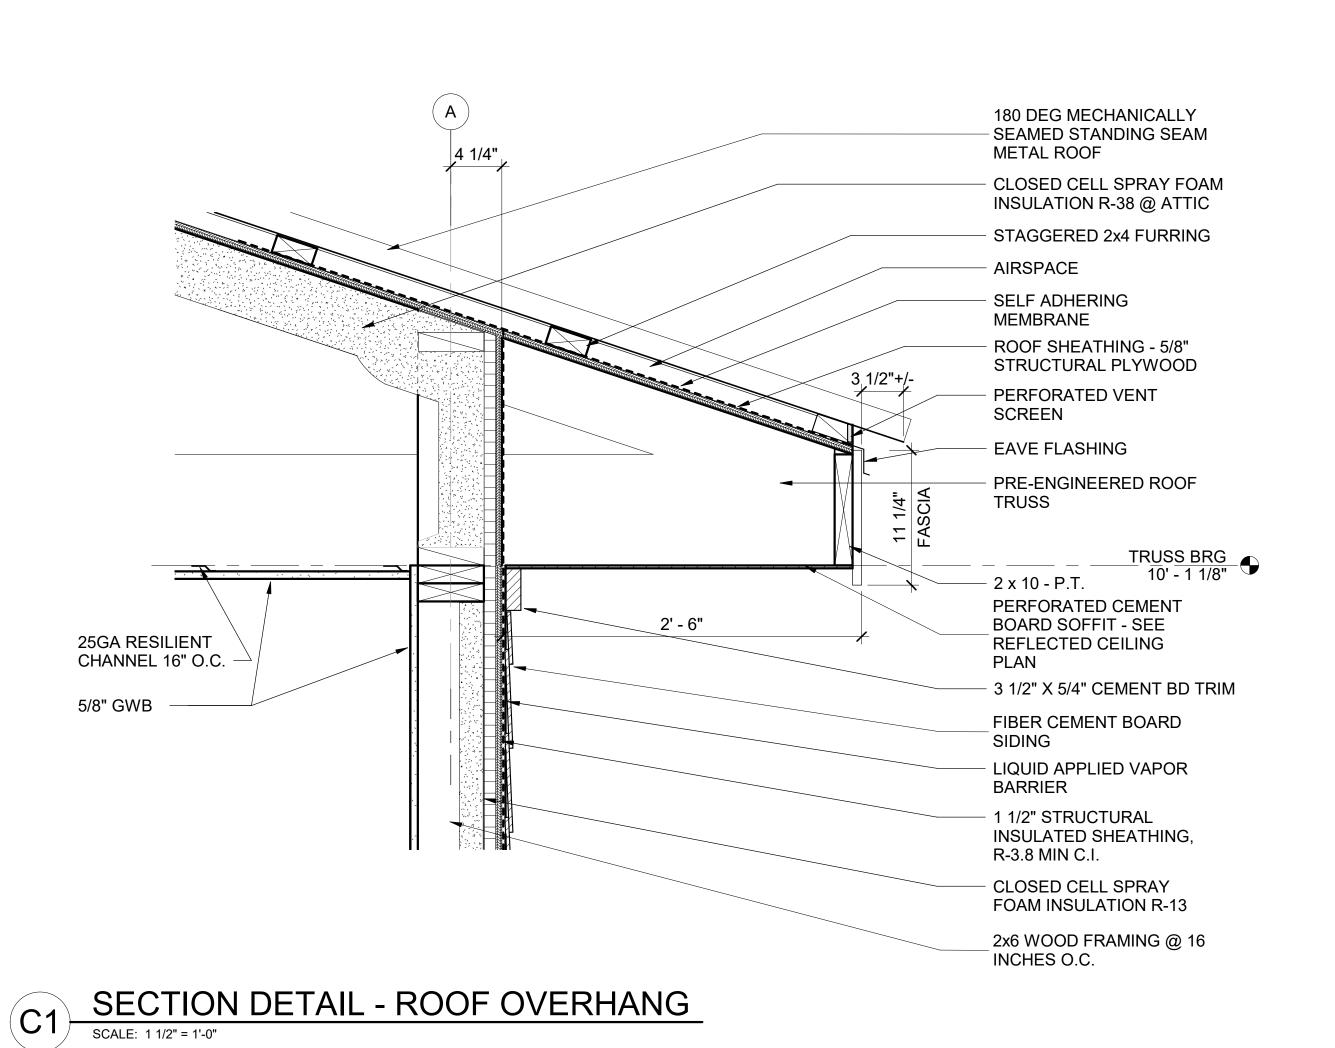

A1 SECTION DETAIL - EDGE OF CANOPY ROOF

SCALE: 1 1/2" = 1'-0"

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CONSULTANT

U.S. FISH & WILDLIFE SERVICE

US Fish & Wildlife Service

PROJECT NAME

Cameron Prairie National Wildlife Refuge Bunkhouse

LA-27 Bell City, LA 70630

DRAWING ISSUE

DRAWING ISSUE

SCRIPTION

DESIGNED BY: R. ELLIOTT
DRAWN BY: U. MARGULL

CHECKED BY: K. KOTELLOS
SUBMITTED BY: C. CUSICK
DATE: 02/12/2025
PROJECT #: 1220834

ROOF SECTION


SHEET TITLE


DETAILS


A-511


ORIGINAL SHEET SIZE: 24" X 36"

100% ISSUED FOR CONSTRUCTION

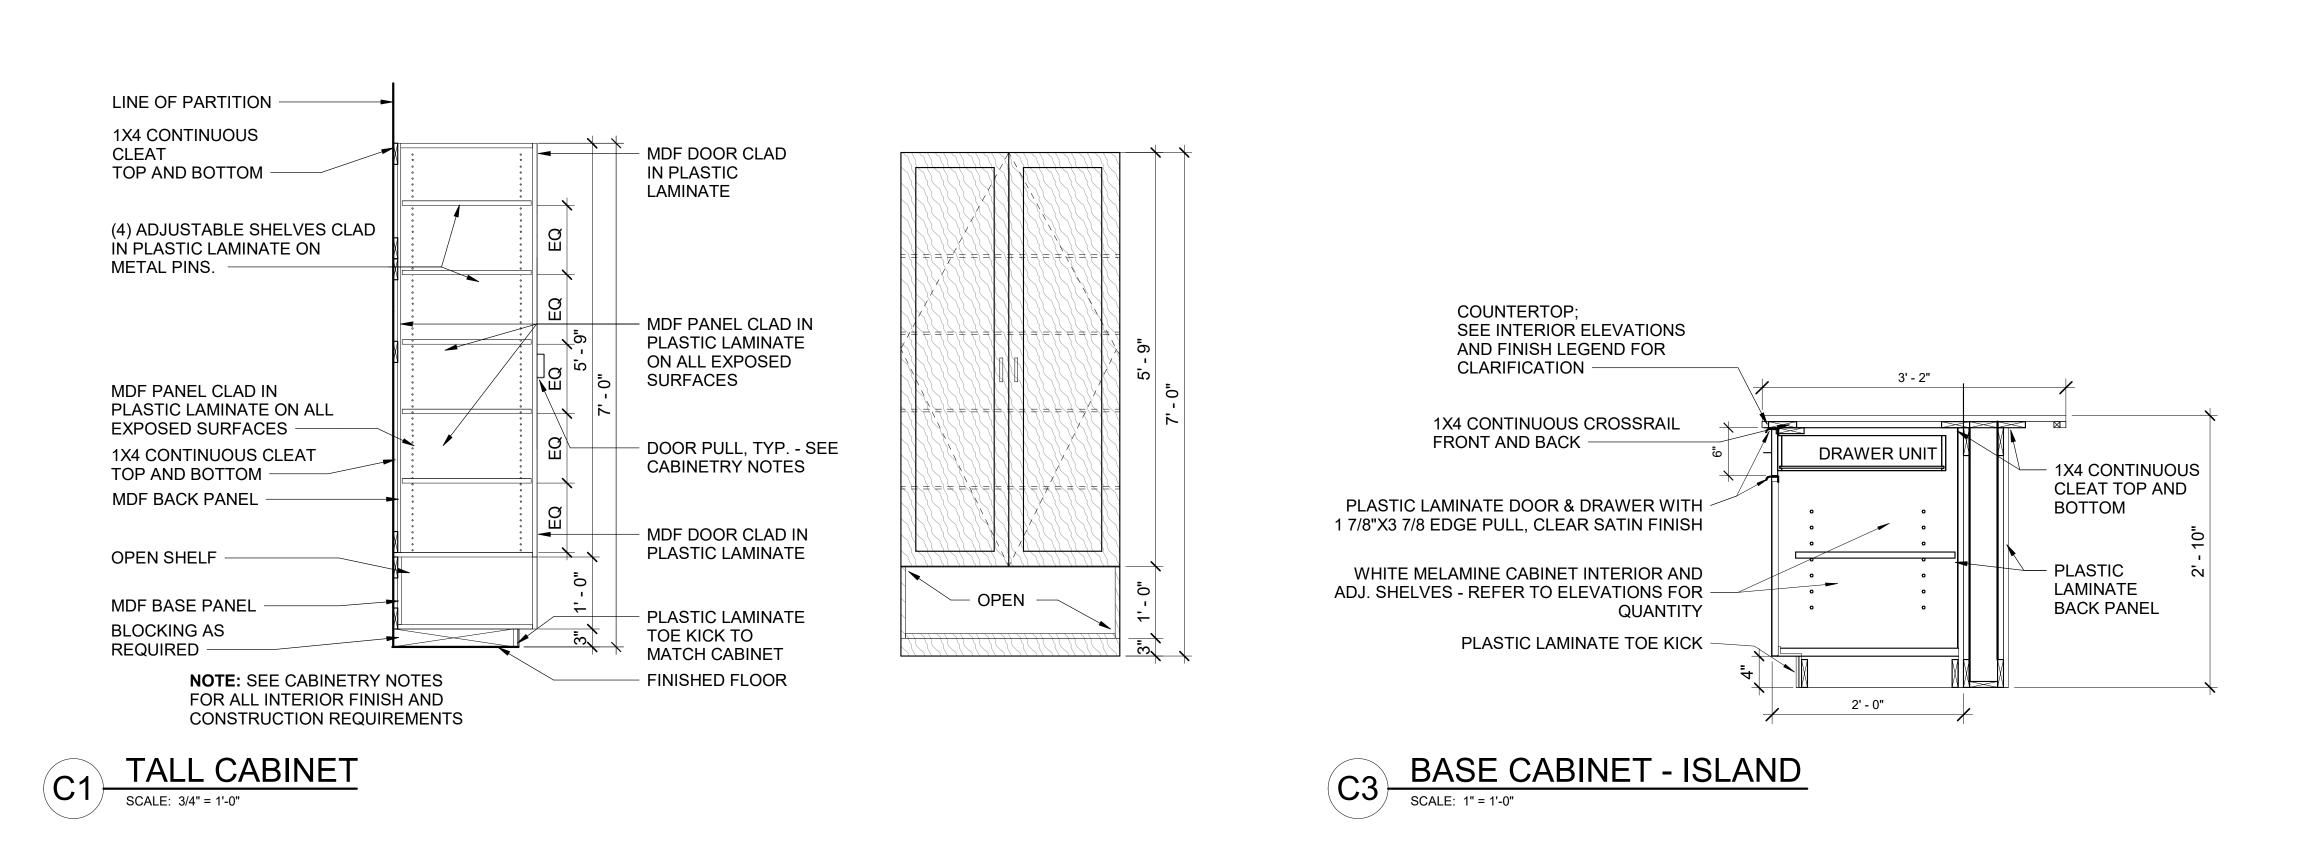

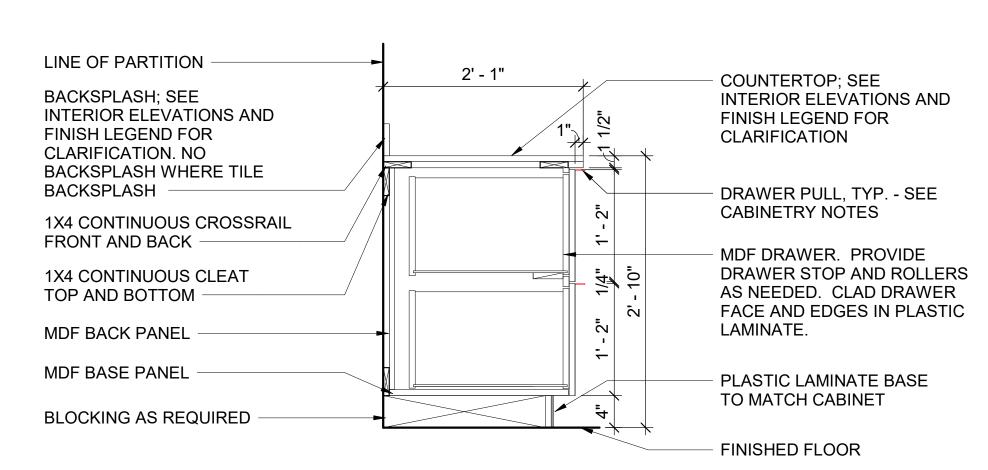


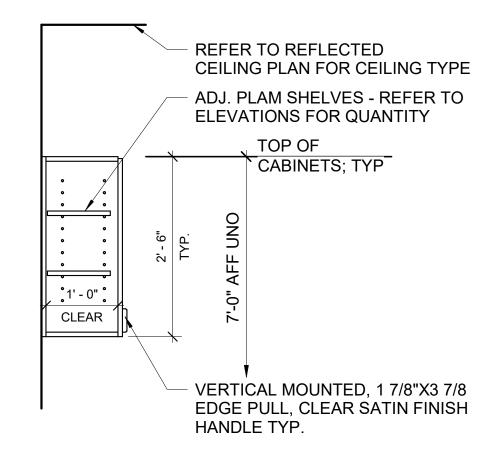


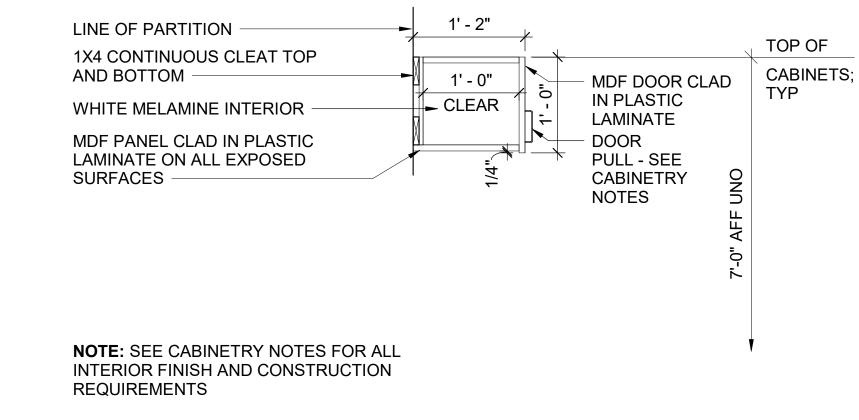







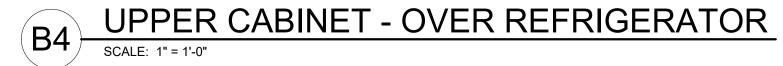

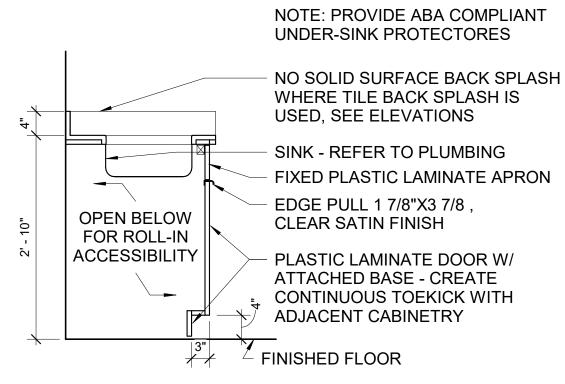

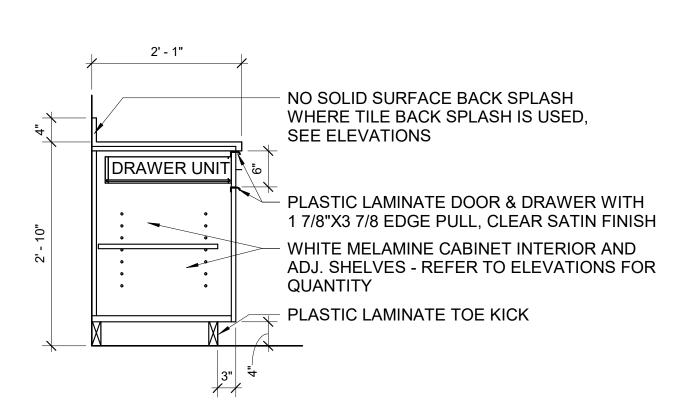

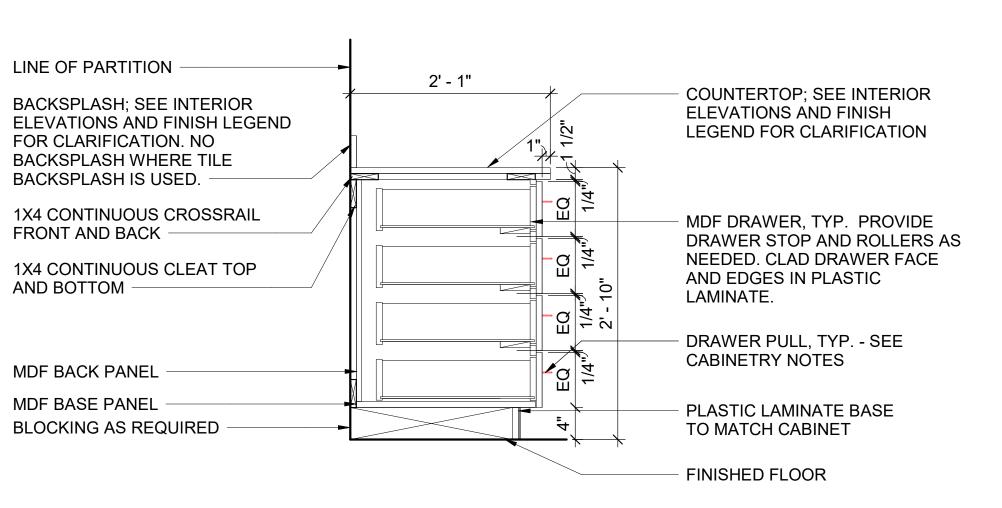









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EOR/AOR SEAL

CONSULTANT

CLIENT INFORMATION

U.S.
FISH & WILDLIFE
SERVICE

US Fish & Wildlife Service

PROJECT NAME

Cameron Prairie
National Wildlife
Refuge
Bunkhouse

LA-27 Bell City, LA 70630

DRAWING ISSUE

DATE

DESCRIPTION

DESIGNED BY: R. ELLIOTT
DRAWN BY: U. MARGULL
CHECKED BY: K. KOTELLOS

CHECKED BY: K. KOTELLOS
SUBMITTED BY: C. CUSICK
DATE: 02/12/2025
PROJECT #: 1220834

SHEET TITLE

MILLWORK SECTIONS

A-561


DOOR SCHEDULE														
			PANE	ΞL			FRAME			DETAILS	FIRE			
MARK	TYPE	WIDTH	HEIGHT	THK.	MATL.	FIN.	TYPE	MATL.	FIN.	SILL/JAMB/HEAD	RATIN G	HARDWARE	REMARKS	Type Mark
		***************************************			1707 (12.	1 11 41		1717 (112.	1 11 41			11741277741	1 (EIV) II II II	1 ypo man
101	D01	3' - 0"	7' - 0"	1 3/4"	SCW	ST	F01	H.M.	PT	A1/A-601	45 MIN.	2.0		328
102	D05	3' - 0"	7' - 0"	1 3/4"	H.M.	PT	F01	H.M.	PT	A1/A-611	-	1.0		64
103	D01	3' - 0"	7' - 0"	1 3/4"	SCW	ST	F01	H.M.	PT	A1/A-601	45 MIN.	2.0		328
104	D01	3' - 0"	7' - 0"	1 3/4"	SCW	ST	F01	H.M.	PT	A1/A-601	-	3.0		221
105	D01	3' - 0"	7' - 0"	1 3/4"	SCW	ST	F01	H.M.	PT	A1	45 MIN.	2.0		328
106	D01	3' - 0"	7' - 0"	1 3/4"	SCW	ST	F01	H.M.	PT	A1	45 MIN.	4.0		328
107	D01	3' - 0"	7' - 0"	1 3/4"	SCW	ST	F01	H.M.	PT	A1	45 MIN.	4.0		328
108	D01	3' - 0"	7' - 0"	1 3/4"	SCW	ST	F01	H.M.	PT	A1	45 MIN.	4.0		328
109	D01	2' - 6"	7' - 0"	1 3/4"	SCW	ST	F01	H.M.	PT	A1	-	5.0		327
110	D01	3' - 0"	7' - 0"	1 3/4"	SCW	ST	F01	H.M.	PT	A1	45 MIN.	6.0		328
111	D01	3' - 0"	7' - 0"	1 3/4"	SCW	ST	F01	H.M.	PT	A1	45 MIN.	6.0		328
111A	D06	2' - 6"	8' - 0"	3/8"	GL3								FRAMELESS GLASS SHOWER DOOR & S.S. GLASS DOOR HARDWARE KIT: PULL HINGES W/ LIMIT PLATES & HANDLES BY FHC, GLASS SIMPLE OR EQUAL	329
112	D01	3' - 0"	7' - 0"	1 3/4"	SCW	ST	F01	H.M.	PT	A1	45 MIN.	6.0		328
112A	D06	2' - 6"	8' - 0"	3/8"	GL3								FRAMELESS GLASS SHOWER DOOR & S.S. GLASS DOOR HARDWARE KIT: PULL HINGES W/ LIMIT PLATES & HANDLES BY FHC, GLASS SIMPLE OR EQUAL	329
114	D01	3' - 0"	7' - 0"	1 3/4"	SCW	ST	F01	H.M.	PT	A1	45 MIN.	4.0		328
115	D01	3' - 0"	7' - 0"	1 3/4"	SCW	ST	F01	H.M.	PT	A1	45 MIN.	4.0		328
116	D01	3' - 0"	7' - 0"	1 3/4"	SCW	ST	F01	H.M.	PT	A1	45 MIN.	4.0		328
117	D01	2' - 6"	7' - 0"	1 3/4"	SCW	ST	F01	H.M.	PT	A1	-	5.0		327
118	D01	3' - 0"	7' - 0"	1 3/4"	SCW	ST	F01	H.M.	PT	A1	45 MIN.	6.0		328
119	D01	3' - 0"	7' - 0"	1 3/4"	SCW	ST	F01	H.M.	PT	A1	45 MIN.	6.0		328
120	D01	3' - 0"	7' - 0"	1 3/4"	SCW	ST	F01	H.M.	PT	A1	45 MIN.	6.0		328
121	D01	2' - 0"	7' - 0"	1 3/4"	SCW	ST	F01	H.M.	PT	A1	-	5.0		331
E001	D05	3' - 0"	7' - 0"	1 3/4"	H.M.	PT	F01	H.M.	PT	A1/A-611	-	1.0		64
E002	D05	3' - 0"	7' - 0"	1 3/4"	H.M.	PT	F01	H.M.	PT	A1/A-611	-	1.0		64


A1/A-611

1.0


	GLAZ	ZING SCHEDULE	ASSEMBLY MAX U VALUE
	GL-1	1" INSULATED GLAZING (LOW-E)	
	GL-2	1/4" CLEAR TEMPERED	
	GL-3	3/8" CLEAR TEMPERED WITH POLISHED EDGES	
•	•		

1" INSULATED GLAZING B.O.D.: SOLARBAN 60 SOLAR CONTROL LOW-E GLASS

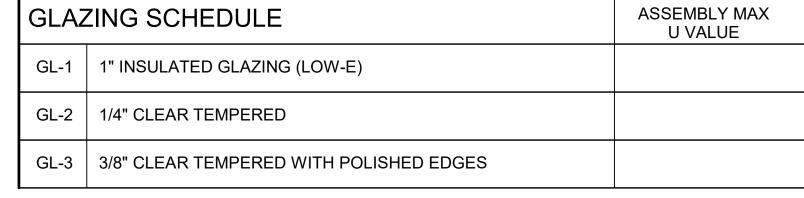

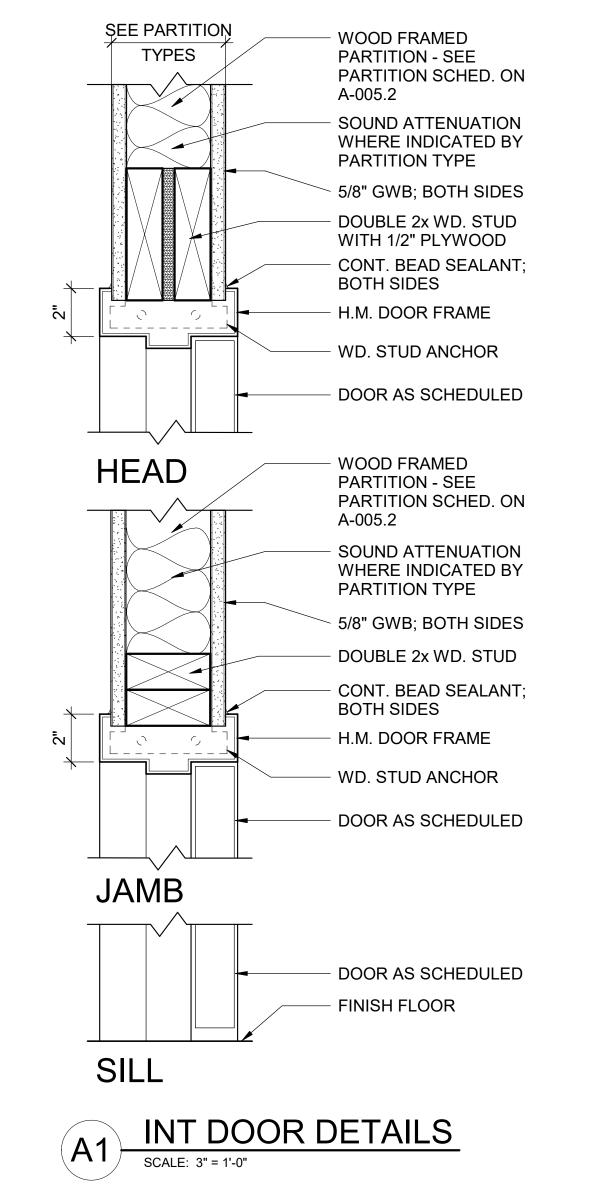

D05 3' - 0" 7' - 0" 1 3/4" H.M. PT F01 H.M. PT

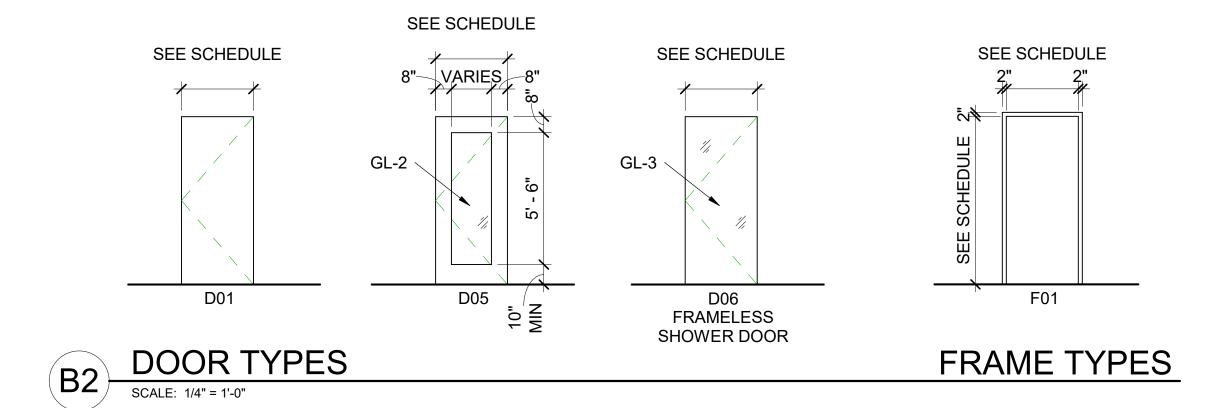

3' - 0" "0 - 12	3' - 0" GL-1 FIN FLR. A-1 (EGRESS WINDOW)	2' - 6" GL-1
--------------------	---	-----------------





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**EOR/AOR SEAL** 

CONSULTANT

**CLIENT INFORMATION** 

US Fish & Wildlife Service

**PROJECT NAME** 

**Cameron Prairie** National Wildlife Refuge Bunkhouse

Bell City, LA 70630

DRAWING ISSUE

DESIGNED BY: R. ELLIOTT DRAWN BY: U. MARGULL CHECKED BY: K. KOTELLOS SUBMITTED BY: C. CUSICK 02/12/2025 PROJECT #: 1220834


SHEET TITLE


DOOR & WINDOW SCHEDULES, **ELEVATIONS & DETAILS** 

SHEET NUMBER


A-601


5/16" FIBER CEMENT **BOARD SIDING** -LIQUID APPLIED VAPOR BARRIER STRUCTURAL INSULATED SHEATHING 1 1/2", R-3.8 MIN C.I. CLOSED CELL SPRAY 1 5/8"X 3/4" FIBER CEMENT FOAM INSULATION R-13 BOARD TRIM -5/8" EXTERIOR PLYWOOD 5/8" GYP. WALL BOARD BACKING -7 1/4"X1" FIBER CEMENT **BOARD TRIM** 2X6 STUDS HURRICANE SHUTTER BOX 7"X7" HURRICAN SHUTTER BRACKET CONT. BACKER ROD AND SEALANT, 1/4" INSTALL THRU WALL BREAK MTL. MIN; BOTH SIDES TRIM, PAINT COLOR TBD H.M. DOOR FRAME HEAD

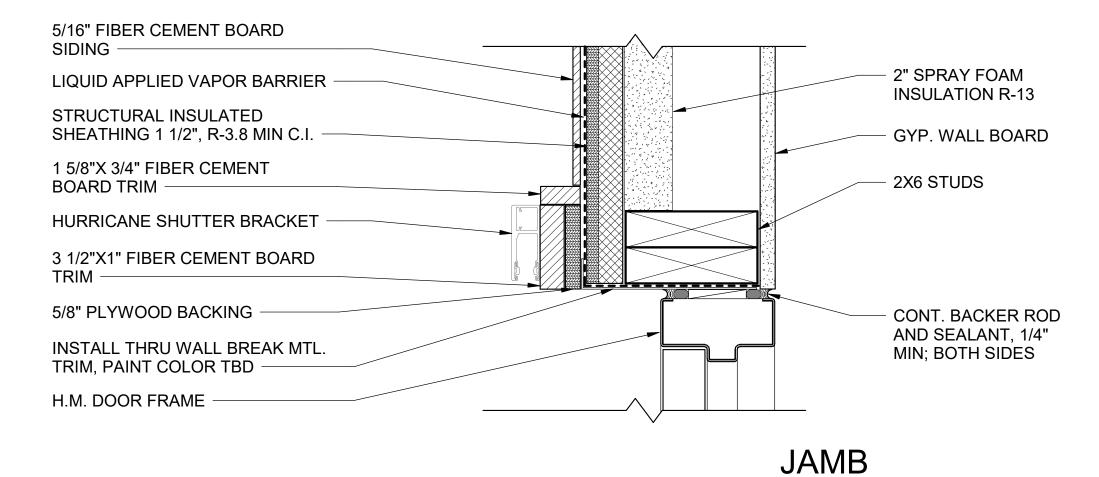


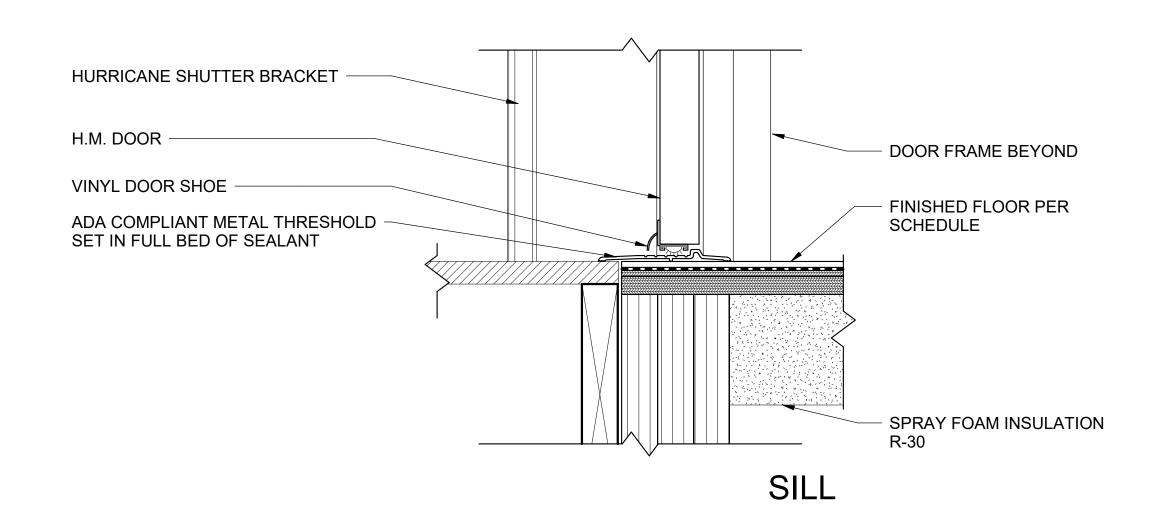



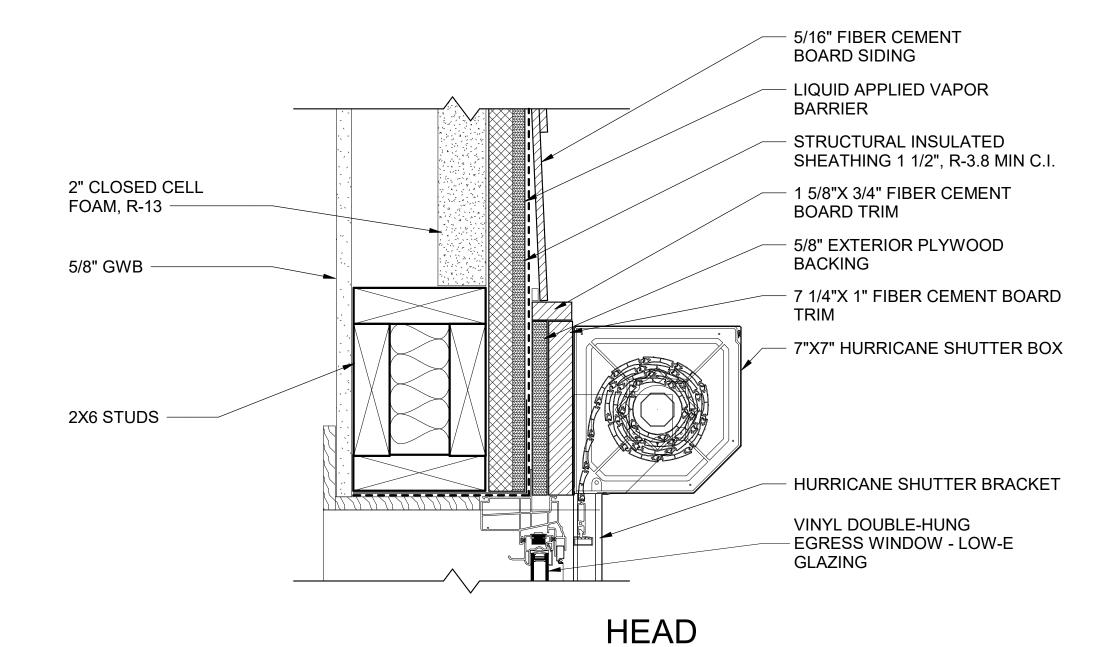


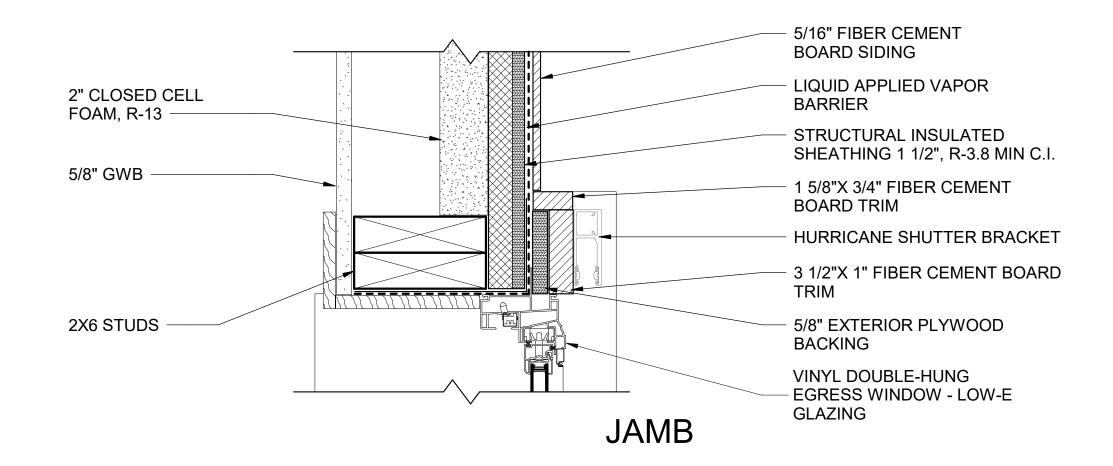

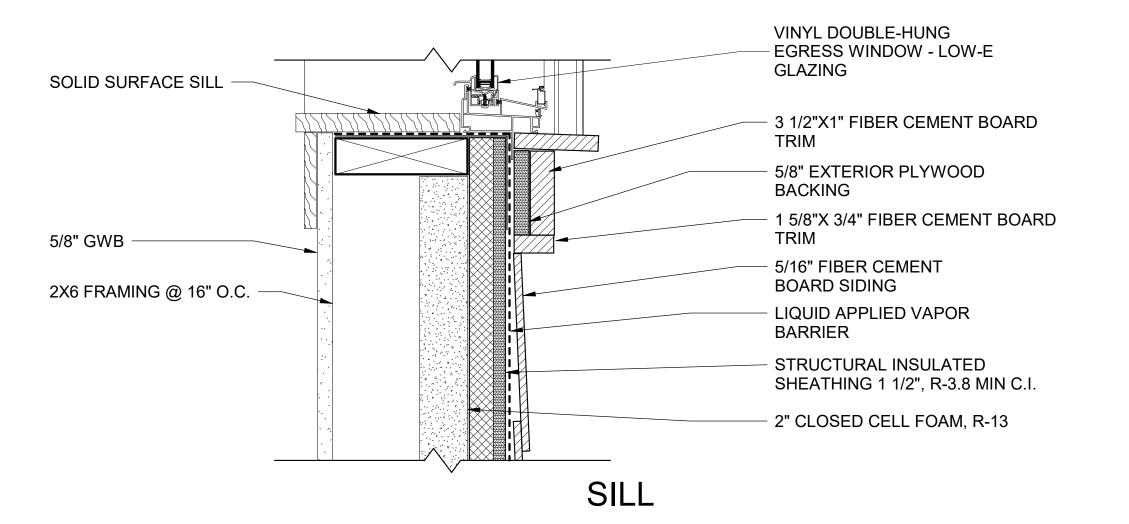

A4 WINDOW\_HEAD\_JAMB\_SILL DETAIL

SCALE: 3" = 1'-0"

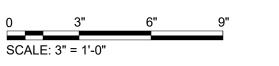

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Suite 500
Peachtree Corners
Georgia 30092

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EOR/AOR SEAL

CONSULTANT

CLIENT INFORMATION

FISH & WILDLIFE SERVICE

U.S. FISH & WILDLIFE SERVICE

PROJECT NAME

Cameron Prairie

National Wildlife
Refuge
Bunkhouse

LA-27 Bell City, LA 70630

DRAWING ISSUE

NOIL

MARK

DESIGNED BY: R. ELLIOTT
DRAWN BY: U. MARGULL
CHECKED BY: K. KOTELLOS
SUBMITTED BY: C. CUSICK
DATE: 02/12/2025
PROJECT #: 1220834

SHEET TITLE

DOOR & WINDOW DETAILS

SHEET NUMBER
A-611

ORIGINAL SHEET SIZE:

24" X 36"

- SEE SHEET A-001 FOR GENERAL NOTES
- SEE SHEET A-002 FOR SYMBOLS AND MATERIALS SEE SHEET A-003 FOR TYPICAL MOUNTING HEIGHTS, LOCATIONS AND DETAILS
- 4. SEE SHEET I-601 FOR ROOM FINISH SCHEDULE
- 5. ALL WALLS TO BE PAINTED PT-1 UNLESS OTHERWISE NOTED.
- 6. INSTALL INSETS AT ALL ELECTRICAL FLOOR BOX LOCATIONS, FLOORING TO MATCH ADJACENT FLOORING
- ALL FINISH SELECTIONS IDENTIFIED IN LEGENDS, SCHEDULES, AND SPECIFICATIONS ARE SUBJECT TO 'OR EQUAL' SUBSTITUTIONS UNLESS NOTED OTHERWISE. THE CONTRACTOR AND SUBCONTRACTORS SHALL SUBMIT PRODUCTS AND FINISHES AS INDICATED IN THE DOCUMENTS.
- NOTIFY OWNER OF SCHEDULED FINISHES THAT ARE UNAVAILABLE OR DISCONTINUED AT THE EARLIEST OPPORTUNITY SUCH THAT A SUBSTITUTION CAN BE SELECTED WITHOUT JEOPARDIZING THE CONSTRUCTION SCHEDULE.
- INSTALL ALL FINISH MATERIALS IN ACCORDANCE WITH THE MANUFACTURER'S RECOMMENDED SPECIFICATIONS, SURFACE PREPARATION, ADHESIVES AND BACKINGS; INCLUDING WALLCOVERINGS, COATINGS, FLOORING MATERIALS, LAMINATES, ETC.
- 10. FLOOR MATERIAL TRANSITIONS AT DOOR OPENINGS ARE TO BE CENTERED BELOW THE DOOR IN THE CLOSED POSITION, UNLESS NOTED OTHERWISE. SEE ALSO TRANSITION DETAILS ON SHEET I-601.
- 11. PROVIDE TRANSITION STRIPS AT ALL FLOORING MATERIAL CHANGES, UNLESS NOTED OTHERWISE PER DETAIL(S) ON SHEET I-601. RESILIENT TRANSITION STRIPS TO MATCH BASE COLOR UNLESS NOTED OTHERWISE. WHEN PROVIDED, REFER TO PLAN FOR ADDITIONAL DETAIL LOCATIONS.
- 12. WHERE FLOOR FINISH THICKNESS REQUIRES, FLOAT FLOOR SLAB AT FINISH TRANSITION AREAS A MINIMUM OF 2'-0" OR TO ACHIEVE A UNIFORM AND FLUSH TRANSITION BETWEEN FINAL FINISHED SURFACES.
- 13. ACCESS PANELS, VISIBLE COVES OR ENCASEMENTS, VISIBLE ELECTRICAL PANELS, ETC. TO BE PAINTED TO MATCH ADJACENT SURFACES.
- 14. ALL INTERIOR WALLS, TRIM AND CEILING FINISHES OF PUBLIC AREAS TO COMPLY WITH CLASS A MATERIAL CLASSIFICATION; FLAME SPREAD RATING 0 TO 25, SMOKE DEVELOPED 200. ALL INTERIOR WALL AND CEILING FINISHES AND TRIM IN NON PUBLIC AREAS TO COMPLY WITH CLASS B MATERIAL CLASSIFICATION; FLAME SPREAD RATING 26 TO 75, SMOKE DEVELOPED 450, PER IBC CHAPTER 8.
- 15. GENERAL CONTRACTOR IS RESPONSIBLE FOR MEETING ALL ACCESSIBILITY REQUIREMENTS FOR ALL FLOORING AND WALL SYSTEMS.
- 16. PROVIDE MOISTURE TESTING OF CONCRETE PER FLOOR MFR PRIOR TO INSTALLATION OF FLOORING SYSTEMS.
- 17. PROVIDE 2 1/2" X 2 1/2" X 48" HIGH STAINLESS-STEEL CORNER GUARDS AT ALL EXPOSED GYPSUM BOARD CORNERS. ALL CORNER GUARDS TO BE SET DIRECTLY ABOVE THE FLOOR BASE.

## FINISH LEGEND

- FAUX WOOD BLINDS
- SOLID SURFACE WINDOW SILL

## FLOOR FINISH LEGEND

LVT-100

LVT-101







SHEET NOTES

3500 Parkway Lane Suite 500

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**EOR/AOR SEAL** 

CONSULTANT

**CLIENT INFORMATION** 



US Fish & Wildlife Service

**PROJECT NAME** 

Cameron Prairie National Wildlife Refuge Bunkhouse

> LA-27 Bell City, LA 70630

> > **DRAWING ISSUE**

DESIGNED BY: DRAWN BY: K. SHELL CHECKED BY: SUBMITTED BY: C. CUSICK 02/12/2025

SHEET TITLE

1220834

INTERIOR FINISH PLAN

PROJECT #:

SHEET NUMBER

I-101

3500 Parkway Lane Suite 500

**Peachtree Corners** Georgia 30092

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**CLIENT INFORMATION** 

U.S. FISH & WILDLIF SERVICE

US Fish & Wildlife Service

Cameron Prairie

**National Wildlife** 

Refuge

Bunkhouse

LA-27

Bell City, LA 70630

**DRAWING ISSUE** 

PROJECT NAME

**ORIGINAL SHEET SIZE:** 24" X 36"

					FINISH SCHE	DULE			
(	SPACE	FLC	OOR		WA	CEILING			
ROOM NO.	ROOM NAME	MAT.	BASE	NORTH	EAST	SOUTH	WEST	FIN.	REMARKS
100	LIVING/DINING AREA	LVT-100	RB-100	PT-100	PT-100	PT-100	PT-100	CP-100	
101	CORRIDOR	LVT-100	RB-100	PT-100	PT-100	PT-100	PT-100	CP-100	
102	KITCHEN	LVT-100	RB-100	PT-100	PT-100	PT-100	PT-100	CP-100	
103	CORRIDOR	LVT-100	RB-100	PT-100	PT-100	PT-100	PT-100	CP-100	
104	JAN	LVT-100	RB-100	FRP/PT-101	FRP/PT-101	FRP/PT-101	FRP/PT-101	CP-100	
105	LAUNDRY	PFT-100	PTB-100	PT-101	PT-101	PT-101	PT-101	CP-100	
106	BEDROOM	LVT-101	RB-100	PT-100	PT-100	PT-100	PT-100	CP-100	
107	BEDROOM	LVT-101	RB-100	PT-100	PT-100	PT-100	PT-100	CP-100	
108	APARTMENT	LVT-101	RB-100	PT-100	PT-100	PT-100	PT-100	CP-100	
109	CLOSET	LVT-101	RB-100	PT-100	PT-100	PT-100	PT-100	CP-100	
110	ADA BATHROOM	PFT-100	PTB-100	PWT-100/PT-101	PWT-100/PT-101	PT-101	PT-101	CP-100	R1. R2.
111	RESTROOM	PFT-100	PTB-100	PWT-10	PWT-100/PT-101	PT-101	PWT-100	CP-100	R1. R2.
112	RESTROOM	PFT-100	PTB-100	PWT-100	PWT-100	PT-101	PWT-100/PT-101	CP-100	R1. R2.
113	CORRIDOR	LVT-100	RB-100	PT-100	PT-100	PT-100	PT-100	CP-100	
114	BEDROOM	LVT-101	RB-100	PT-100	PT-100	PT-100	PT-100	CP-100	
115	BEDROOM	LVT-101	RB-100	PT-100	PT-100	PT-100	PT-100	CP-100	
116	APARTMENT	LVT-101	RB-100	PT-100	PT-100	PT-100	PT-100	CP-100	
117	CLOSET	LVT-101	RB-100	PT-100	PT-100	PT-100	PT-100	CP-100	
118	ADA BATHROOM	PFT-100	PTB-100	PWT-100/PT-101	PWT-100/PT-101	PT-101	PWT-100	CP-100	R1. R2.
119	ADA RESTROOM	PFT-100	PTB-100	PWT-100/PT-101	PWT-100	PT-101	PWT-100/PT-101	CP-100	R1. R2.
120	ADA RESTROOM	PFT-100	PTB-100	PT-101	PWT-100	PT-101	PT-101	CP-100	R1

**NOTE:** CONTRACTORS ARE FREE TO USE ANY PRODUCT WHICH MEETS THE GOVERNMENT'S MINIMUM REQUIREMENTS AND NOT IN CONFLICT WITH OTHER CONTRACT PROVISIONS. UNLESS INDICATED OTHERWISE ON THE PLANS OR SPECIFICATIONS (E.G. SOLE-SOURCE), ALL LISTED MANUFACTURERS ARE THE BASIS OF DESIGN. FOR THESE BASIS OF DESIGN PRODUCTS, OTHER MANUFACTURERS MAY BE SUBSTITUTED AS LONG AS THE STANDARD OF QUALITY AND CHARACTERISTICS OF THE SUBSTITUTED MANUFACTURER MEET OR EXCEED THE STANDARD OF QUALITY AND CHARACTERISTICS OF THE BASIS OF DESIGN.

#### FINISH LEGEND

#### <u>CEILING</u>

CP-100 CEILING PAINT: SHERWIN WILLIAMS, HIGH REFLECTIVE WHITE, SW7757

#### <u>WALLS</u>

PT-100 PAINT: SHERWIN WILLIAMS, AGREEABLE GRAY, SW7029, EGGSHELL PT-101 PAINT: EPOXY PAINT, TWO-PART WATERBASE CATALYZED EPOXY. SHERWIN WILLIAMS, AGREEABLE GRAY, SW7029, EGGSHELL PT-102 PAINT: SHERWIN WILLIAMS, RETREAT, SW6207, EGGSHELL PT-103 PAINT: SHERWIN WILLIAMS, MOUNTAIN ROAD, SW7743, EGGSHELI

PT-104 PAINT: SHERWIN WILLIAMS, THUNDEROUS, SW6201, EGGSHELL TP-100 TRIM PAINT: SHERWIN WILLIAMS, AGREEABLE GRAY, SW7029,

PWT-100PORCELAIN WALL TILE: DALTILE, AVERY, WHITE AV17, 12"X24", TO BE INSTALLED ON ALL SHOWER WALLS AND WET WALLS, INSTALL **VERTICAL 1/3 OFFSET** 

PWT-101PORCELAIN WALL TILE: ARCHITESSA, DAVENPORT WHITE MATTE WALL TILE, 4000-0171-0, 4"X16", INSTALL HORIZONTAL 1/3 OFFSET

#### WALL BASE

RB-100 RUBBER WALL BASE: BURKE, EDGE EFFECTS SIMPLICITY EESIM, EACH SAND 030, 4" HIGH

PTB-100 PORCELAIN WALL BASE: ATLAS CONCORDE USA, FRAY, TAUPE. **BULLNOSE BASE 6"X12"** 

## <u>FLOOR</u>

PFT-100 PORCELAIN FLOOR TILE: ATLAS CONCORDE USA, FRAY, TAUPE 12"X24", INSTALLED 1/3 OFFSET

PTB-1 NOT TO BE USED WITH WALL TILE.

PFT-101 PORCELAIN FLOOR TILE: ATLAS CONCORDE USA, FRAY, TAUPE, HERRINGBONE MOSAIC 12"X12", TO BE INSTALLED IN ALL SHOWER

LVT-100 LUXURY VINYL TILE: J+J FLOORING, FRAMEWORK V5001, ANCHOR 1012, 9"X48", INSTALLED OFFSET

LVT-101 LUXURY VINYL TILE: J+J FLOORING, TATMI V5003, GOZA 1021, 18"X36", INSTALLED OFFSET

#### MISC.

2706

QUARTZ: CORIAN, QUARTZ, ANTIQUE PEARL

SOLID SURFACE: FORMICA, COFFEE SILICA 763 PL-100 PLASTIC LAMINATE: WILSONART, WILSONART, STUDIO TEAK 7960K-18 FAUX WOOD BLINDS: SWF CONTRACT, FAUX PREMIUM WOOD BLINDS, 2" SLATS, MATCHING VALANCE, CORDLESS TILT ONLY, COLOR: MOREL


GR-100 GROUT: MAPIE. KERAPOXY. DRIFTWOOD 105 GR-101 GROUT: MAPIE, KERAPOXY, FROST 77

GR-102 GROUT: MAPIE, KERAPOXY, SAHARA BEIGE 11 WOOD DOOR STAIN: STAIN TO MATCH WILSONART STUDIO TEAK 7960K-18

REMARKS


R1. PWT-100 TO ABUTT PFT-100 ON WET WALLS WITH SCHLUTER TRANSITION TRIM.

R2. SHOWERS TO HAVE PWT-100 ON ALL WALLS.

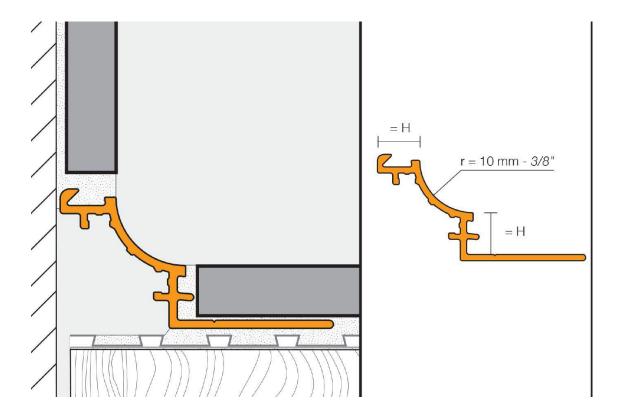

FLOOR TO WALL TILE TRANSITION DETAIL

\*FEATHER FLOOR WITH LEVELING COMPOUND TO ALLOW SMOOTH TRANSITION BETWEEN BOTH FLOORING SURFACES. CONTRACTOR TO ENSURE SMOOTH TRANSITION BETWEEN MATERIALS.

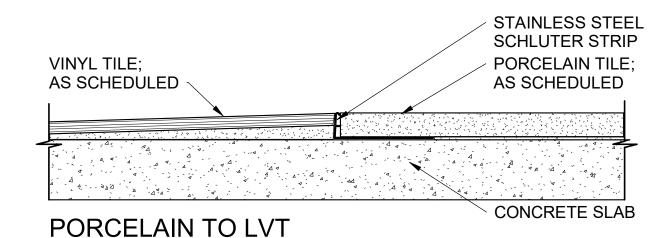

TRANSITION DETAILS

#### MATERIALS & FINISHES **ABBREVIATIONS LIST**

ACOUSTIC CEILING TILE CG CORNER GUARD **CONC** CONCRETE CPT **CARPET** EXP **EXPOSED** GR GROUT **HPC** HIGH PERFORMANCE COATING PLASTIC LAMINATE PFT PORCELAIN FLOOR TILE PTB PORCELAIN TILE BASE **PWT** PORCELAIN WALL TILE LVT LUXURY VINYL TILE PAINT **RUBBER BASE** SOLID SURFACE STN STAIN WALL PROTECTION

1. CONTRACTOR SHALL READ ALL NOTES BEFORE BEGINNING

MANUFACTURER'S PRINTED SPECIFICATIONS AND INSTALLATION

3. ANY DISCONTINUED ITEMS SHALL BE BROUGHT TO THE ATTENTION OF THE GOVERNMENT IMMEDIATELY. CONTRACTOR

4. CONTRACTOR SHALL FIELD VERIFY ALL DIMENSIONS PRIOR TO ORDERING OF MATERIALS. DO NOT SCALE ARCHITECTURAL

DRAWINGS. REFER TO DIMENSIONED PLANS 5. CONTRACTOR SHALL PROVIDE TO OWNER ALL

ON ALL FINISH MATERIALS. CONTRACTOR TO PROVIDE GOVERNMENT WITH SHOP DRAWINGS FOR APPROVAL FOR ALL NEW MATERIALS INSTALLED 6. INTERIOR CONSTRUCTION REQUIRING FINISH / COLOR

MIGHT BE AT A PREMIUM ABOVE THE PRODUCT BID 7. ALL PRODUCT SPECIFICATIONS ARE GIVEN TO DEFINE DESIGN, COLOR AND QUALITY. SUBSTITUTIONS REQUIRE THE PRIOR APPROVAL OF THE GOVERNMENT. PROPOSED SUBSTITUTIONS

8. ALL FIRE HOSE CABINETS, FIRE EXTINGUISHER CABINETS AND ELECTRICAL PANELS SHALL NOT BE PAINTED AS THEY ARE PRE-

### **MILLWORK NOTES**

1. SHOP TO BE CERTIFIED PARTICIPANT IN AWI'S QUALITY CERTIFICATION PROGRAM. NO EXCEPTIONS TAKEN. MILLWORK SHOP TO PROVIDE SHOP DRAWING FOR REVIEW AND APPROVAL BY DESIGNER

2. ALL MILLWORK TO MEET AWI'S PREMIUM STANDARD.

4. MILLWORK, DOORS TO BE FLUSH OVERLAY W/ CONCEALED EUROPEAN HINGES AND 1 7/8"X3 7/8 EDGE PULL, CLEAR SATIN FINISH. MILLWORK SHOP TO PROVIDE SAMPLE TO BE APPROVED BY GOVERNMENT.

5. ALL MDF AND PLYWOOD PRODUCTS TO CONTAIN NO ADDED

1. CONTRACTOR TO FOLLOW MANUFACTURER'S PRINTED INSTALLATION INSTRUCTIONS ON ALL FLOORING PRODUCTS AND USE THE ADHESIVES, EQUIPMENT / TOOLS REQUIRED / RECOMMENDED BY THE MANUFACTURER'S INSTALLATION INSTRUCTIONS 2. CONTRACTOR TO FOLLOW MANUFACTURER'S PRINTED INSTRUCTIONS ON PROTECTION OF FLOORING MATERIAL AFTER INSTALLATION. PROTECT FLOORING AGAINST MARS, INDENTATIONS AND OTHER DAMAGE FROM CONSTRUCTION OPERATIONS, PLACEMENT OF EQUIPMENT AND FIXTURES DURING THE REMAINDER OF THE CONSTRUCTION PERIOD. USE PROTECTION METHODS INDICATED OR RECOMMENDED IN WRITING BY THE FLOOR COVERING MANUFACTURER.

3. CONTRACTOR TO PROVIDE AND INSTALL APPROPRIATE TRANSITION STRIPS WHERE DIFFERING MATERIALS ABUT IF NOT NOTED OTHERWISE. PROVIDE GOVERNMENT WITH COLOR SAMPLES TO SELECT FROM.

4. FLOOR FINISH CHANGES SHALL OCCUR UNDER THE DOOR CENTERLINE (OR CENTER OF THE WALL OPENING IF NO DOOR) BETWEEN ROOMS.

6. CONTRACTOR TO RECESS FLOOR SLAB WERE RECESSED WALK OFF GRILLS ARE SPECIFIED, SEE MANUFACTURER FOR DEPTH. 7. CONTRACTOR TO INSTALL SCHLUTER DITRA, UNCOUPLING MEMBRANE OR APPROVED EQUAL. UNDER ALL PORCELAIN TILE FLOORS. AT ALL PERIMETER LOCATION WHERE PORCELAIN TILE IS INSTALLED, GC SHALL INSTALL SCHLUTER DILEX-BWA PERIMETER JOINT PROFILE.

VANITIES.

9. PFT-100, PORCELAIN FLOOR TILE TO BE INSTALLED WITH A 1/3 OFFSET PATTERN. GC TO USE GR-100

#### WALL FINISH NOTES

1. MISCELLANEOUS GRILLS AND ACCESSORIES SHALL BE PAINTED TO MATCH ADJACENT WALL FINISHES UNLESS THEY ARE PREFINISHED. CONTRACTOR TO VERIFY PAINT COLOR WITH GOVERNMENT

2. SEE FLOOR FINISH PLAN FOR ACCENT PAINT WALL LOCATIONS.

## WINDOW NOTES

1. ALL WINDOW SILLS TO BE SS

2. WINDOW BLINDS WITH FASCIA, WB

2. FURNISH AND INSTALL MATERIALS IN COMPLIANCE WITH

FINISH PLAN GENERAL NOTES

TO NOTIFY GOVERNMENT OF ANY ITEMS REQUIRING FURTHER CLARIFICATION OF FINISH SELECTION.

MANUFACTURER'S RECOMMENDED MAINTENANCE INSTRUCTIONS

SELECTION NOT NOTED WITHIN THE SCHEDULE SHALL BE SUBMITTED TO THE GOVERNMENT IN WRITING, WITH SAMPLES OR FINISH / COLORS AVAILABLE. CLEARLY IDENTIFYING ANY THAT

SHALL ADHERE TO THE INTENT OF THE QUALITY, DESIGN, COLOR AND PATTERN.

FINISHED.

3. 120 DEGREE EURO SELF CLOSING HINGES

UREA FORMALDEHYDE.


## DOOR & FRAME NOTES

1. ALL NEW DOOR FRAMES SHALL BE PAINTED TP-100 ON BOTH SIDE OF DOORS (UNLESS NOTED OTHERWISE).

## FLOOR FINISH NOTES

5. WATER BASED NON-SKID FINISH TO BE APPLIED TO ALL POLISHED

8. ALL FLOORING SHOULD CONTINUE UNDER EQUIPMENT AND

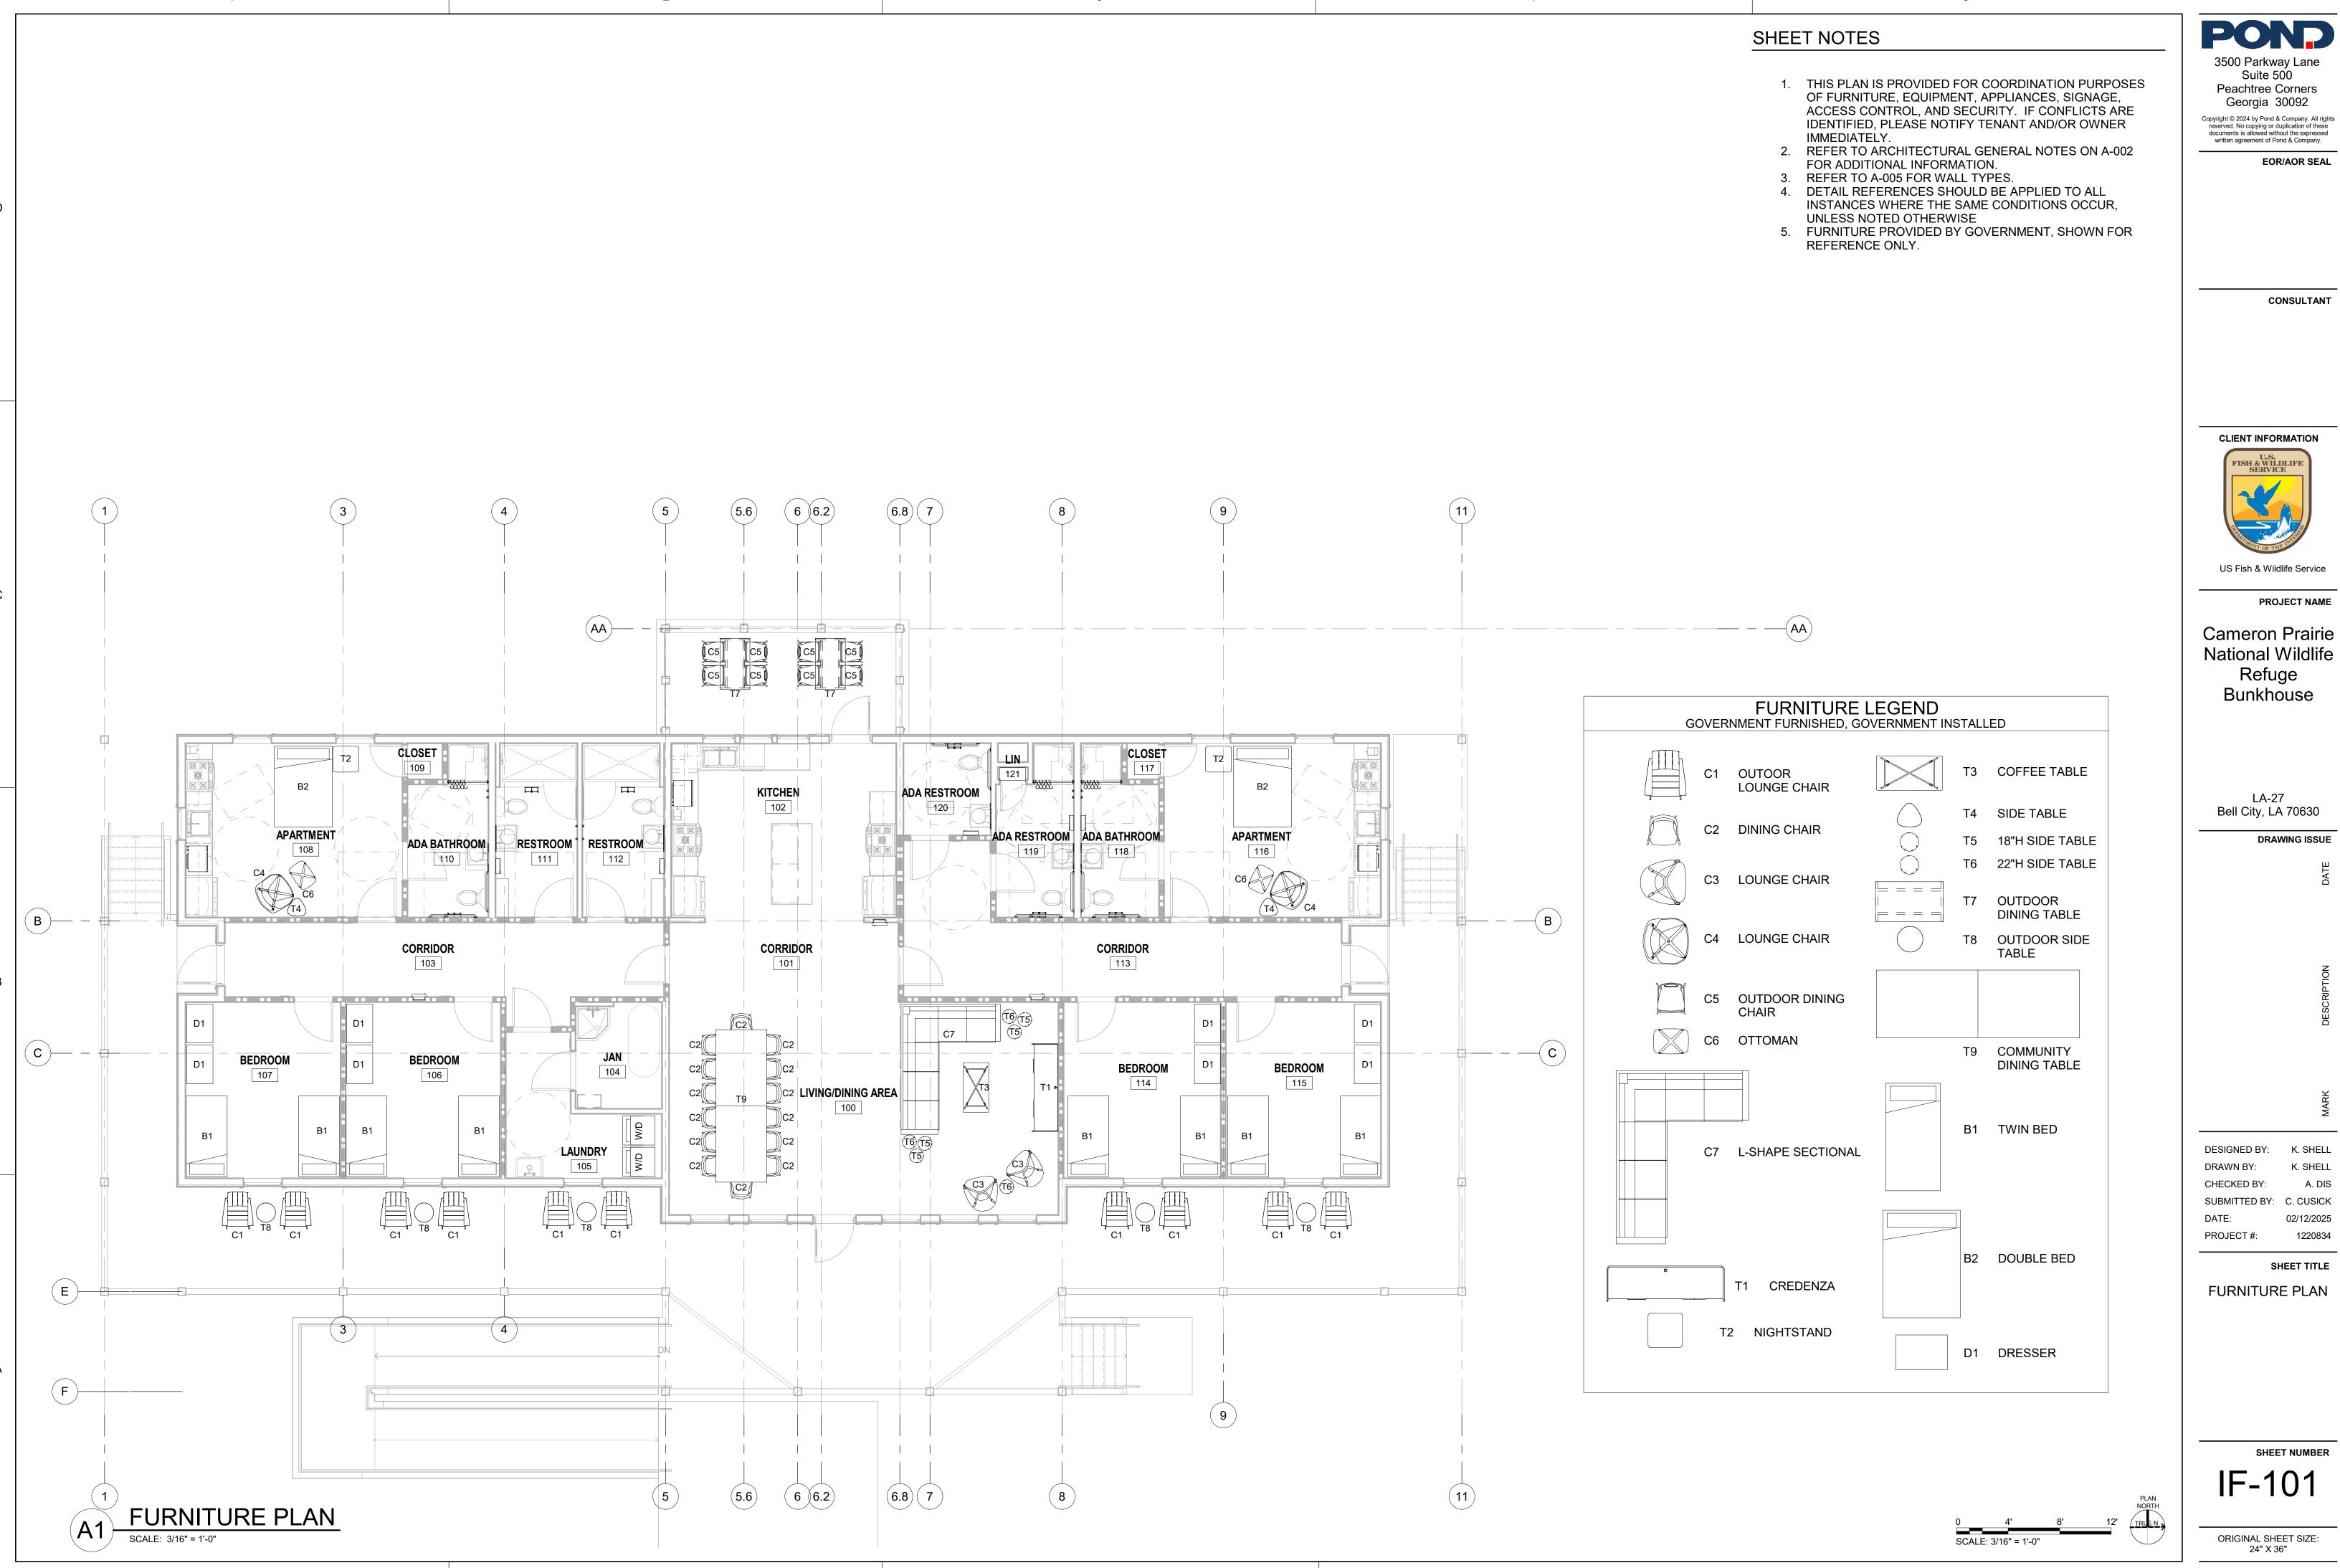


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Peachtree Corners

Georgia 30092

CONSULTANT



**PROJECT NAME** 

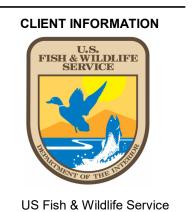Cameron Prairie National Wildlife Refuge Bunkhouse

> LA-27 Bell City, LA 70630


**DRAWING ISSUE** 

**DESIGNED BY:** CHECKED BY: SUBMITTED BY: C. CUSICK 02/12/2025 PROJECT #:

SHEET TITLE

FURNITURE PLAN

SHEET NUMBER IF-101

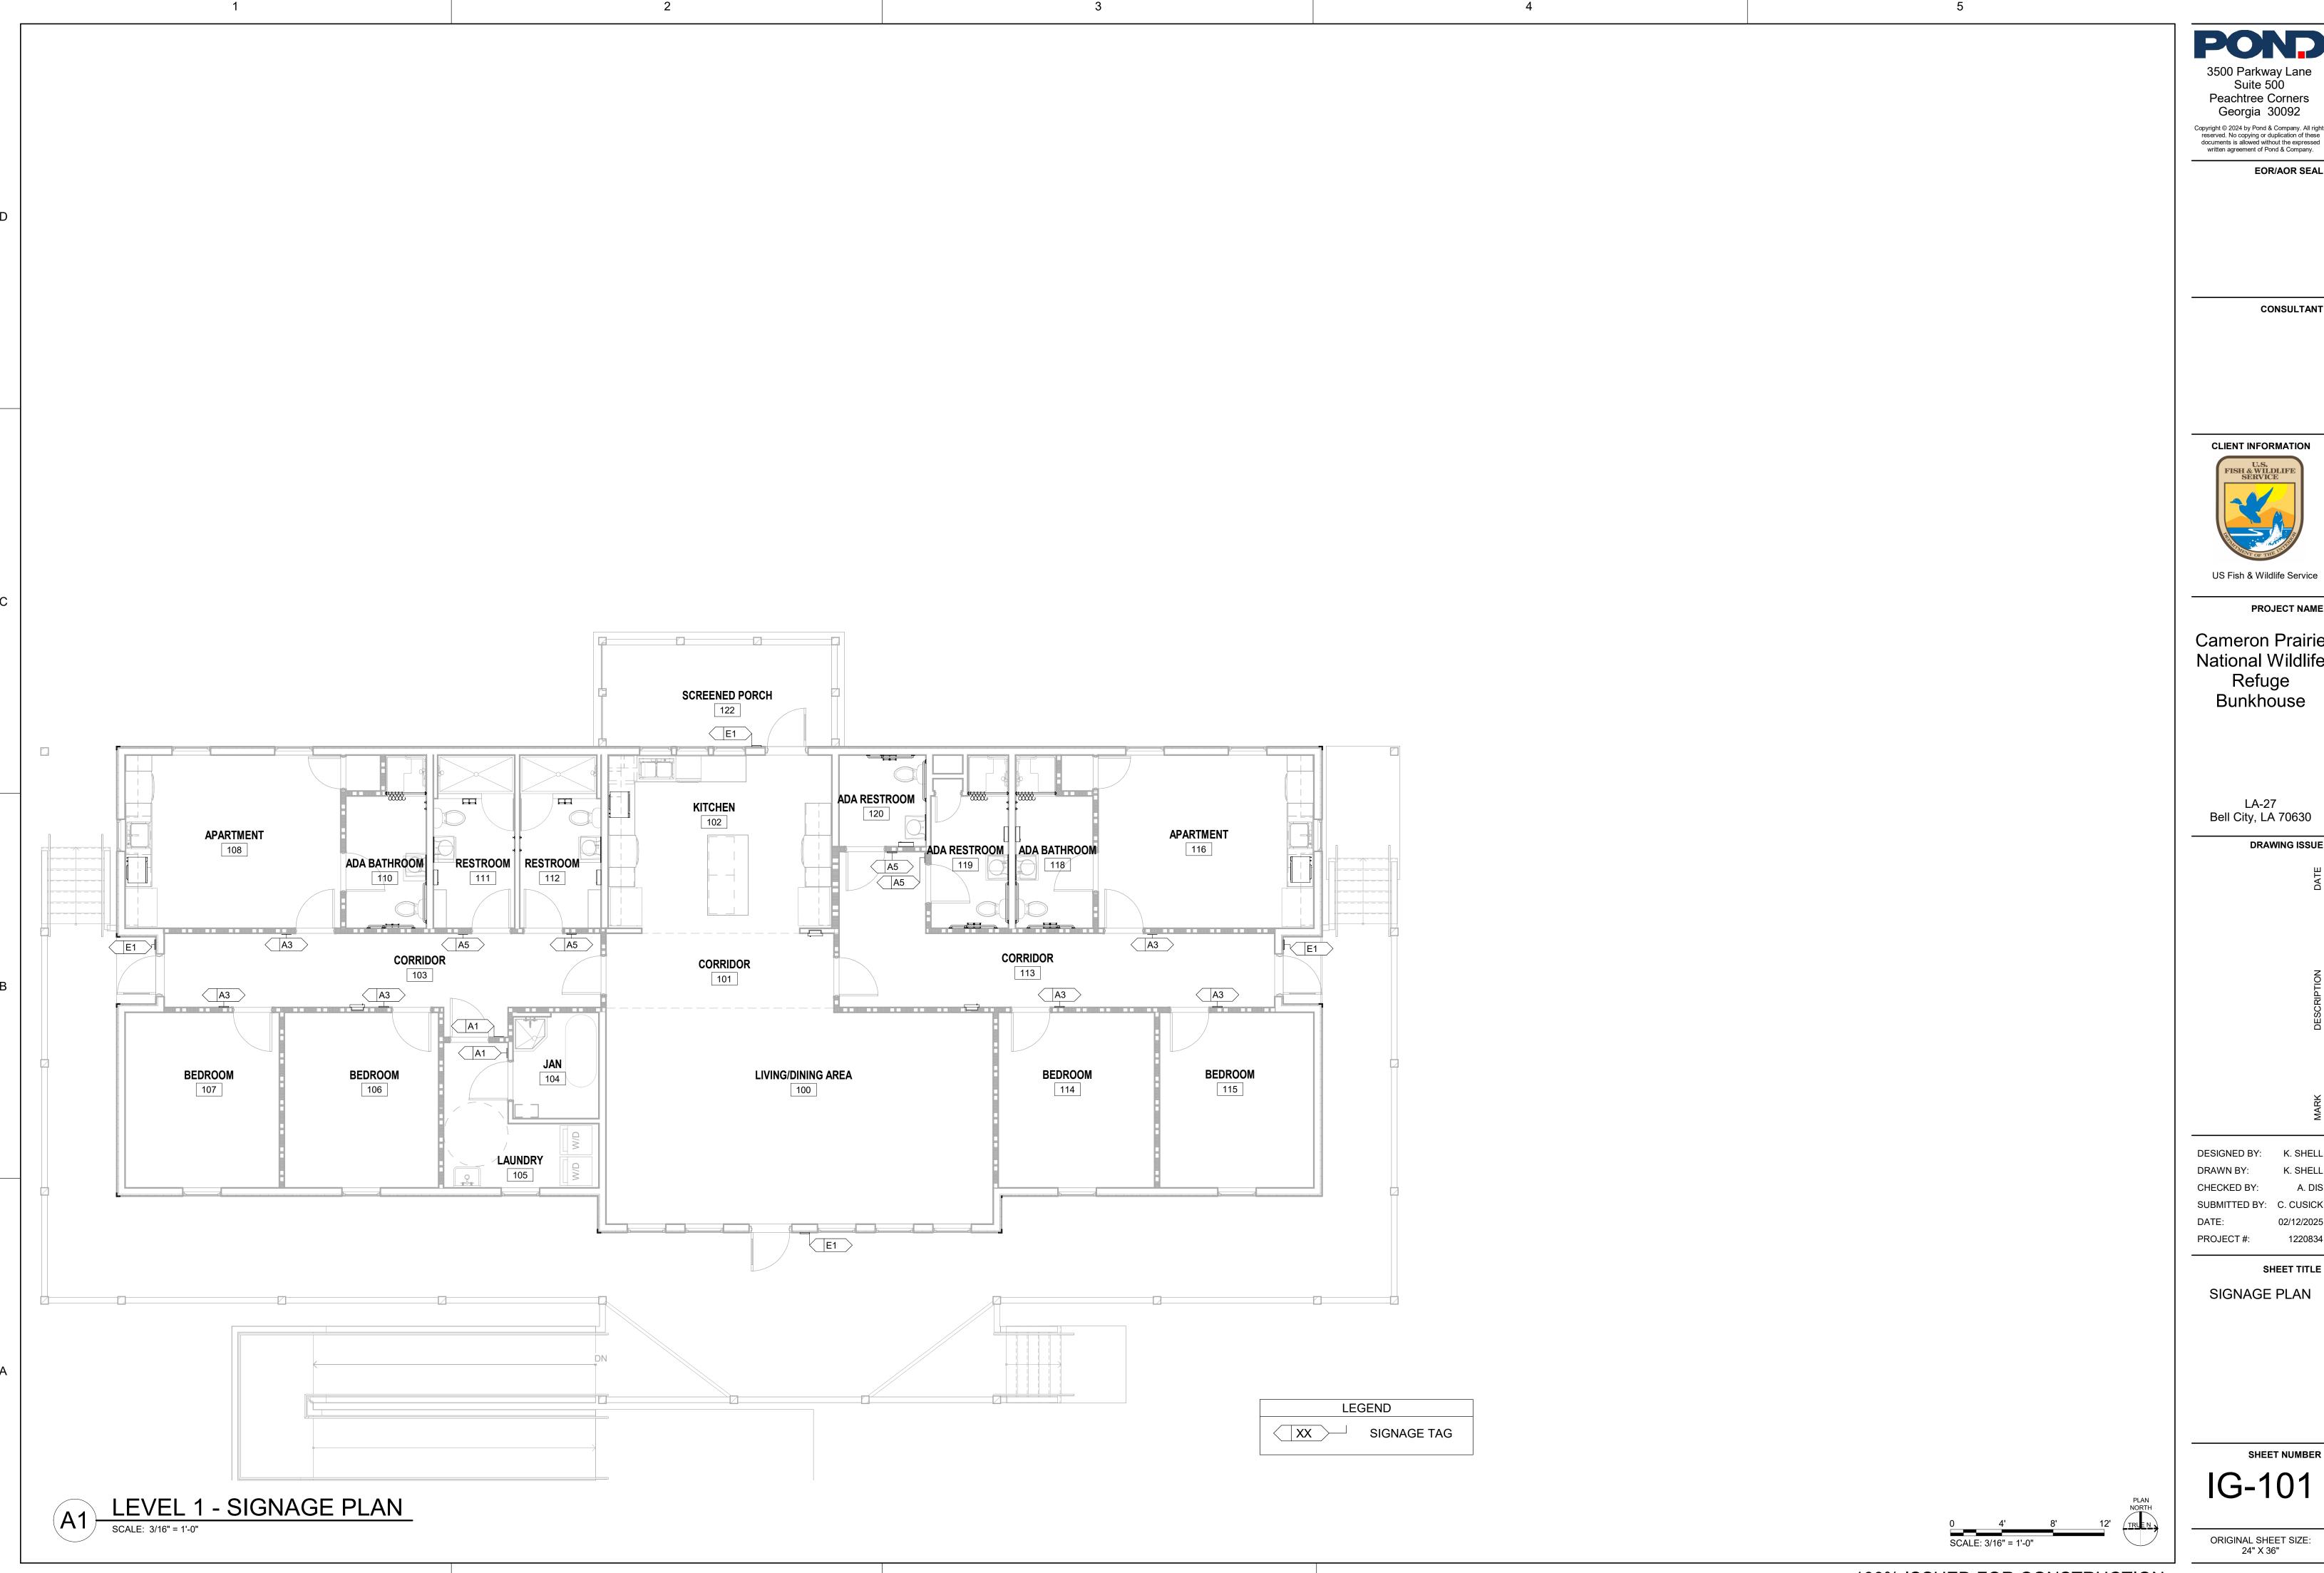

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**CLIENT INFORMATION** 

PROJECT NAME

Cameron Prairie National Wildlife Refuge Bunkhouse

LA-27 Bell City, LA 70630

DRAWING ISSUE

DESIGNED BY: K. SHELL

CHECKED BY: PROJECT #:

SHEET TITLE

SIGNAGE PLAN

IG-101

SIGNAGE SCHEDULE										
		ROOM DATA			MOUNTING LOCATION L = LEFT OF DOOR					
DOOR TAG	ROOM NUMBER	ROOM NAME ON SIGN	ROOM NO. ON SIGN	EXACT TEXT FOR SIGNAGE MESSAGE	R = RIGHT OF DOOR C = CENTER OF DOOR	SIGN TYPE	REMARKS			
102	102	KITCHEN	-	NO SMOKING	R	E1				
104	104	JAN	104	JANITOR	L	A1				
105	105	LAUNDRY	105	LAUNDRY	L	A1				
106	106	BEDROOM	106	TBD	R	A3				
107	107	BEDROOM	107	TBD	R	A3				
108	108	APARTMENT	108	TBD	L	A3				
111	111	RESTROOM	111	RESTROOM	L	A5				
112	112	RESTROOM	112	RESTROOM	R	A5				
114	114	BEDROOM	114	TBD	L	A3				
115	115	BEDROOM	115	TBD	L	A3				
116	116	APARTMENT	116	TBD	R	A3				
119	119	ADA RESTROOM	119	RESTROOM	L	A5				
120	120	ADA RESTROOM	120	RESTROOM	R	A5				
E001	100	LIVING/DINING AREA	-	NO SMOKING	R	E1				
E002	113	CORRIDOR	-	NO SMOKING	R	E1				
E003	103	CORRIDOR	-	NO SMOKING	L	E1				

## SIGNAGE SCHEDULE GENERAL NOTES

1. SIGNAGE TO COMPLY WITH THE APPLICABLE REQUIREMENTS OF NFPA 101, IBC, AND ICC A117.1-2009.

2. SIGN TYPES ARE CLASSIFIED BY FUNCTION ACCORDING TO THE FOLLOWING CATEGORIES:

TYPE A - ROOM, SPACE, AND WORKSTATION IDENTIFICATION.

TYPE B - LIFE SAFETY 3. CONTRACTOR TO COORDINATE SIGNS WITH SIGNAGE

STANDARDS AND TYPES PRIOR TO FABRICATION. 4. VERIFY ROOM NUMBERS, ROOM NAMES, TEXT, GRAPHICS, AND LOCATION OF SIGNS WITH CONTRACTING OFFICER'S

REPRESENTATIVE. 5. MOUNTING LOCATION REFERS TO THE LOCATION OF THE SIGN WHILE FACING THE DOOR / FRAME.

L=LEFT

R=RIGHT

C=CENTER OF DOOR LEAF

ADJ=ADJACENT WALL AS SHOWN ON SIGNAGE PLAN 6. COLOR(S) OF PANEL SIGNAGE BACKING MATERIAL TO BE

SELECTED DURING SUBMITTAL REVIEWS.

7. RAISED TEXT AND BRAILLE CHARACTERS SHALL BE WHITE, UNLESS NOTED OTHERWISE.

8. TACTILE ELEVATOR HOISTWAY LEVEL INDICATOR SIGNS TO BE FURNISHED AND INSTALLED BY ELEVATOR MANUFACTURER. 9. SIGNAGE FOR FIRE EXTINGUISHERS (FE) AND FE CABINETS TO BE FURNISHED BY MANUFACTURER AND INSTALLED BY CONTRACTOR. 10. ALL INTERIOR SIGNAGE SHOULD HAVE DOUBLE SIDED EMULSION

COUNTERSUNK SCREWS. 11. CLEAR ACRYLIC NOT ACCEPTABLE. COLOR TO BE SELECTED FROM MANUFACTURER'S STANDARDS.

FOAM TAPE AND ALL EXTERIOR PERMANENT SIGNAGE TO HAVE


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CONSULTANT



US Fish & Wildlife Service

**PROJECT NAME** 

Cameron Prairie National Wildlife Refuge Bunkhouse

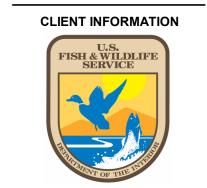LA-27 Bell City, LA 70630

**DRAWING ISSUE** 

DESIGNED BY: K. SHELL


K. SHELL DRAWN BY: CHECKED BY: A. DIS SUBMITTED BY: C. CUSICK 02/12/2025 1220834 PROJECT #:

SHEET TITLE

SIGNAGE SCHEDULE

SHEET NUMBER IG-601

ORIGINAL SHEET SIZE: 24" X 36"

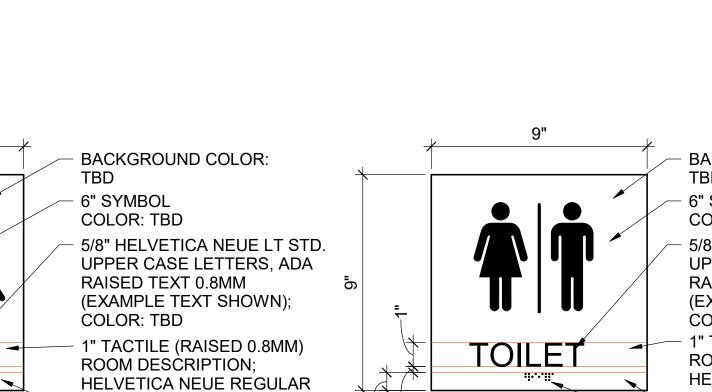

BACKGROUND COLOR: 6" SYMBOL COLOR: TBD 5/8" HELVETICA NEUE LT STD. UPPER CASE LETTERS, ADA RAISED TEXT 0.8MM (EXAMPLE TEXT SHOWN); COLOR: TBD 1" TACTILE (RAISED 0.8MM) ROOM DESCRIPTION; HELVETICA NEUE REGULAR BACKER PANEL; COLOR: TBD **GRADE TWO BRAILLE** 


SUBSURFACE (COLOR TO COORDINATE WITH INTERIOR COLOR SCHEME) - GRAPHICS SURFACE APPLIED TO FRONT SIDE OF ACRYLIC -DOUBLE EMULSION FOAM TAPE POLISHED EDGES ALL AROUND FINISHED WALL **SECTION** 

DOUBLE EMULSION FOAM TAPE

1/8" (3MM) NON-GLARE

**ACRYLIC WITH PAINTED** 

RED CIRCLE W/ RED DIAGONAL BAR BACKGROUND COLOR: TBD SYMBOL COLOR: **BLACK** 1/2" [12mm] HELVETICA MEDIUM CAPITAL SMOKING IS PROHIBITED LETTERS, CENTERED ON WITHIN 50 FEET PANEL; COLOR: TBD OF BUILDING

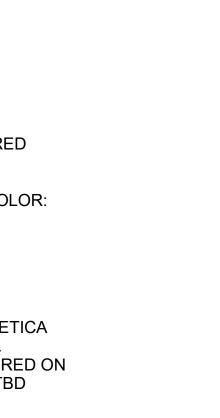

SIGN TYPE PLACEMENT

## POLISH EDGES ALL AROUND

**TYPE A1, A3, A5** 

**ROOM IDENTIFICATION** 

LATCH SIDE


OF SINGLE

FRAME OR

**ENTRY TO** 

DOOR


ROOM

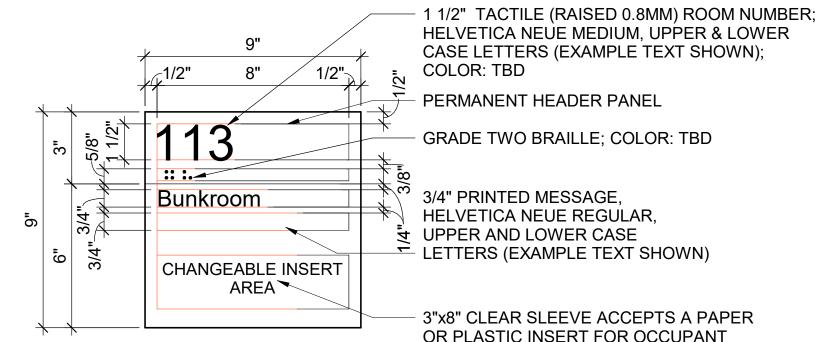


GRADE TWO BRAILLE; COLOR: TBD 3/4" PRINTED MESSAGE, HELVETICA NEUE REGULAR, UPPER AND LOWER CASE LETTERS (EXAMPLE TEXT SHOWN) 3"x8" CLEAR SLEEVE ACCEPTS A PAPER OR PLASTIC INSERT FOR OCCUPANT NAME. INSERT WILL ACCOMMODATE TWO LINES WITH A MAX. OF 21 CHARACTERS PER LINE

SIGNAGE E1

SCALE: 3" = 1'-0"

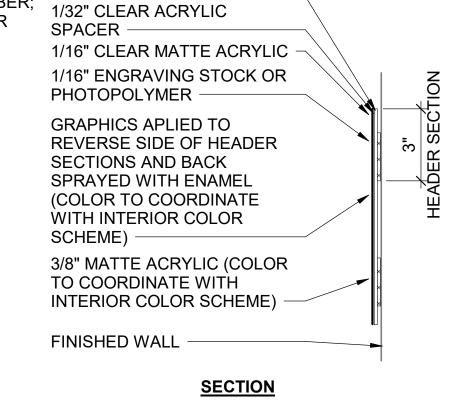

SIGNAGE A3

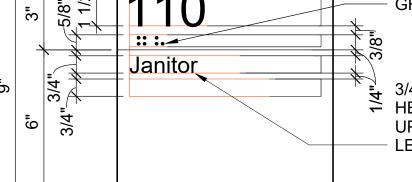

8"

**TOILET** 

SIGNAGE A5

**UNISEX ADA** 

COLOR: TBD PERMANENT HEADER PANEL GRADE TWO BRAILLE; COLOR: TBD

1 1/2" TACTILE (RAISED 0.8MM) ROOM NUMBER;

HELVETICA NEUE MEDIUM, UPPER & LOWER

CASE LETTERS (EXAMPLE TEXT SHOWN);

3/4" PRINTED MESSAGE, → HELVETICA NEUE REGULAR, UPPER AND LOWER CASE LETTERS (EXAMPLE TEXT SHOWN)

BACKER PANEL; COLOR: TBD

GRADE TWO BRAILLE

INTERIOR COLOR SCHEME)

FINISHED WALL **SECTION** 

POLISH EDGES ALL AROUND

1/16" CLEAR MATTE ACRYLIC

1/16" ENGRAVING STOCK OR

REVERSE SIDE OF HEADER

(COLOR TO COORDINATE

3/8" MATTE ACRYLIC (COLOR

WITH INTERIOR COLOR

TO COORDINATE WITH

1/32" CLEAR ACRYLIC

PHOTOPOLYMER -

GRAPHICS APLIED TO

SECTIONS AND BACK SPRAYED WITH ENAMEL

SPACER

SCHEME)

<u>UNISEX</u>

SIGNAGE A1

100% ISSUED FOR CONSTRUCTION

SCALE: 3" = 1'-0"

**B1** 

1. DESIGN AND INSTALLATION SHALL BE IN ACCORDANCE WITH THE LOUISIANA STATE UNIFORM CONSTRUCTION CODE (LSUCC) WITH 2023 AMENDMENTS; INTERNATIONAL BUILDING CODE (IBC) 2021 EDITION WITH LSUCC AMENDMENTS; NFPA 1, "FIRE CODE" 2021 EDITION; NFPA 70, "NATIONAL ELECTRICAL CODE" 2023 EDITION; NFPA 72, "NATIONAL FIRE ALARM AND SIGNALING CODE" 2022 EDITION; AND NFPA 101, "LIFE SAFETY CODE" 2021 EDITION.

2. CONTRACTOR SHALL FURNISH AND INSTALL A COMPLETE FIRE ALARM SYSTEM IN ACCORDANCE WITH NFPA 72, NFPA 101, AND THE REQUIREMENTS OF THE LOCAL AUTHORITY HAVING JURISDICTION (AHJ). THE SYSTEM SHALL BE COMPLETE TO PROVIDE ALL NECESSARY EQUIPMENT TO SERVE ALL REQUIRED

3. FIRE ALARM FLOOR PLAN IS DIAGRAMMATIC AND NOT INTENDED TO SHOW EACH AND EVERY COMPONENT, DEVICE, APPLIANCE, ETC. CONDUIT PATHWAYS AND INTERCONNECTIONS SHALL BE DETERMINED BY THE BUILDING FEATURES, NFPA 70, NFPA 72, SYSTEM MANUFACTURER REQUIREMENTS AND RECOMMENDATIONS.

4. CONTRACTOR SHALL REVIEW PROJECT DOCUMENTS AND SPECIFICATIONS PRIOR TO BID TO BECOME FAMILIAR WITH THE SCOPE OF WORK. NOTIFY ENGINEER OF RECORD WITH ANY DISCREPANCIES OUTSIDE THIS DESIGN INTENT. ANY CHANGE ORDER REQUEST AS A RESULT OF COORDINATION BETWEEN TRADES SHALL BE DENIED.

CALCULATIONS, VOLTAGE DROP CALCULATIONS, MATERIAL SPECIFICATION BROCHURE, AND SHOP DRAWINGS TO CONTRACTING OFFICER'S REPRESENTATIVE FOR REVIEW PRIOR TO COMMENCING ORDERING/PURCHASING, FAILURE TO COMPLY

AND LOCAL GOVERNMENT REQUIREMENTS.

7. DO NOT SCALE PLANS FOR THE PURPOSE OF ESTABLISHING DIMENSIONS. FIELD DIMENSIONS GOVERN.

8. FIRE STOP ALL PENETRATIONS OF SMOKE/FIRE PARTITIONS. FIRE STOPPING SHALL BE OF UL LISTED ASSEMBLY.

CONTRACTOR SHALL COORDINATE ALL NEW FIRE ALARM WORK WITH OTHER TRADES. CONTRACTOR SHALL COORDINATE ALL FIRE ALARM DEVICE LOCATIONS WITH THE ARCHITECTURAL PLANS.

10. A LICENSED FIRE ALARM CONTRACTOR SHALL APPLY FOR PLANS REQUIRED BY THE LOCAL AHJ.

PROVIDE REQUIRED AUDIO/VISUAL COVERAGE THROUGHOUT ALL AREAS IN SCOPE.

12. COORDINATE WITH FIRE ALARM VENDOR FOR SYSTEM

13. ALL NOTIFICATION APPLIANCES CIRCUITS (NAC), SIGNALING LINE CIRCUITS (SLC), AND INDICATING DEVICE CIRCUITS (IDC) SHALL

14. PROVIDE TRANSIENT VOLT SURGE SUPPRESSION DEVICE WHERE CIRCUITS PENETRATE THE BUILDING ENVELOPE AND FIRE ALARM EQUIPMENT SUPPLIED FROM THE BUILDING ELECTRICAL SYSTEM IN ACCORDANCE WITH NFPA 70 AND NFPA 72 REQUIREMENTS.

16. FIRE ALARM MANUAL PULL STATIONS AT DOOR OPENINGS SHALL

17. FIRE ALARM SYSTEM SHALL REPORT TO CAMERON PARISH FIRE

FIRE ALARM ANNUNCIATOR

FIRE ALARM COMMUNICATOR

FIRE ALARM COMBINATION HORN AND CLEAR VISUAL

WP = WEATHERPROOF

WALL MOUNT. NUMBER "15" INDICATES CANDELA LEVEL.

**SMOKE DETECTOR** 

FLOW DETECTOR/SWITCH

VALVE SUPERVISORY SWITCH

SCALE: 3/16" = 1'-0"

SHEET NOTES

5. CONTRACTOR SHALL SUBMIT COMPLETE BATTERY IS AT THE RISK OF THE CONTRACTOR.

3. ADHERE TO AND OBTAIN ALL PERMITS, LICENSES AND ALL STATE

PERMIT AND PROVIDE ANY ASSOCIATED CALCULATIONS OR

11. ADJUST AND/OR ADD FIRE ALARM DEVICES AS NECESSARY TO

OPERATING INSTRUCTIONS AND WIRING DIAGRAMS.

PERFORM TO CLASS "B"

15. ALL FIRE ALARM PANELS AND EQUIPMENT SHALL BE GROUNDED IN ACCORDANCE WITH NFPA 70 ARTICLE 250 AND 800 WITH A MAXIMUM OF 25 OHMS RESISTANCE.

BE WITHIN 5' - 0" HORIZONTALLY OF THE DOOR OPENING.

DEPARTMENT.

FIRE ALARM CONTROL UNIT

MANUAL FIRE ALARM PULL STATION

STROBE. WALL MOUNT. NUMBER "15" INDICATES CANDELA LEVEL.

FIRE ALARM COMBINATION CLEAR VISUAL STROBE. WP = WEATHERPROOF

S = 520 Hz AUDIO SIGNAL

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CONSULTANT

**CLIENT INFORMATION** 



US Fish & Wildlife Service

**PROJECT NAME** 

Cameron Prairie National Wildlife Refuge Bunkhouse

LA-27 Bell City, LA 70630

**DRAWING ISSUE** 

DESIGNED BY: J. CAHILL DRAWN BY: Z. MITCHELL CHECKED BY: N.SHEWFELT SUBMITTED BY: C. CUSICK

SHEET TITLE

02/12/2024

1220834

FIRE ALARM FLOOR PLAN

PROJECT #:

**SHEET NUMBER** 

ORIGINAL SHEET SIZE:

24" X 36"

FA101

FIRE SUPPRESSION FLOOR PLAN

#### SHEET NOTES

- 1. DESIGN AND INSTALLATION SHALL BE IN ACCORDANCE WITH THE LOUISIANA STATE UNIFORM CONSTRUCTION CODE (LSUCC) WITH 2023 AMENDMENTS: INTERNATIONAL BUILDING CODE (IBC) 2021 EDITION WITH LSUCC AMENDMENTS; NFPA 1, "FIRE CODE" 2021 EDITION; NFPA 13D, "STANDARD FOR THE INSTALLATION OF SPRINKLER SYSTEMS IN ONE- AND TWO-FAMILY DWELLINGS AND MANUFACTURES HOMES" 2022 EDITION; AND NFPA 101, "LIFE SAFETY CODE" 2021 EDITION.
- 2. CONTRACTOR SHALL FURNISH AND INSTALL A COMPLETE WET PIPE FIRE SUPPRESSION SYSTEM IN ACCORDANCE WITH NFPA 13D AND THE REQUIREMENTS OF THE LOCAL AUTHORITY HAVING JURISDICTION (AHJ). THE SYSTEM SHALL BE COMPLETE TO PROVIDE ALL NECESSARY EQUIPMENT TO SERVE ALL AREAS REQUIRED BY NFPA 13D.
- 3. THE INTENT AND EXTENT OF THE FIRE PROTECTION SYSTEM DESIGN IS A DELEGATED DESIGN AND IS DIAGRAMMATIC ONLY. IT IS NOT INTENDED TO SHOW EVERY PIPE, FITTING, DEVICE, APPLIANCE, COMPONENT, ETC.
- 4. CONTRACTOR SHALL REVIEW PROJECT DOCUMENTS AND SPECIFICATIONS PRIOR TO BID TO BECOME FAMILIAR WITH THE SCOPE OF WORK. NOTIFY ENGINEER OF RECORD WITH ANY DISCREPANCIES OUTSIDE THIS DESIGN INTENT. ANY CHANGE ORDER REQUEST AS A RESULT OF COORDINATION BETWEEN TRADES SHALL BE DENIED.
- 5. CONTRACTOR SHALL SUBMIT COMPLETE HYDRAULIC CALCULATIONS, MATERIAL SPECIFICATION BROCHURE, AND SHOP DRAWINGS TO CONTRACTING OFFICER'S REPRESENTATIVE FOR REVIEW PRIOR TO COMMENCING ORDERING/PURCHASING. FAILURE TO COMPLY IS AT THE RISK OF THE CONTRACTOR.
- 6. ADHERE TO AND OBTAIN ALL PERMITS, LICENSES, AND ALL STATE AND LOCAL GOVERNMENT REQUIREMENTS.
- 7. DO NOT SCALE PLANS FOR THE PURPOSE OF ESTABLISHING DIMENSIONS. FIELD DIMENSIONS GOVERN.
- 8. FIRE STOP ALL PENETRATIONS OF SMOKE/FIRE PARTITIONS. FIRE STOPPING SHALL BE OF UL LISTED ASSEMBLY.
- 9. CONTRACTOR SHALL COORDINATE ALL NEW SPRINKLER WORK WITH OTHER TRADES. CONTRACTOR SHALL COORDINATE ALL SPRINKLER HEAD LOCATIONS WITH THE ARCHITECTURAL REFLECTED CEILING PLAN AND ALL CEILING MOUNTED DEVICES.
- 10. CONTRACTOR SHALL BE RESPONSIBLE FOR AVOIDING ALL CONFLICTS WITH LIGHTING FIXTURES, DIFFUSERS, GRILLS, DUCTS, CABLES, CONDUITS, UTILITY PIPING AND ALL OTHER OBSTRUCTIONS ENCOUNTERED.
- 11. THE SYSTEM SHALL PROVIDE AT LEAST THE FLOW REQUIRED TO PRODUCE A MIN DISCHARGE DENSITY OF 0.05 GPM/FT<sup>2</sup> OR THE SPRINKLER LISTING, WHICHEVER IS GREATER, TO THE DESIGN SPRINKLERS. MAXIMUM FLOW IS 13 GPM PER SPRINKLER HEAD. THIS CRITERIA SHALL BE APPLIED THROUGHOUT THE ENTIRETY OF THE BUILDING, EXCEPT WHERE INDICATED.
- 12. SPRINKLERS SHALL BE LISTED RESIDENTIAL TYPE. PENDENT SPRINKLERS SHALL BE WHITE FRAME & ESCUTCHEON, SIDEWALL SPRINKLERS SHALL BE WHITE FRAME & ESCUTCHEON.
- 13. PROVIDE NECESSARY PIPING AUXILIARY DRAINS FOR THE WET PIPE SPRINKLER SYSTEM AS REQUIRED BY NFPA 13D.
- 14. PROVIDE NECESSARY PIPE HANGERS AND PIPING SUPPORTS AS REQUIRED BY NFPA 13D.

#### # KEYNOTES


1. NFPA 13D PUMP AND TANK SYSTEM. CONTRACTOR SHALL DETERMINE FINAL SIZE BASED ON THEIR DESIGN. FINAL LOCATION SHALL BE COORDINATED WITH THE AHJ AND THE USERS. CONTRACTOR SHALL PROVIDE INITIAL WATER FILL OF THE TANK VIA A HOSE CONNECTION TO THE DOMESTIC WATER SUPPLY IN THE JANITOR'S CLOSET. BASIS OF DESIGN FOR NFPA 13D PUMP AND TANK SYSTEM SHALL BE THE FOLLOWING:

H2HOME MODEL H2H425-A04 PUMP MOTOR: 2 HP, SINGLE PHASE, 60 HZ, 240 V TANK SIZE: 425 GAL DIMENSIONS: 68"L X 29"W X 76"H

2. PROVIDE HIGH TEMPERATURE SPRINKLER HEADS IN LAUNDRY ROOM.

## LEGEND

NON-SPRINKLERED SPACE

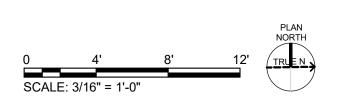

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**CLIENT INFORMATION** 



US Fish & Wildlife Service

PROJECT NAME

Cameron Prairie National Wildlife Refuge Bunkhouse

> LA-27 Bell City, LA 70630

> > **DRAWING ISSUE**

DESIGNED BY: J. CAHILL DRAWN BY: Z. MITCHELL CHECKED BY: N.SHEWFELT SUBMITTED BY: C. CUSICK 02/12/2024

SHEET TITLE

1220834

**FIRE** SUPPRESSION **FLOOR PLAN** 

PROJECT #:

SHEET NUMBER

FX101

2. DEMOLISHED EQUIPMENT IS SHOWN WITH BOLD LINEWORK, DASHED, AND HATCHED.

EXISTING EQUIPMENT IS SHOWN WITH THIN LINEWORK.

3. NEW OR RELOCATED EQUIPMENT IS SHOWN WITH BOLD LINEWORK.

4. BELOW IS AN EXAMPLE OF EACH:

EXISTING EQUIPMENT OR EQUIPMENT BY OTHERS

**NEW OR RELOCATED EQUIPMENT** 

**EQUIPMENT TO BE DEMOLISHED** 

PLUMBING GENERAL NOTES:

1. PLUMBING WORK MUST BE IN ACCORDANCE WITH THE INTERNATIONAL BUILDING CODE. INTERNATIONAL PLUMBING CODE AND INTERNATIONAL FUEL GAS CODE.

2. SLOPES AND INVERT ELEVATIONS MUST BE ESTABLISHED BEFORE ANY PIPE IS INSTALLED IN ORDER TO MAINTAIN PROPER SLOPES. ANY DISCREPANCIES MUST BE REPORTED TO CONTRACTING OFFICER'S REPRESENTATIVE. ALL PIPING MUST BE LOCATED AND DETERMINED WHEN TO BE INSTALLED TO AVOID CONFLICT WITH OTHER TRADES

3. PIPING MUST BE CONCEALED UNLESS OTHERWISE NOTED

4. KEEP ALL BURIED PIPING CLEAR OF FOOTINGS. COORDINATE WITH STRUCTURAL

5. ALL WALL CLEANOUTS MUST BE PROVIDED WITH WALL COVERS AND MOUNTED IN UNOBTRUSIVE LOCATIONS WHILE MAINTAINING ACCESSIBILITY. SET ALL FLOOR CLEANOUTS FLUSH WITH FLOOR AREAS OR FINISHED GRADE. COORDINATE FINAL WALL AND FLOOR CLEANOUT LOCATIONS WITH ARCHITECTURAL PLANS TO AVOID BEING COVERED BY FURNITURE OR OTHER APPURTENANCES.

6. COORDINATE LOCATION OF PIPING AND DRAINS WITH ALL MECHANICAL AND ELECTRICAL EQUIPMENT. PIPING MUST NOT BE INSTALLED ABOVE ELECTRICAL, COMMUNICATIONS, OR DATA EQUIPMENT OR PANELS. COMPLY WITH ARCHITECTURAL PLANS FOR EXACT LOCATION OF PLUMBING FIXTURES, COMPLIANCE TO ADA CLEARANCES, AND FINISHES

7. PROVIDE REQUIRED WATER, WASTE, AND VENT PIPING, FITTINGS, AND INSULATION, AND MAKE FINAL CONNECTIONS TO EQUIPMENT. PLANS ARE SCHEMATIC AND DIAGRAMMATIC IN NATURE. PLANS DO NOT SHOW ALL REQUIRED BENDS, OFFSETS, VALVES, AND MISCELLANEOUS FITTINGS FOR A COMPLETE INSTALLATION. ALL PIPING, EQUIPMENT, AND CONNECTIONS MUST BE INSTALLED IN ACCORDANCE WITH SPECIFICATIONS, LOCAL CODES AND ORDINANCES, AND MANUFACTURER'S INSTRUCTIONS, WHICHEVER IS MORE STRINGENT.

8. WASTE PIPING MUST BE INSTALLED TO PROVIDE A MINIMUM SLOPE OF 1% (1/8" PER LINEAR FOOT). WASTE PIPING SMALLER THAN 3" MUST BE INSTALLED TO PROVIDE A MINIMUM SLOPE OF 2% (1/4" PER LINEAR FOOT).

9. DO NOT SCALE DRAWINGS. REFER TO ARCHITECTURAL DRAWINGS FOR EXACT DIMENSIONS, FIXTURE LOCATIONS, ROOM NAMES. AND NUMBERS.

10. PROVIDE EXTENSION OF EQUIPMENT DRAINS TO FLOOR DRAINS. FLOOR SINKS, AND OPEN SITE DRAINS.

11. WHERE POSSIBLE, INSTALL SHUT-OFF VALVES AND EQUIPMENT REQUIRING MAINTENANCE, CLEANING AND ADJUSTMENT ABOVE ACCESSIBLE CEILINGS OR IN SERVICE AREAS SUCH AS JANITOR'S CLOSETS. IN OTHER LOCATIONS, PROVIDE ACCESS PANELS IN INCONSPICUOUS LOCATIONS WITH FINISH TO MATCH ARCHITECTURAL. FIELD VERIFY FINAL LOCATIONS OF ACCESS PANELS WITH OTHER TRADES PRIOR TO INSTALLATION.

12. ALL HOSE BIBBS, WALL HYDRANTS, AND VALVES WITH THREADED HOSE CONNECTIONS MUST BE EQUIPPED WITH VACUUM BREAKER.

13. WHERE CONNECTING TO A UTILITY OR SERVICE, VERIFY LOCATION, SIZES, MATERIALS, FLUID BEING HANDLED, AND INVERT ELEVATIONS OF ALL EXISTING UTILITIES AND CONFIRM THAT NEW PIPES BEING ROUTED TO EXISTING UTILITIES CAN BE INSTALLED CONFORMING TO CODE AND AS SHOWN. NOTIFY CONTRACTING OFFICER OF ANY CONFLICTS OR DISCREPANCIES PRIOR TO PURCHASING ANY MATERIALS OR PERFORMING ANY WORK OR EXTENSION OF CONNECTION, WITH THE EXCEPTION OF EXCAVATION OR OTHER WORK TO PROVIDE ACCESS TO THE CONCEALED UTILITY.

14. PROVIDE INSULATION, PIPE IDENTIFICATION, AND OTHER REQUIREMENTS AS LISTED IN SPECIFICATIONS.

15. ALL PIPING ABOVE GRADE MUST BE SUPPORTED FROM THE BUILDING STRUCTURE AND MUST NOT REST ON CEILING TILES OR BE SUPPORTED FROM CEILING TILES.

16. WATER PIPING ROUTED ABOVE CEILINGS AND IN EXTERIOR WALLS MUST BE ROUTED ON HEATED SIDE (UNDERSIDE) OF CEILING INSULATION AND HEATED SIDE (INSIDE) OF WALL INSULATION.

17. SET TOPS OF ALL FLOOR DRAINS AND CLEANOUTS FLUSH WITH FINISHED FLOOR, UNLESS NOTED OTHERWISE.

18. LOCATE ALL SECTIONAL OR MAIN CONTROL VALVES WITHIN 1'-0" FROM ACCESS PANELS. CEILING TILES. OR OTHER POINT OF ACCESS.

19. PROVIDE WATER HAMMER ARRESTORS SIZED PER PLUMBING DRAINAGE INSTITUTE SPECIFICATIONS ON ALL DOMESTIC WATER LINES SERVING FLUSH VALVE FIXTURES. WASHING MACHINES SUPPLIES. PRV STATIONS. AND OTHER INSTALLATIONS WITH QUICK CLOSING VALVES.

20. COORDINATE ELECTRICAL CHARACTERISTICS AND REQUIREMENTS OF ALL PLUMBING EQUIPMENT WITH THE ELECTRICAL DRAWINGS AND THE ELECTRICAL CONTRACTOR. AND FURNISH EQUIPMENT WIRED FOR THE VOLTAGES SHOWN THEREIN.

21. ALL PLUMBING EQUIPMENT AND SYSTEMS MUST BE GUARANTEED FOR A MINIMUM PERIOD OF ONE YEAR AFTER CONTRACTING OFFICER'S REPRESENTATIVE'S FINAL ACCEPTANCE.

22. ALL PIPE PENETRATIONS OF FIRE AND/OR SMOKE-RATED ASSEMBLIES MUST BE FIRE-STOPPED AS REQUIRED TO RESTORE ASSEMBLY TO ORIGINAL INTEGRITY. FIRE BARRIER PRODUCTS MUST BE AS MANUFACTURED BY 3M COMPANY, CP25 CAULK. CS195 COMPOSITE PANEL, FS195 WRAP/STRIP, OR PSS 7900 SERIES SYSTEMS AS RECOMMENDED BY MANUFACTURER FOR PARTICULAR APPLICATION, OR EQUIVALENT SYSTEM AS APPROVED BY LOCAL CODE OFFICIALS.

23. LOCATE ALL WATER CLOSET FLUSH VALVE LEVERS ON THE APPROACH SIDE OF THE WATER CLOSET.

24. ALL GAS REGULATORS REQUIRING VENTS MUST BE VENTED TO THE EXTERIOR PER THE INTERNATIONAL GAS CODE REQUIREMENTS. VENT TERMINALS MUST BE A MINIMUM OF 10'-0" FROM ANY AIR INTAKE OR SOURCE OF IGNITION.

25. ALL VENTS THROUGH ROOF MUST BE LOCATED A MINIMUM OF 10'-0" FROM ANY OUTSIDE AIR INTAKE.

26. ALL COLD WATER, HOT WATER, AND DRAIN PIPING AT HANDICAPPED FIXTURES MUST BE INSULATED WITH HANDI-LAV GUARD MODELS 102 AND 105 (OR APPROVED EQUAL) INSULATION KITS.

27. NOT ALL PLUMBING ABBREVIATIONS SHOWN WILL BE USED FOR THIS PROJECT

**PLUMBING ABBREVIATIONS:** 

AAV AIR ADMITTANCE VALVE AC AIR COMPRESSOR A/C ABOVE CEILING AD AIR DRYER **ADA** AMERICANS WITH DISABILITIES ACT AFF ABOVE FINISHED FLOOR **AFG** ABOVE FINISHED GRADE ARCHITECTURE, ARCHITECTURAL BFP BACKFLOW PREVENTER

BELOW FLOOR B/G BELOW GRADE BUILDING  $\mathsf{BV}$ **BALL VALVE** CA COMPRESSED AIR

CD CONDENSATE DRAIN CONT CONTINUATION CO CLEANOUT CV **CHECK VALVE** CONTR CONTRACTOR

> CW COLD WATER (POTABLE / DOMESTIC) DEG. **DEGREES** DF DRINKING FOUNTAIN

DHWR DOMESTIC HOT WATER RETURN DN DOWN DSN DOWNSPOUT NOZZLE **DWGS** DRAWINGS (E), EXST. EXISTING

**ELECTRIC WATER COOLER ELECTRIC WATER HEATER** EWH **EMERGENCY EYEWASH EMEW** EMSH **EMERGENCY SHOWER** 

**ESEW EMERGENCY SHOWER / EYEWASH** FCO FLOOR CLEANOUT FD FLOOR DRAIN GC GENERAL CONTRACTOR

GPF **GALLONS PER FLUSH** GPH **GALLONS PER HOUR** GPM **GALLONS PER MINUTE** GV **GATE VALVE** GWH **GAS WATER HEATER** 

HB **HOSE BIBB** H/C **HANDICAP** HOT WATER (POTABLE / DOMESTIC) I.E. INVERT ELEVATION

**IBC** INTERNATIONAL BUILDING CODE INTERNATIONAL FUEL GAS CODE IMB ICE MAKER BOX **IPC** INTERNATIONAL PLUMBING CODE

IW INDIRECT WASTE **KILOWATT** LAUNDRY LIQUID PETROLEUM LAVATORY

MFG MANUFACTURER MS MOP SINK NON-FREEZE ROOF HYDRANT **NFRH** 

NON-FREEZE WALL HYDRANT NATURAL GAS NOT IN CONTRACT ORD OVERFLOW ROOF DRAIN

OST OVERFLOW STORM DRAINAGE P, PLBG PLUMBING PDI PLUMBING DRAINAGE INSTITUTE

**PRV** PRESSURE REDUCING / REGULATING VALVE PSI POUNDS PER SQUARE INCH RD**ROOF DRAIN** RLRAIN LEADER

**RPZ** REDUCED PRESSURE ZONE SAN. S SANITARY PIPING SANITARY SEWER

SH SHOWER SK SOV SHUT-OFF VALVE ST STORM DRAINAGE

STR **STRAINER** SS STAINLESS STEEL TD TRENCH DRAIN

THERMOSTATIC MIXING VALVE T&P TEMPERATURE AND PRESSURE RELIEF VALVE TP TRAP PRIMER

**TYPICAL URINAL** UNDERGROUND U/G U/SAN **UNDERGROUND SANITARY** VENT PIPING

**VENT THROUGH ROOF** WASTE PIPING WB **CLOTHES WASHER OUTLET BOX** WC WATER CLOSET

WCO WALL CLEANOUT WH WATER HEATER WATER HAMMER ARRESTOR

W/O WITHOUT WITH

YARD CLEANOUT

PLUMBING LEGEND

DIRECTION OF FLOW 

─────○ PIPE TURNED UP

────────── RISE OR DROP BRANCH BOTTOM CONNECTION

BRANCH TOP CONNECTION

TEE OUTLET UP

TEE OUTLET DOWN

CAP ON END OF PIPE

PIPING BELOW FLOOR OR GRADE, SINGLE PIPING BELOW FLOOR OR GRADE, DOUBLE

LINE SANITARY WASTE PIPING - ABOVE FLOOR OR GRADE, SINGLE LINE

CONTINUATION OF PIPE

SANITARY WASTE PIPING - ABOVE FLOOR OR GRADE, DOUBLE LINE — — — — VENT PIPING. SINGLE LINE

VENT PIPING, DOUBLE LINE POTABLE / DOMESTIC COLD WATER PIPING, SINGLE LINE

POTABLE / DOMESTIC COLD WATER PIPING, DOUBLE LINE POTABLE / DOMESTIC HOT WATER SUPPLY PIPING, SINGLE LINE

POTABLE / DOMESTIC HOT WATER SUPPLY PIPING, DOUBLE LINE POTABLE / DOMESTIC HOT WATER RETURN

> PIPING, SINGLE LINE POTABLE / DOMESTIC HOT WATER RETURN PIPING, DOUBLE LINE

THERMOMETER

TEMPERATURE & PRESSURE RELIEF VALVE

FLOW MEASURING / BALANCING / SHUT-OFF VALVE BALL VALVE

CHECK VALVE — GATE VALVE

STRAINER

**HOSE BIBB** 


PLAN | ELEV


igcup - FLOOR DRAIN TRAP PRIMER

⊗ FCO FLOOR CLEANOUT

Ĺ MCO MCO ← WALL CLEANOUT WATER HAMMER ARRESTOR

SANITARY RISER DIAGRAM \ # / RISER DIAGRAM NUMBER DOMESTIC WATER RISER DIAGRAM

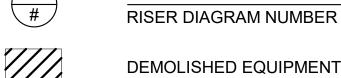

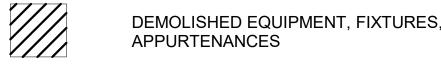

DISCONNECT FROM EXISTING

DEMOLISHED PIPING **CONNECT TO EXISTING**  3500 Parkway Lane Suite 500 Peachtree Corners

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**CLIENT INFORMATION** U.S. FISH & WILDLIF SERVICE

US Fish & Wildlife Service

**PROJECT NAME** 

Cameron Prairie National Wildlife Refuge Bunkhouse

LA-27 Bell City, LA 70630

**DRAWING ISSUE** 

DESIGNED BY: S. THOMAS

**SHEET TITLE** 


DRAWN BY: S. THOMAS CHECKED BY: J. LEDYARD SUBMITTED BY: C. CUSICK DATE: 02/12/2024 PROJECT #: 1220834

PLUMBING **GENERAL NOTES** ABBREVIATIONS,

AND LEGENDS

**SHEET NUMBER** 

P-001

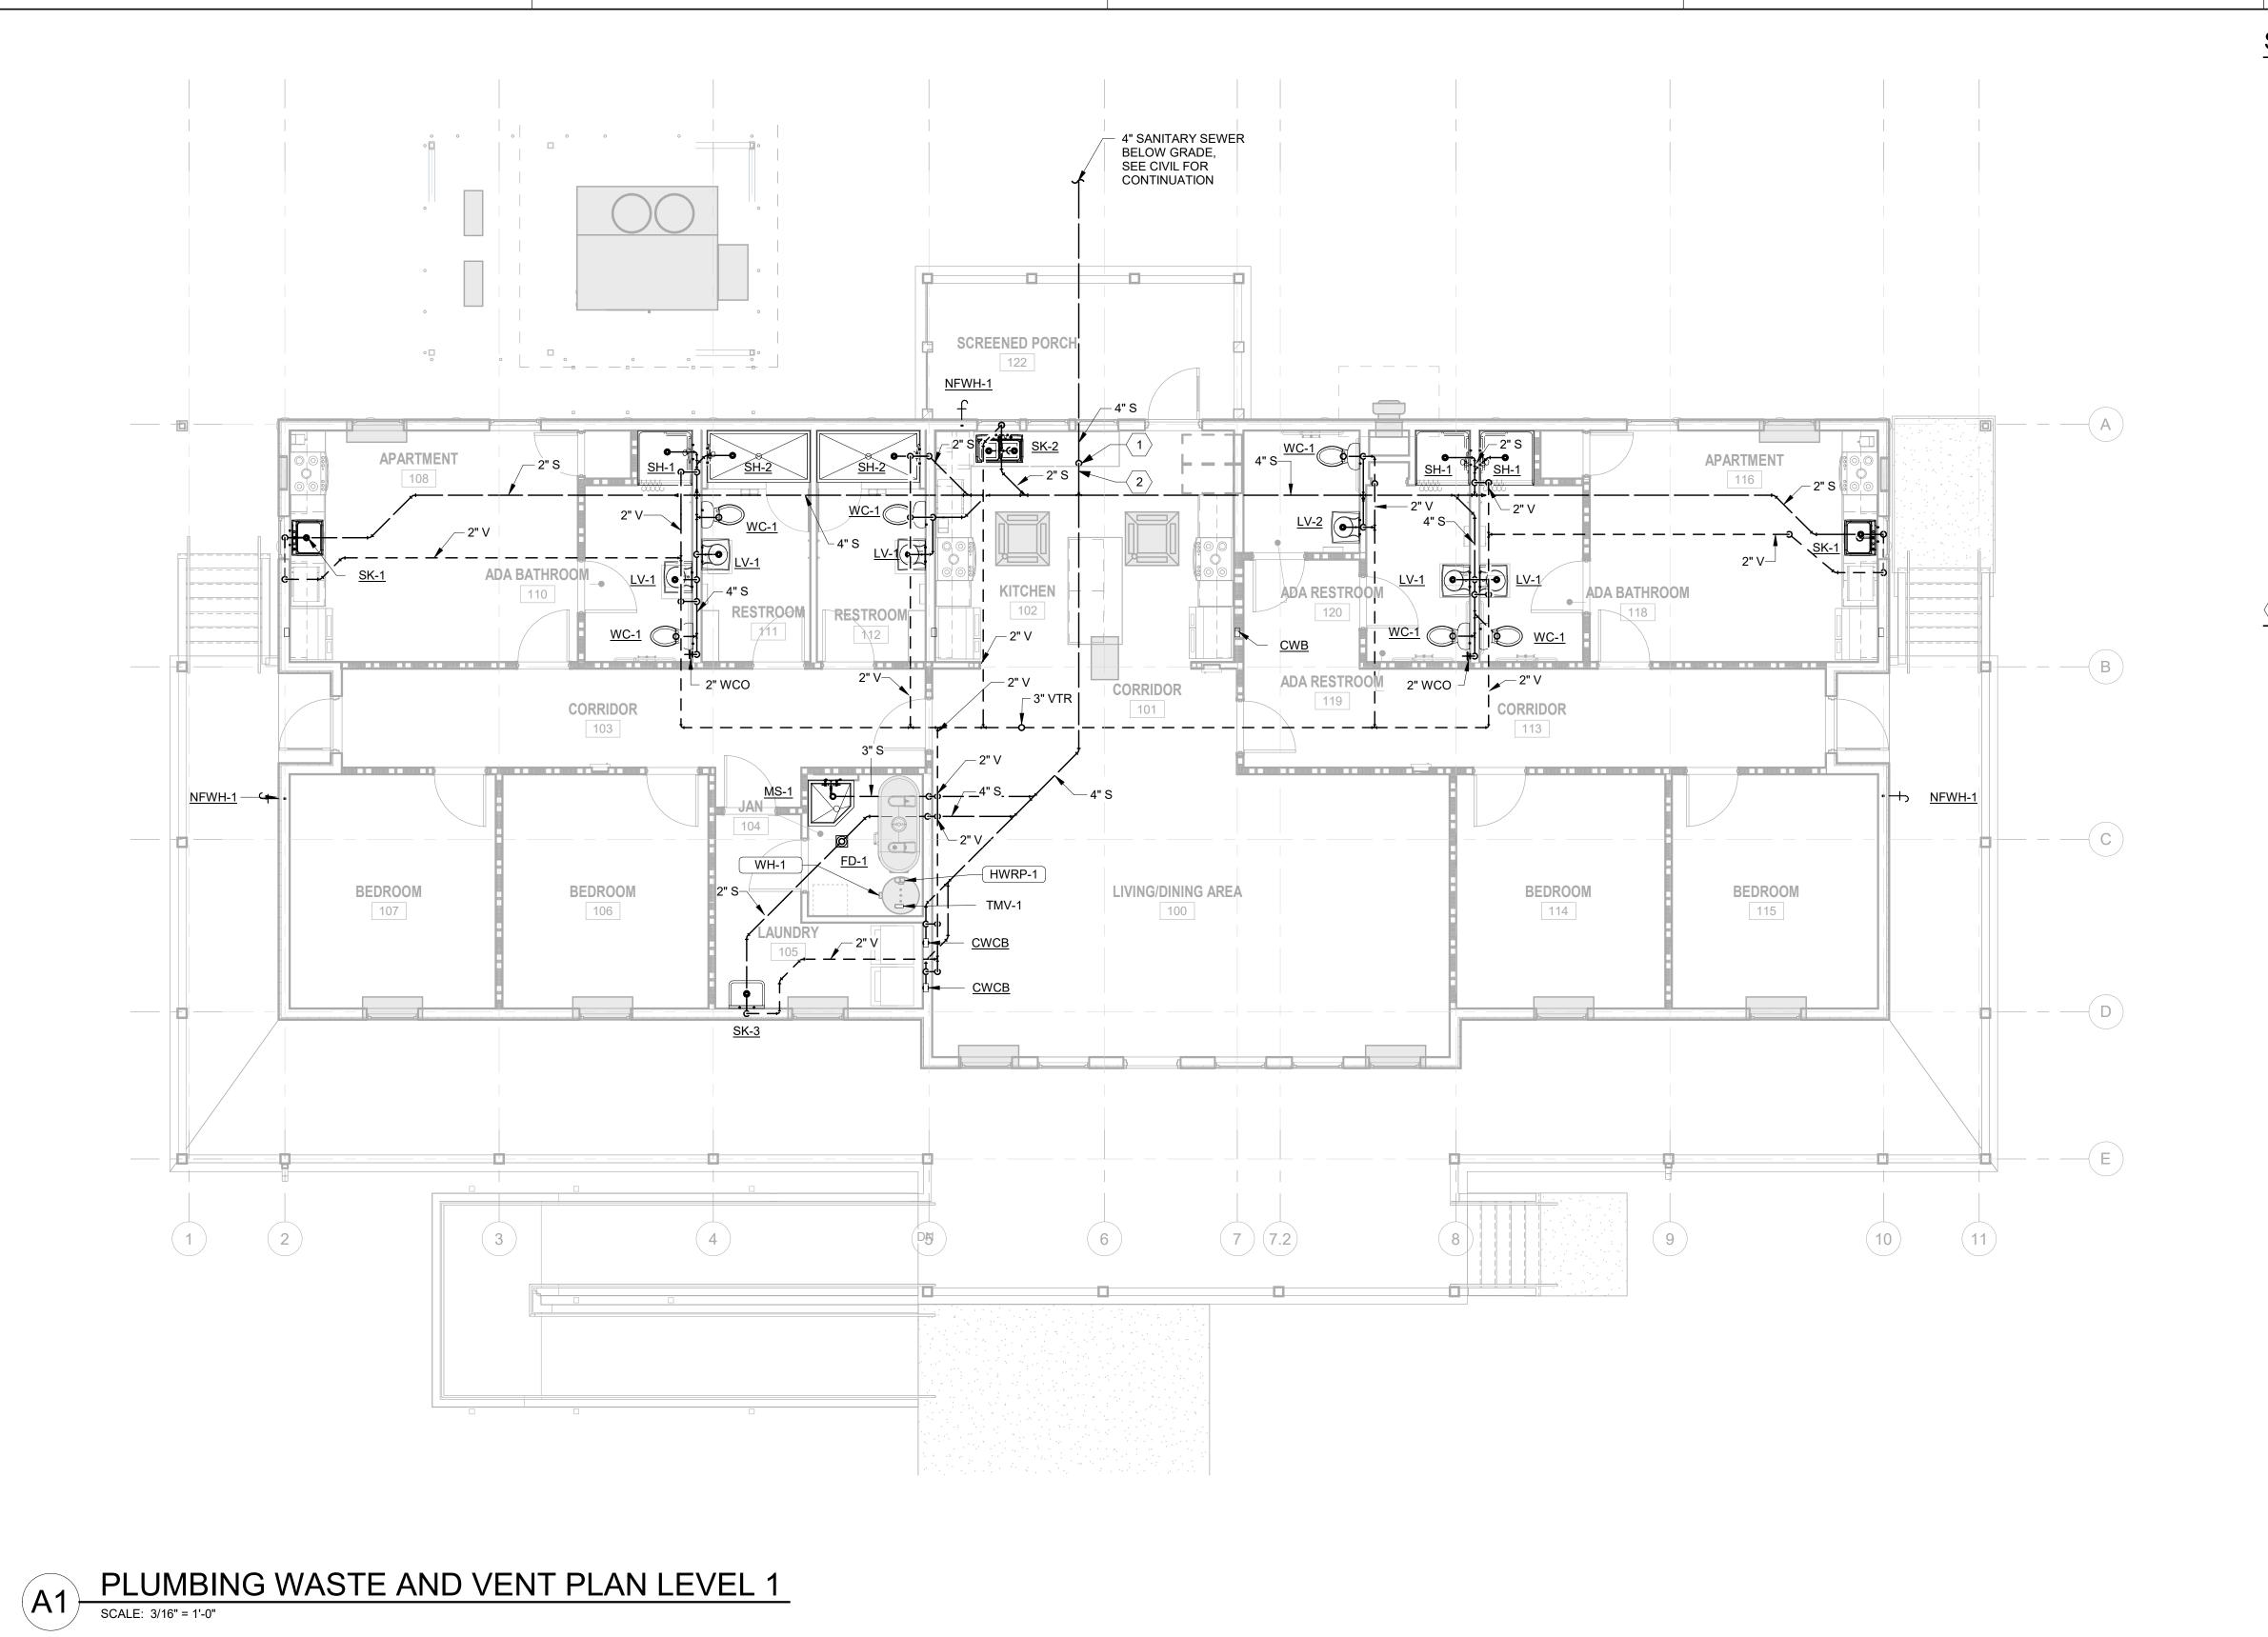

#### SHEET NOTES

1. REFER TO P-001 FOR PLUMBING GENERAL NOTES, ABBREVIATIONS, AND LEGENDS.

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⟨#⟩ KEYNOTES

1 DROP 4" SANITARY SEWER BELOW GRADE.

2 SANITARY SEWER PIPING UPSTREAM OF THIS LOCATION SHALL BE ROUTED BELOW SLAB, ABOVE GRADE. SUPPORT PIPING FROM SLAB.

**CLIENT INFORMATION** 



US Fish & Wildlife Service

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LA-27 Bell City, LA 70630

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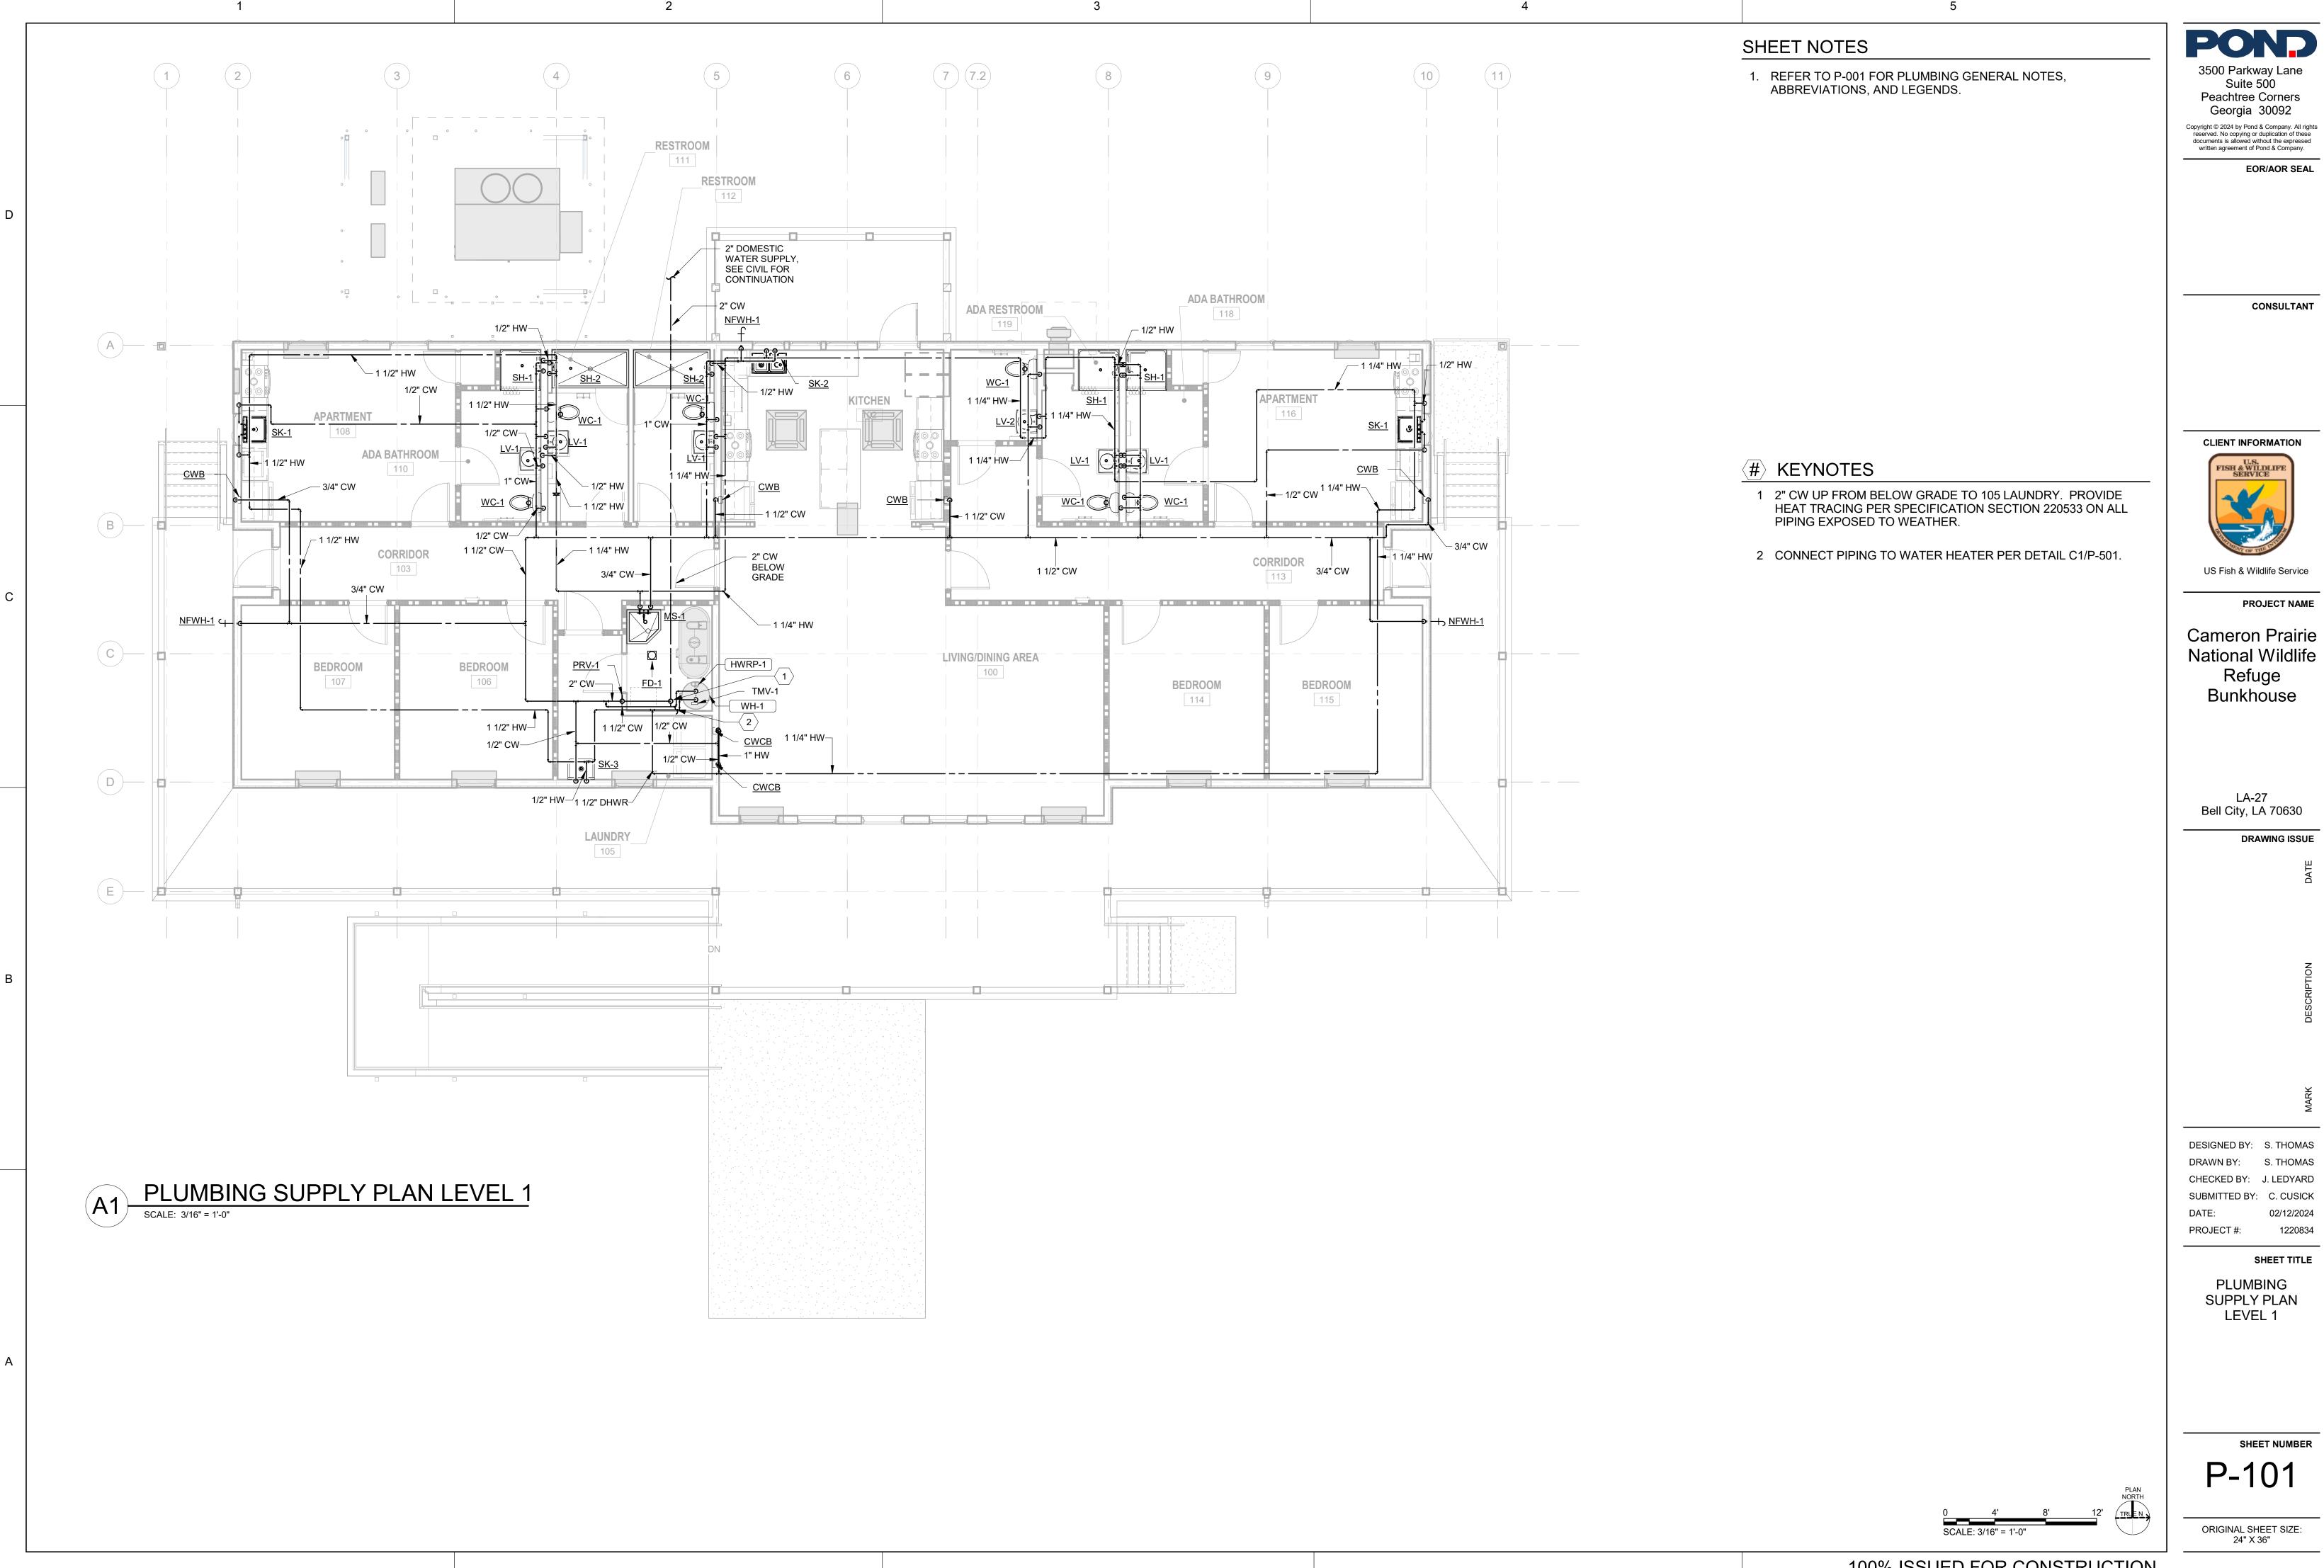
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SHEET TITLE

PLUMBING WASTE AND VENT PLAN LEVEL 1

SHEET NUMBER

PW101




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LA-27 Bell City, LA 70630

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CHECKED BY: J. LEDYARD SUBMITTED BY: C. CUSICK 02/12/2024

SHEET TITLE

PLUMBING SUPPLY PLAN LEVEL 1

SHEET NUMBER

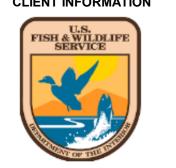P-101

ORIGINAL SHEET SIZE: 24" X 36"

100% ISSUED FOR CONSTRUCTION

SPOUT BRACE

AND PAILHOOK

30" LONG HOSE

3" Ø P-TRAP

1-1/2" CW SUPPLY

<u>EWH</u>

A1 ELECTRIC TANK WATER HEATER DETAIL

HWRP-1

3/4" CW

AQUASTAT

3/4" DHWR BYPASS TO TMV, COMPLY WITH TMV MFG'S

PIPING DIAGRAMS AND

PROVIDE VACUUM RELIEF

VALVE IF WATER HEATER IS NOT EQUIPED WITH A CODE COMPLIANT ANTI-SIPHON

INSTRUCTIONS

DEVICE

- P&T RELIEF VALVE

3/4" (MINIMUM) DRAÌN VALVE

DRAIN PAN, PIPE DRAIN

LINE TO FLOOR DRAIN

FINISHED FLOOR

PIPE DISCHARGE FULL SIZE TO FLOOR DRAIN

BALANCING VALVE

- CHECK VALVE (TYP.)

SPOUT WITH HOSE END

SERVICE FAUCET WITH

C1 MOP SINK DETAIL

N.T.S

1-1/2" 120°F HOT WATER —

MIXING VALVE (TMV)

THERMOMETER (TYP)

**EXPANSION TANK** 

1" 140°F HOT WATER

BALL VALVE (TYP.)

THERMOSTATIC


MIN. 2 GALLON THERMAL


DIELECTRIC UNION (TYP.) -

4" CONCRETE PAD

VACCUUM BREAKER


HOSE BRACKET

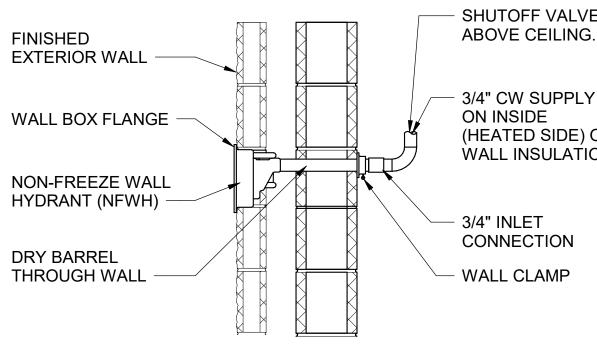

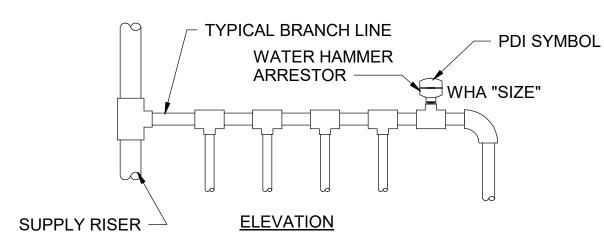


WATER HAMMER ARRESTOR SCHEDULE										
PDI SYMBOL	A B C D E F									
FIXTURE UNIT RATING	1-11	12-32	33-60	61-113	114-154	155-330				


- 2. ONE WATER HAMMER ARRESTOR PER 20' LINE, AND ANOTHER FOR BRANCHES OVER
- 20' IN LENGTH.
- OR GREATER THAN THE DEMAND OF THE BRANCHES.

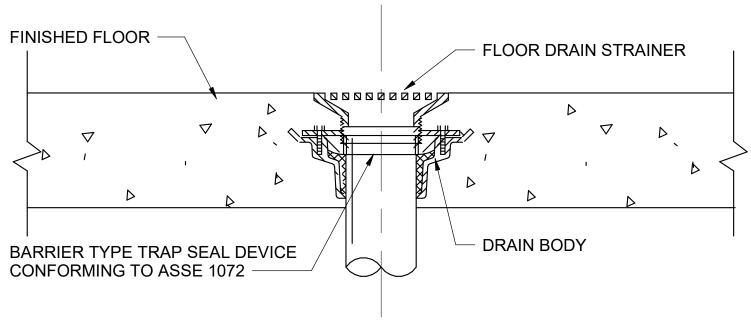

## C3 TRAP GUARD DETAIL N.T.S

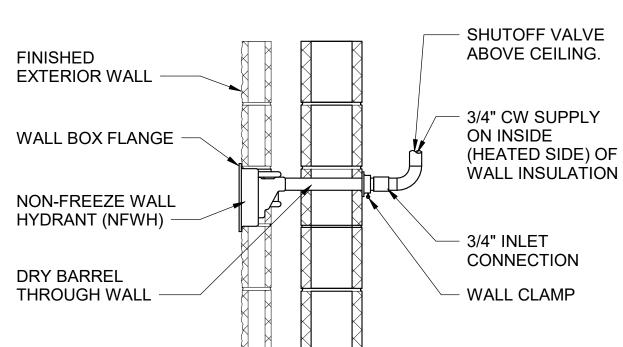



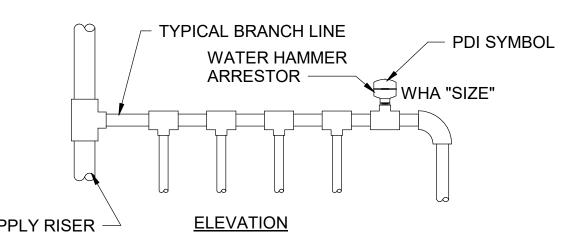

WATER HAMMER ARRESTOR SCHEDULE										
PDI SYMBOL	A B C D E F									
FIXTURE UNIT RATING	1-11	12-32	33-60	61-113	114-154	155-330				

- NOTES:
  1. INSTALL WATER HAMMER ARRESTORS AT THE END OF BRANCH LINE BETWEEN THE LAST TWO FIXTURES SERVED.
- 3. THE SUM OF FIXTURE UNIT RATING OF UNITS OVER 20' IN LENGTH MUST BE EQUAL TO



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LA-27 Bell City, LA 70630

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DESIGNED BY: S. THOMAS DRAWN BY: S. THOMAS CHECKED BY: J. LEDYARD SUBMITTED BY: C. CUSICK 02/12/2024 PROJECT #: 1220834

SHEET TITLE

PLUMBING **DETAILS** 

SHEET NUMBER

P-501

							PLUMB	ING FIXT	URE SCHEDULE				
		COLD	HOT	WASTE					BASIS OF DESIGN				
ID	FIXTURE TYPE	WATER PIPE SIZE	WATER PIPE SIZE		PIPE SIZE	FLOW RESTRICTION	MANUFACTURER	MODEL	DESCRIPTION				
CWB	COLD WATER CONNECTION BOX	1/2"					OATEY		RECESSED WALL BOX WITH ¼ TURN BRASS BALL VALVE AND WATER HAMMER ARRESTOR. MAKE FINAL CONNECTION TO ICE MAKER WITH STAINLESS STEEL BRAIDED HOSE.				
CWCB	CLOTHES WASHER CONNECTION BOX	1"	1"	2"	1-1/2"		OATEY		RECESSED WALL BOX WITH ¼ TURN WATER BALL VALVES, WATER HAMMER ARRESTORS, AND 2" DRAIN CONNECTION. MAKE FINAL CONNECTIONS TO WASHING MACHINE.				
FD-1	FLOOR DRAIN			4"	2"		ZURN		CAST IRON FLOOR DRAIN WITH HEAVY DUTY 9" CAST IRON GRATE, CAST IRON SEDIMENT BUCKET, MEMBRANE CLAMP AND BARRIER TYPE TRAP SEAL DEVICE CONFORMING TO ASSE 1072.				
LV-1	LAVATORY, WALL-MOUNT, ACCESSIBLE	1/2"	1/2"	2"	1-1/2"	0.5 GPM	NAMEEK'S		ADA COMPLIANT, VITREOUS CHINA, WHITE, DELTA RINNA 35874LF DOUBLE LEVER MANUAL FAUCET WITH 0.5 GPM AERATOR, GRID DRAIN AND ZURN #1231 SUPPORT.				
LV-2	LAVATORY, WALL-MOUNT, ACCESSIBLE	1/2"	1/2"	2"	1-1/2"	0.5 GPM	KOHLER		ADA COMPLIANT, VITREOUS CHINA, WHITE, DELTA #500-HGM-DST SINGLE LEVER MANUAL FAUCET WITH 0.5 GPM AERATOR, GRID DRAIN AND ZURN #1231 SUPPORT.				
MS-1	MOP SINK	3/4"	3/4"	3"	2"		FIAT		FLOOR-MOUNT TERRAZZO BASIN WITH FIAT #830-AA FAUCET, #832AA HOSE AND BRACKET, #1239 BUMPER GUARD, AND #889CC MOP HANGER.				
NFWH-1	EXTERIOR NON-FREEZE WALL HYDRANT	3/4"					WOODFORD		NON-FREEZE TYPE WALL HYDRANT WITH INTEGRAL VACUUM BREAKER AND LOOSE KEY SOCKET ON THE OUTSIDE OF THE WALL. RECESSED WALL BOX WITH LOCKING COVER. PROVIDE SHUTOFF VALVE IN ACCESSIBLE LOCATION ON INSIDE OF WALL.				
SH-1	SHOWER STALL, ACCESSIBLE	1/2"	1/2"	2"	1-1/2"	1.5 GPM	AQUATIC		SHOWER STALL WITH CENTER DRAIN, GRAB BARS, FOLD UP SEAT AND CURTAIN ROD WITH CURTAIN. ZURN #Z7300-SS-MT-HW-H9 PRESSURE BALANCING SHOWER VALVE AND 1.5 GPM HAND HELD SHOWER HEAD W/ SLIDE BAR.				
SH-2	SHOWER, ACCESSIBLE	1/2"	1/2"	2"	1-1/2"	1.5 GPM	ZURN		PRESSURE BALANCING SHOWER VALVE, 1.5 GPM HAND HELD SHOWER WITH SLIDE BAR. PROVIDE 2" FLOOR DRAIN (SAME MODEL AS FD-1).				
SK-1	SINK, SINGLE COMPARTMENT	1/2"	1/2"	2"	2"	1.5 GPM	ELKAY		ADA COMPLIANT 20 GAGE STAINLESS STEEL SELF RIMMING SINK WITH DELTA #400-DST FAUCET WITH SPRAY & #RP19754 LOW FLOW AERATOR (1.5 GPM), ELKAY #LK35 DRAIN FITTING.				
SK-2	BREAK ROOM SINK, DOUBLE COMPARTMENT	1/2"	1/2"	2"	2"	1.5 GPM	ELKAY		ADA COMPLIANT 20 GAGE STAINLESS STEEL SELF RIMMING SINK WITH DELTA #400-DST FAUCET WITH SPRAY & #RP19754 LOW FLOW AERATOR (1.5 GPM), (2) ELKAY #LK35 DRAIN FITTINGS.				
SK-3	LAUNDRY ROOM SINK	1/2"	1/2"	3"	2"	1.5 GPM	ELKAY		WALL-HUNG, 14-GAUGE 304 STAINLESS STEEL SINK WITH STRAINER, P-TRAP, AND FAUCET INCLUDED, TAILPIECES, SUPPLIES, AND STOPS.				
WC-1	WATER CLOSET, FLOOR-MOUNT, FLUSH TANK, ACCESSIBLE	1/2"		4"	2"	1.28 GPF	KOHLER		ELONGATED FLOOR MOUNTED TANK TYPE WATER CLOSET, WITH CHURCH 295CT ELONGATED OPEN FRONT SEAT. PROVIDE A 1/4" BRASS BALL VALVE AT WALL CONNECTION. INSTALL AT ADA COMPLIANT HEIGHT.				

ADDITIONAL NOTES:
1. EXPOSED PIPING AT PLUMBING FIXTURES MUST BE CHROME-PLATED WITH CHROME-PLATED ESCUTCHEONS AT WALL PENETRATIONS.

2. PROVIDE CHROME-PLATED BRASS P-TRAP AND SUPPLIES WITH STOP VALVES AT SINKS, LAVATORIES, AND ELECTRIC WATER COOLERS.

3. PROVIDE INSULATION FOR P-TRAP AND SUPPLIES AT HANDICAP ACCESSIBLE SINKS AND LAVATORIES.

4. CONNECTION SIZES SHOWN ARE MINIMUM SIZES.

5. REFER TO FLOOR PLANS FOR COMMON VENT SIZES.

	ELECTRIC WATER HEATER SCHEDULE												
	ELLOTTIO WATER TILATER OUTEDOLL												
	LOCATION BASIS OF DESIGN					HEATING DATA			ELECTRICAL DATA				
				HEATING	STORA	GE	MAX	UNIT					
						CAPACITY	RECOVERY	′ VOL	TEMP	WEIGHT		NO. OF	
ID	NAME	NO.	MANUFACTURER	MODEL NO.	TYPE	(KW)	(GPH)	(GAL)	RISE (°F)	(LBS)	VOLTAGE	POLES	REMARKS
WH-1	JAN	104	AOSMITH	DRE-120-24	STORAGE	24.0	123.0	120.0	90.0	390	208	3	PROVIDE ASSE 1017 COMPLIANT MIXING VALVE TMV-1.

	DOMESTIC CIRCULATING PUMP SCHEDULE													
	LOCATION BASIS OF DESIGN					DESIGN				UNIT	ELECTRIC	AL DATA		
							FLOW	HEAD	POWER		WEIGHT		NO. OF	
ID	NAME	NO.	MANUFACTURER	MODEL NO.	SERVICE	TYPE	(GPM)	(FT.)	(HP)	RPM	(LBS)	VOLTAGE	POLES	REMARKS
HWRP-1	LAUNDRY	105	TACO	006-B4	DOMESTIC HOT	INLINE	3.0	7.0	0.025	3250	6	120	1	
					WATER RETURN	CIRCULATOR								

PLUMBING SPECIALTIES SCHEDULE									
	LOCATION		BASIS OF DE	ESIGN					
ID	NAME	NO.	MANUFACTURER	MODEL	DESCRIPTION	REMARKS			
PRV-1	LAUNDRY	105	WATTS	LF223	2" PRESSURE REDUCING VALVE	LEAD-FREE. SEE DETAIL A1/P-501.			
TMV-1	LAUNDRY	105	POWERS	LFLM490	THERMOSTATIC MIXING VALVE	LEAD-FREE. NOT MORE THAN 1 GPM MINIMUM FLOW RATE. NOT MORE THAN 10 PSI PRESSURE DROP AT 11 GPM. THERMOMETER AT OUTLET. SEE DETAIL A1/P-501.			

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US Fish & Wildlife Service

**PROJECT NAME** 

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Bell City, LA 70630

**DRAWING ISSUE** 

DESIGNED BY: S. THOMAS DRAWN BY: S. THOMAS CHECKED BY: J. LEDYARD SUBMITTED BY: C. CUSICK 02/12/2024 PROJECT #: 1220834

SHEET TITLE

PLUMBING SCHEDULES

SHEET NUMBER

 REFER TO P-001 FOR PLUMBING GENERAL NOTES, ABBREVIATIONS, AND LEGENDS. 3500 Parkway Lane Suite 500 Peachtree Corners

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U.S.
FISH & WILDLIFE
SERVICE

US Fish & Wildlife Service

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LA-27 Bell City, LA 70630

DRAWING ISSUE

7


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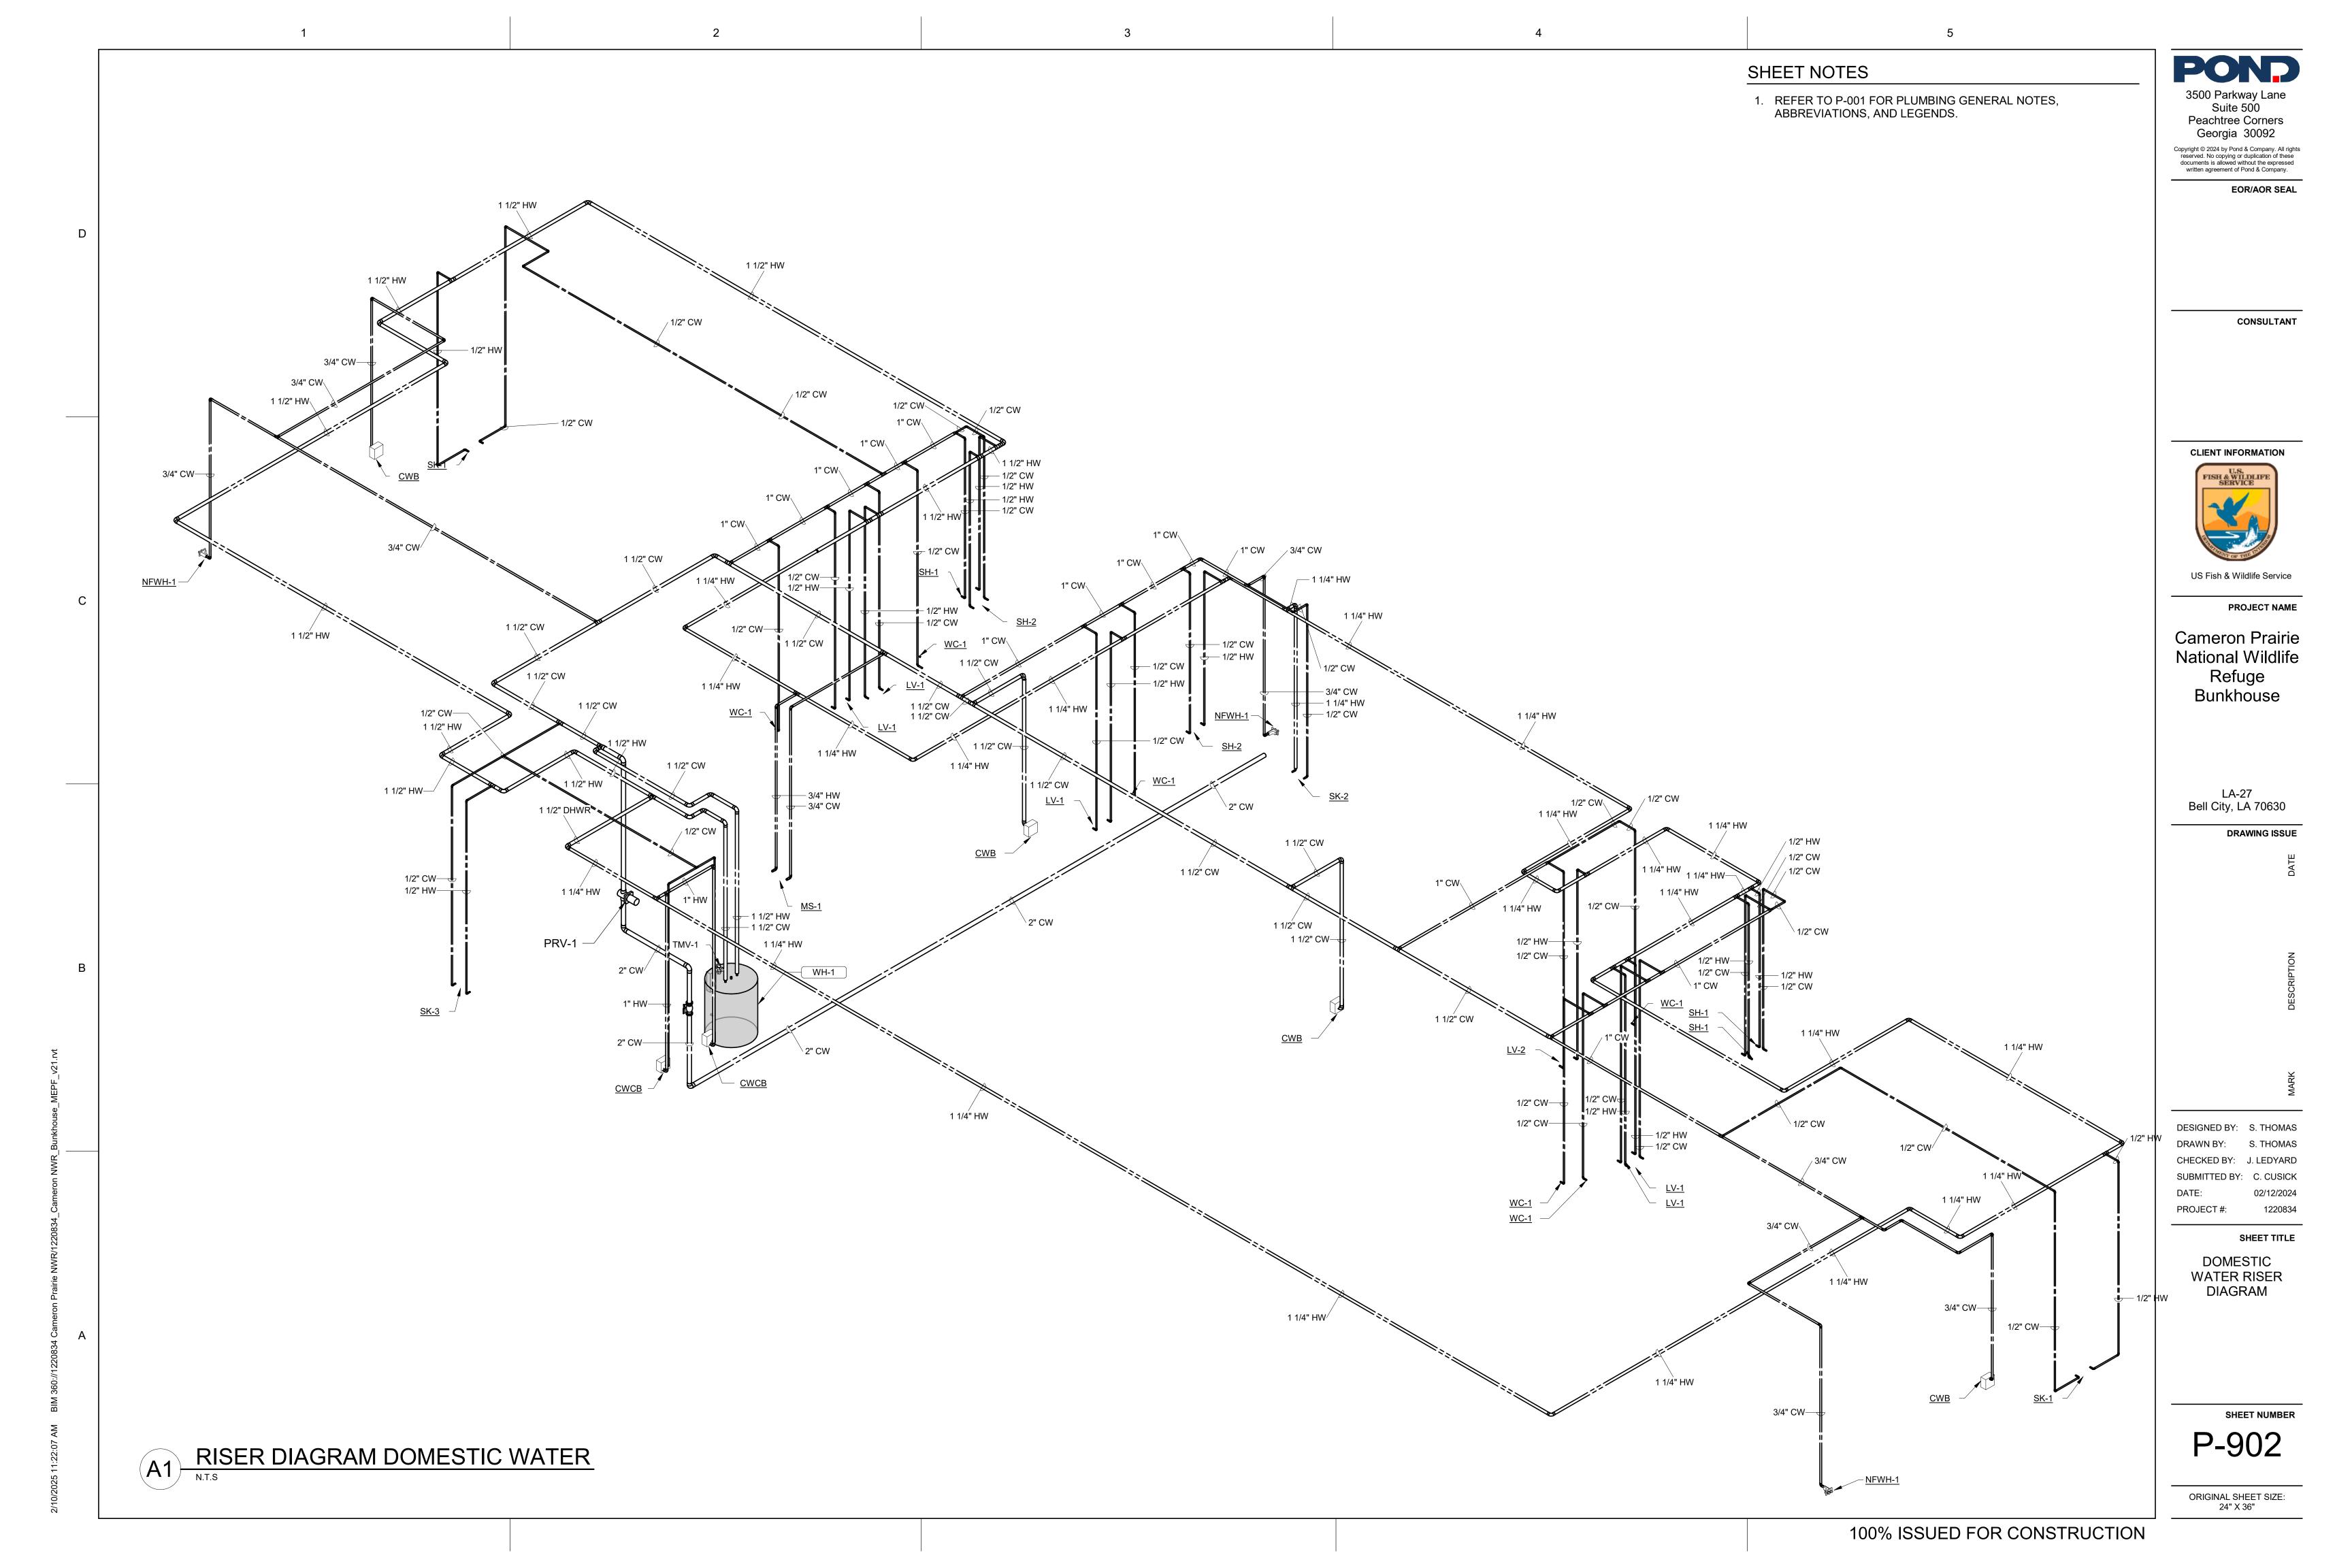
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DRAWN BY: S. THOMAS
CHECKED BY: J. LEDYARD
SUBMITTED BY: C. CUSICK
DATE: 02/12/2024
PROJECT #: 1220834

SHEET TITLE

WASTE AND VENT RISER DIAGRAM

P-901



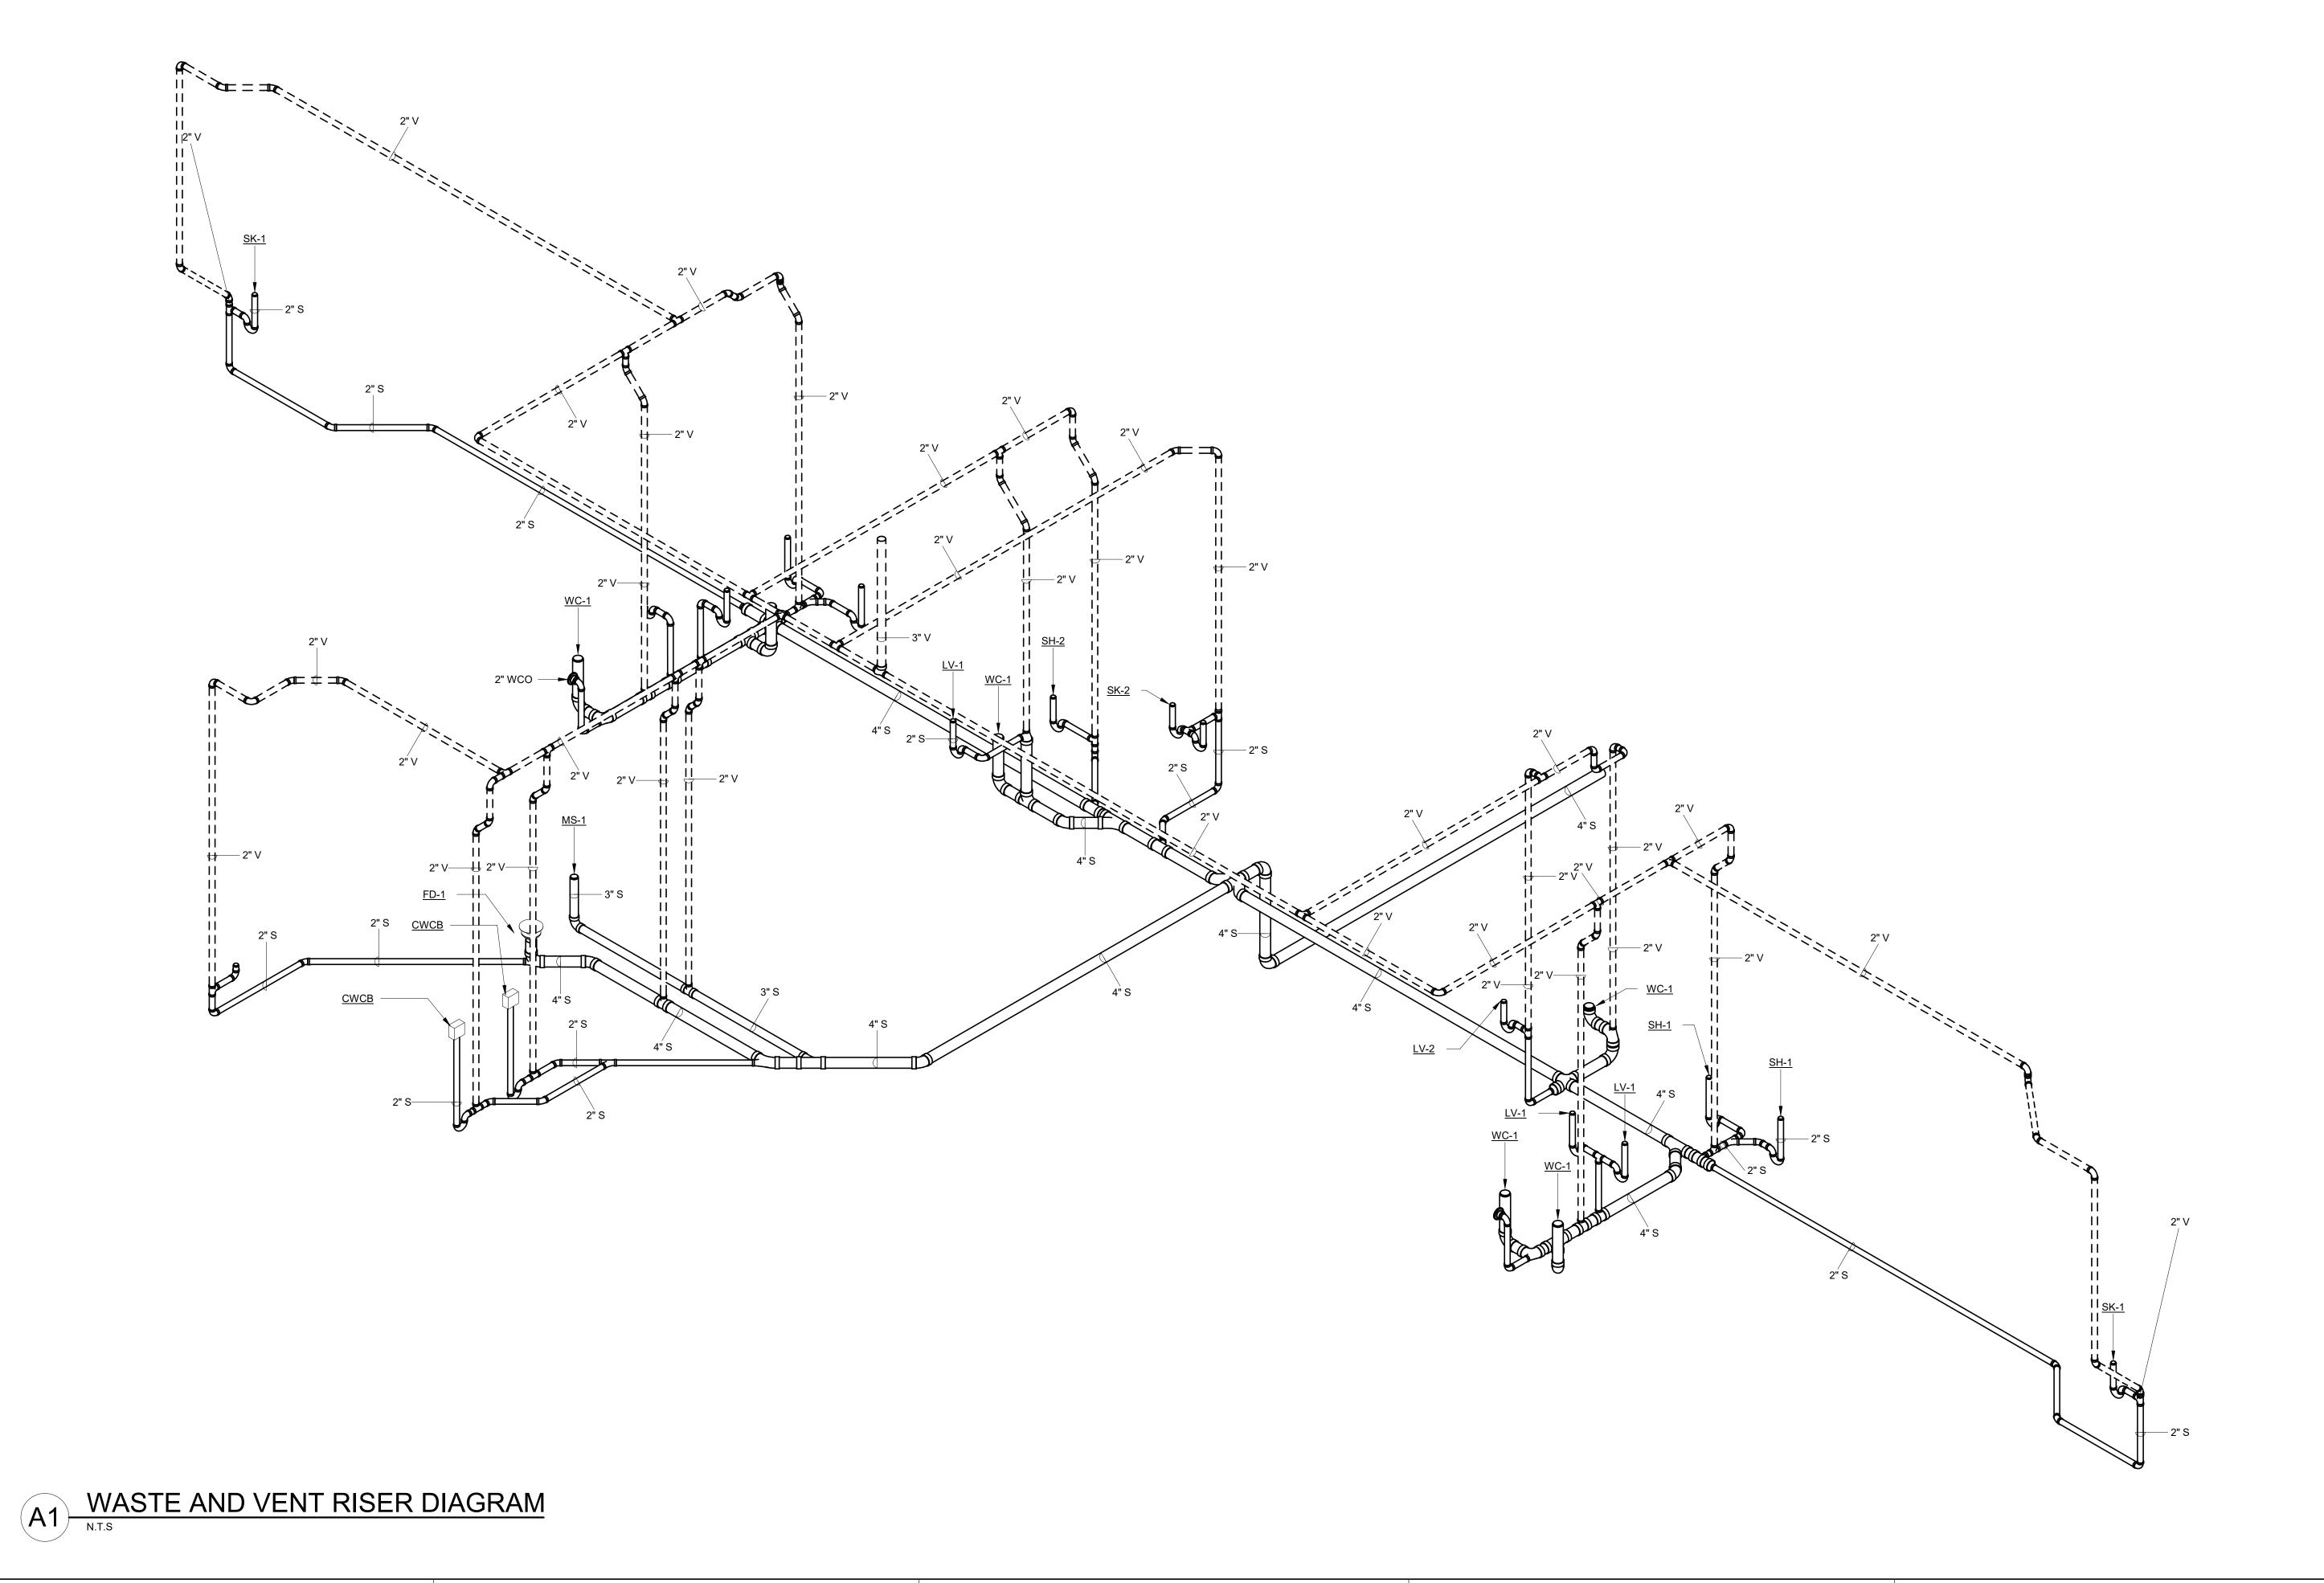

- EXISTING EQUIPMENT IS SHOWN WITH THIN LINEWORK. 2. DEMOLISHED EQUIPMENT IS SHOWN WITH BOLD LINEWORK, DASHED, AND HATCHED.
- 3. NEW OR RELOCATED EQUIPMENT IS SHOWN WITH BOLD LINEWORK.
- 4. BELOW IS AN EXAMPLE OF EACH:

EXISTING EQUIPMENT OR EQUIPMENT BY OTHERS

NEW OR RELOCATED EQUIPMENT

**EQUIPMENT TO BE DEMOLISHED** 

CODE REFERENCES	
CODE REFERENCE	EDITION
INTERNATIONAL BUILDING CODE	2021
INTERNATIONAL ENERGY CONSERVATION CODE	2009
INTERNATIONAL FIRE CODE	2021
INTERNATIONAL FUEL GAS CODE	2021
INTERNATIONAL MECHANICAL CODE	2021
INTERNATIONAL PLUMBING CODE	2021

INTERNATIONAL PLUMBING CODE	2021					
HVAC DESIGN CRITERIA						
CATEGORY	DATA VALU					
CLIMATIC DESIGN LOCATION:	LA					
LATITUDE:						
LONGITUDE:	93.2 W					
ELEVATION:	19 FT.					
STANDARD DESIGN CONDITIONS						
WINTER DESIGN DRY BULB (99.0%):	33.7 °F					
SUMMER DESIGN DRY BULB (1.0%):	93.2 °F					
SUMMER DESIGN WET BULB (1.0%):	77.8 °F					
DEHUMIDIFICATION DESIGN CONDITIONS						

#### MEAN COINCIDENT DRY BULB (1.0%): 83.6 °F

HUMIDITY RATIO (1.0%): 148.6

DEWPOINT (1.0%): 78.6 °F

INDOOR DESIGN CONDITIONS									
	C	COOLING	HEATING						
	OCC.	UNOCC.		OCC.	UNOCC				
	DRY	DRY	OCC.	DRY	DRY				
	BULB	BULB	DP	BULB	BULB				
SPACE CATEGORY	(°F)	(°F)	(°F)	(°F)	(°F)				
ADMINISTRATION SPACES	78	85	57.9	68	55				
COMM ROOMS	75	75	62.5	40	40				
ENTRANCE VESTIBULES	N/A	N/A	N/A	55	40				
MECHANICAL ROOMS	AMB. +	AMB. +	N/A	55	55				
	[10°F]	[10°F]							
STORAGE	78	85	57.9	68	55				

#### **MECHANICAL GENERAL NOTES:**

- INSTALLATION OF HVAC WORK MUST BE COORDINATED WITH OTHER TRADES BEFORE ANY INSTALLATION IS MADE. PLANS ARE 27. UNLESS NOTED OTHERWISE, ACCESS MUST BE PROVIDED AT EACH INSTANCE OF THE FOLLOWING: FIRE DAMPERS. DUCT DIAGRAMMATIC IN NATURE. PROVIDE ALL TRANSITIONS. ELBOWS. ETC. REQUIRED TO AVOID CONFLICTS WITH OTHER TRADES AND BUILDING ELEMENTS. EQUIPMENT, PIPING, OR DUCTWORK INTERFERING WITH OTHER TRADES MUST BE RELOCATED AS REQUIRED AT NO ADDITIONAL COST TO THE OWNER. DO NOT SCALE THE DRAWINGS
- 2. THE MECHANICAL EQUIPMENT AND INSTALLATION MUST CONFORM TO THE CODE REFERENCES TABLE SHOWN HEREIN.
- 3. AT THE START OF CONSTRUCTION, PREPARE TYPED LISTS OF EQUIPMENT THAT ARE SUPPLIED REQUIRING ELECTRICAL WORK, AND SEND LISTS TO THE ELECTRICAL CONTRACTOR FOR REVIEW AND COORDINATION
- 4. WRITTEN DIMENSIONS ON DRAWINGS HAVE PRECEDENCE OVER SCALED DIMENSIONS
- 5. "PROVIDE" IS AN INCLUSIVE TERM USED TO DESCRIBE ASPECTS OF THE WORK THAT MUST BE ACCOMPLISHED AND IS HEREBY DEFINED TO REQUIRE TO STORE, FURNISH, INSTALL, MOUNT, CONNECT, CONTROL AND POWER EQUIPMENT INDICATED, AS WELL AS ALL APPURTENANCES REQUIRED TO MAKE SYSTEMS OPERATE AS INDICATED WITHIN THESE DRAWINGS AND SPECIFICATIONS AND TO FULFILL THE SCOPE OF WORK.
- 6. COORDINATE MECHANICAL AND ELECTRICAL WORK SUCH THAT MECHANICAL PIPING, DUCTWORK AND EQUIPMENT IS NOT LOCATED OVER OR ABOVE ANY ELECTRICAL. COMMUNICATIONS. OR DATA EQUIPMENT.
- 7. ALL EQUIPMENT MUST BE INSTALLED IN ACCORDANCE WITH MANUFACTURER'S APPROVED PUBLISHED LITERATURE (INCLUDING SERVICE CLEARANCE), AND INTERNATIONAL BUILDING CODE / INTERNATIONAL MECHANICAL CODE, WHICHEVER IS MORE STRINGENT.
- 8. INSTALLATION OF EQUIPMENT MUST PERMIT ACCESSIBILITY FOR SERVICE AND/OR REPLACEMENT WITHOUT NECESSITATING REMOVAL OR MODIFICATION TO OTHER PIPING, WIRING, OR EQUIPMENT.
- 9. CEILING-MOUNTED EQUIPMENT MUST BE INSTALLED IN SUCH A MANNER THAT LIGHTS, PIPING, DUCTWORK, ETC., DO NOT BLOCK ACCESS TO EQUIPMENT AND RELATED ACCESSORIES
- 10. COORDINATE WALL, FLOOR, AND ROOF PENETRATIONS WITH THE GENERAL CONTRACTOR
- 11. CAULK WITH SILICONE ALL UNUSED PENETRATION GAPS BETWEEN WALL, CEILING AND FLOOR OPENINGS, AND HVAC EQUIPMENT PENETRATIONS AS SHOWN ON MECHANICAL DETAILS. PATCH LARGE GAPS BEFORE CAULKING IS APPLIED.
- 12. SUPPLEMENTAL STEEL MEMBERS REQUIRED TO SUPPORT HVAC EQUIPMENT FROM MAIN STRUCTURE MUST BE PROVIDED BY FOR CONSTRUCTION TYPES. PROCURE AND INSTALL UPON APPROVAL FROM CONTRACTING OFFICER. PROVIDE STRUCTURAL STEEL SUPPORT SUBMITTAL TO ENGINEER OF RECORD FOR REVIEW.
- 13. DUCTWORK AIR DISTRIBUTION SYSTEMS MUST BE INSTALLED IN ACCORDANCE WITH SMACNA STANDARDS AND THE PRESSURE CLASSIFICATION OF EACH INDIVIDUAL DUCTWORK SYSTEM.
- 14. VOLUME DAMPERS MUST BE PROVIDED AT EACH NEW MAIN BRANCH TAKE-OFF AND IN SUCH OTHER LOCATIONS WHERE REQUIRED TO PROPERLY BALANCE THE SYSTEM. ALL REQUIRED VOLUME DAMPERS MAY NOT BE SHOWN ON THE PLANS, BUT MUST BE PROVIDED AT NO ADDITIONAL COST TO THE PROJECT
- 15. INSTRUMENT TEST HOLES MUST BE PROVIDED IN AIR DISTRIBUTION SYSTEMS WHEREVER VOLUME DAMPERS ARE INSTALLED. HOLES MUST BE SEAL WITH RUBBER OR PLASTIC TEST HOLE PLUGS.
- 16. DUCT SIZES SHOWN ARE INSIDE CLEAR DIMENSIONS.
- 17. SQUARE ELBOWS SHALL ONLY BE USED WHERE SPACE LIMITATIONS PREVENT USE OF 1.5 RADIUS ELBOW AND ONLY UPON APPROVAL OF CONTRACTING OFFICER. PROVIDE TURNING VANES IN ALL SQUARE ELBOWS 45 DEGREES OR GREATER TURNING VANES MUST BE SINGLE THICKNESS TYPE WITHOUT TRAILING EDGE. TURNING VANES LONGER THAN 36 INCHES MUST 41. VARIABLE FREQUENCY DRIVES FOR 3 PHASE MOTORS MUST BE 3 POLE TYPE BE DOUBLE THICKNESS TYPE.
- 18. DUCTWORK RUNOUTS TO AIR DISTRIBUTION DEVICES MUST BE THE SAME DIAMETER AS THE AIR DISTRIBUTION DEVICE INLET CONNECTION UNLESS OTHERWISE NOTED ON THE DRAWINGS. DIMENSIONS SHOWN FOR DIFFUSERS AND GRILLES ARE NECK
- 19. FLEXIBLE DUCTWORK RUNOUTS FROM BRANCH DUCTS TO AIR DISTRIBUTION DEVICES MUST NOT EXCEED 5 FEET IN LENGTH. BENDS IN FLEXIBLE DUCTWORK MUST NOT EXCEED A MAXIMUM OF 45 DEGREE CHANGE OF DIRECTION AND BE SUPPORTED SUCH THAT THE BEND RADIUS IS NOT RESTRICTIVE TO AIR FLOW THROUGH THE DUCT. FLEXIBLE DUCTWORK MUST NOT BE CRUSHED OR DISTORTED IN ITS FINAL CONFIGURATION.
- 20. ROUND DUCTWORK CONNECTIONS BETWEEN MAIN DUCT AND TERMINAL UNITS MUST BE RIGID DUCT OF THE SAME DIAMETER AS TERMINAL UNIT INLET CONNECTION UNLESS OTHERWISE NOTED ON THE DRAWINGS.
- 21. PROVIDE SHEETMETAL TRANSITIONS AT AIR HANDLING UNITS, HEAT PUMP UNITS, FANS, AND OTHER SIMILAR HVAC EQUIPMENT. TRANSITION TO FULL SIZE OF CONNECTION ON UNIT. FLEXIBLE DUCT CONNECTORS MUST BE USED ON FINAL CONNECTION TO AIR HANDLING EQUIPMENT, UNLESS NOTED OTHERWISE
- 22. OPEN-ENDED AIR TRANSFER DUCTS AND OPEN-ENDED RETURN AIR DUCTS IN THE CEILING PLENUM MUST BE UNOBSTRUCTED FOR A MINIMUM DISTANCE OF 24 INCHES FROM THE OPENING TO ALLOW FOR FREE AIRFLOW. OPEN-ENDED AIR TRANSFER DUCTS AND OPEN-ENDED RETURN AIR DUCTS IN THE CEILING PLENUM MUST HAVE A 90 DEGREE ELBOW FOR SOUND ATTENUATION AND MUST HAVE WIRE MESH SCREEN COVERS. WIRE MESH SCREENS MUST BE ALUMINUM WITH 1/2" SQUARE HOLES. SIZE FOR MAXIMUM VELOCITY OF 400 FPM.
- 23. LOUVERED SUPPLY AIR DIFFUSERS MUST BE 4-WAY FLOW UNLESS OTHERWISE SHOWN BY FLOW ARROWS ON THE DRAWINGS. LINEAR DIFFUSERS MUST BE ADJUSTABLE 2-WAY FLOW. PROVIDE BATT INSULATION ON DIFFUSER AND GRILLES THAT ARE EXPOSED TO CEILING PLENUM.
- 24. EXACT LOCATION OF CEILING AIR DEVICES MUST BE DETERMINED BY ARCHITECTURAL REFLECTED CEILING PLAN.
- 25. EXACT LOCATIONS OF THERMOSTATS, SENSORS, AND HVAC CONTROL APPURTENANCES MUST BE COORDINATED WITH FINAL LOCATIONS OF WALL-MOUNTED ARCHITECTURAL, FIRE PROTECTION, AND ELECTRICAL EQUIPMENT. MOUNT THERMOSTATS AND SENSORS MINIMUM 4'-0" ABOVE FINISHED FLOOR.
- 26. PROVIDE ACCESS PANELS TO ACCESS DAMPERS, EQUIPMENT, AND VALVES LOCATED ABOVE HARD CEILINGS OR IN WALLS. ACTUAL ACCESS PANEL LOCATIONS MUST BE FIELD DETERMINED.

- ACCESS DOORS MUST BE LOCATED CLOSE TO EACH COMPONENT LISTED ABOVE TO ALLOW FOR INSPECTION. IF FEASIBLE LOCATE DUCT ACCESS DOOR ON THE UNDERSIDE OF THE DUCT RATHER THAN THE SIDE. MINIMUM DUCT ACCESS DOOR SIZE MUST BE BASED ON DUCT SIZE AS FOLLOWS:
- **DUCT SIZE ACCESS DOOR SIZE**
- 12" AND SMALLER 12" LONG FLANGED & GASKETED REMOVABLE DUCT SECTION 13" TO 17" 12" X 12"
- 18" TO 24" 16" X 18" 25" AND LARGER 24" X 16"
- 28. AIR HANDLING UNITS SERVING OCCUPIED AREAS MUST HAVE MINIMUM MERV 8 FILTERS. UNITS NOT SERVING OCCUPIED ZONES MUST HAVE MINIMUM MERV 8 FILTER. FILTERS MUST BE INDUSTRY STANDARD SIZE. FILTERS MUST NOT CREATE PRESSURE DROP EXCEEDING 10% OF EXTERNAL STATIC PRESSURE (ESP) CAPACITY LISTED IN EQUIPMENT SCHEDULE.
- 29. SUPPLY, RETURN, AND OUTDOOR AIR DUCTWORK MUST BE INSULATED TO MEET OR EXCEED ASHRAE 90.1 2013. EXTERIOR SUPPLY AND RETURN AIR DUCTWORK MUST BE PROVIDED WITH WEATHER-PROOF COVER.
- 30. PIPING INSULATION MUST BE PROVIDED ON ALL PIPING SYSTEMS INCLUDING (BUT NOT LIMITED TO) CHILLED WATER, HEATING HOT WATER. CONDENSER WATER. REFRIGERANT. AND CONDENSATE DRAIN IN ACCORDANCE WITH ASHRAE 90.1-2013
- 31. SIZE REFRIGERANT LINES PER MANUFACTURER'S INSTRUCTIONS BASED ON ACTUAL LINE LENGTHS AND EQUIPMENT ELEVATIONS INSTALLED. USE OF HCFC AND CFC REFRIGERANTS IS PROHIBITED. INSULATION ON REFRIGERANT LINES EXPOSED TO WEATHER MUST HAVE ALUMINUM JACKETING.
- 32. PIPING CONTAINING WATER THAT IS EXPOSED TO FREEZING TEMPERATURES MUST BE INSULATED AND HEAT-TRACED.
- 33. COORDINATE LOCATIONS OF CONDENSATE DRAIN PIPING. PROVIDE CONDENSATE PUMPS WHERE SUFFICIENT SLOPE IS NOT AVAILABLE FOR STANDARD GRAVITY DRAIN. PROVIDE WITH OVERFLOW SWITCH TO POWER DOWN THE ASSOCIATED AIR HANDLING EQUIPMENT IN CASE OF CONDENSATE PUMP FAILURE. CONDENSATE DRAIN LINE MUST SLOPE DOWN TOWARDS DISCHARGE LOCATION AT A MINIMUM OF 1/8" PER LINEAR FOOT. INSULATE INDOOR CONDENSATE PIPING WITH 3/4" CLOSED CELL FOAM INSULATION.
- 34. PROVIDE SHUT-OFF VALVES AND FLEXIBLE CONNECTIONS AT PIPE CONNECTIONS TO HVAC EQUIPMENT.
- 35. PROVIDE SUPPORTS FOR PIPING AND DUCTWORK IN ACCORDANCE WITH SPECIFICATIONS.
- THE HVAC CONTRACTOR UNLESS SPECIFICALLY NOTED OTHERWISE. REFER TO STRUCTURAL DRAWINGS AND SPECIFICATIONS 36. PROVIDE EXPANSION LOOPS OR APPROVED FLEXIBLE PIPE EXPANSION DEVICES FOR PIPING SYSTEMS WITH OPERATING TEMPERATURES ABOVE 70°F OR BELOW 50°F. PIPE SUPPORTS FOR PIPING SYSTEMS WITH EXPANSION DEVICES OR EXPANSION LOOPS MUST HAVE ROLLER SUPPORTS
  - 37. PROVIDE AUTOMATIC AIR VENTS AT HIGH POINTS OF HYDRONIC PIPING SYSTEMS. PROVIDE DRAIN VALVES AT THE LOW POINTS IN HYDRONIC PIPING SYSTEMS FOR DRAINAGE. BRANCH VALVES AND DRAINS MUST BE PROVIDED TO ENABLE ISOLATING A PIPE SECTION FOR MAINTENANCE WITHOUT SHUTTING DOWN ENTIRE SYSTEM.
  - 38. PROVIDE HOUSEKEEPING PADS FOR MECHANICAL EQUIPMENT. COORDINATE WITH STRUCTURAL
  - 39. CONTROL WIRING (I.E. 120 VOLT AND BELOW) INCLUDING 120 VOLT CONTROL POWER TO MOTOR OPERATED DAMPERS, VALVES, AND VARIABLE VOLUME BOXES MUST BE PROVIDED UNDER THIS DIVISION UNLESS SHOWN ON THE ELECTRICAL DRAWINGS. POWER WIRING (120V) TO CONTROL PANELS MUST BE PROVIDED BY ELECTRICAL. POWER (120V) AND CONTROL (24V) WIRING TO APPLICATION-SPECIFIC CONTROLLERS AND OTHER CONTROL SYSTEM COMPONENTS MUST ORIGINATE AT CONTROL PANELS AND BE PROVIDED UNDER THIS DIVISION.
  - 40. INSTALL EXPOSED CONTROL WIRING IN CONDUIT. SEE DIVISION 26 SPECIFICATIONS FOR REQUIREMENTS.

  - 42. ALL EQUIPMENT WITH NATURAL GAS COMBUSTION MUST BE VENTED PER THE APPLICABLE CODES.
  - 43. MANUFACTURER NAME AND MODEL NUMBERS ARE BASIS OF DESIGN AND ARE SHOWN FOR INFORMATION ONLY. REFER TO SPECIFICATIONS FOR COMPLETE REQUIREMENTS.
  - 44. EQUIPMENT LAYOUT IS BASED ON ONE MANUFACTURER'S PRODUCT. WHERE EQUIPMENT SELECTED BY THE CONTRACTOR FOR USE ON THE JOB DIFFERS FROM LAYOUT. THE CONTRACTOR MUST BE RESPONSIBLE FOR COORDINATING SPACE REQUIREMENTS AND EQUIPMENT CONNECTION ARRANGEMENTS.
  - 45. SPECIFICATIONS TAKE PRECEDENCE OVER DRAWINGS. HOWEVER, ITEMS SHOWN ON DRAWING BUT NOT IN THE SPECIFICATIONS ARE REQUIRED WITHIN THE PROJECT SCOPE. IN ADDITION, SPECIFIC ITEMS SHOWN ON THE DRAWINGS TAKE PRECEDENCE OVER SPECIFICATIONS IN CASES WHERE THE SPECIFICATION HAS OPTIONS.
  - 46. FACTORY PAINTED EQUIPMENT THAT HAS BEEN SCRATCHED OR MARRED MUST REPAINTED TO MATCH ORIGINAL COLOR. STEEL EQUIPMENT HANGERS. THREADED RODS. BOLTS. NUTS. SUPPORTS. AND UNINSULATED BLACK STEEL PIPE EXPOSED TO SIGHT INSIDE OR OUTSIDE THE BUILDING WHICH ARE NOT PROVIDED WITH A FACTORY APPLIED PRIME COAT MUST BE CLEANED OF RUST. GREASE. AND SCALE. AFTER CLEANING THE HANGERS. SUPPORTS AND PIPE. A FIELD APPLIED PRIME COAT MUST BE PROVIDED. IN ADDITION, SUCH ITEMS IN FINISHED SPACES MUST ALSO BE PROVIDED WITH TWO COATS OF FINISH PAINT IN A COLOR TO MATCH ADJACENT SURFACES OR AS NOTED; SUCH ITEMS OUTSIDE THE BUILDING MUST ALSO BE PROVIDED WITH TWO COATS OF BITUMINOUS ALUMINUM PAINT. INSULATED PIPES OUTSIDE THE BUILDING MUST BE CLEANED OF RUST. GREASE AND SCALE, AND PROVIDED WITH A FIELD APPLIED PRIME COAT BEFORE INSTALLING INSULATION.
  - 47. IF ASBESTOS IS FOUND, STOP WORK IMMEDIATELY AND NOTIFY OWNER AND GENERAL CONTRACTOR AND CONTRACTING OFFICER. COORDINATE WITH CONTRACTING OFFICER'S REPRESENTATIVE FOR ABATEMENT OF ASBESTOS.
  - 48. NOT ALL MECHANICAL ABBREVIATIONS SHOWN WILL BE USED FOR THIS PROJECT.

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**CONSULTANT** 

**CLIENT INFORMATION** 



**PROJECT NAME** 

Cameron Prairie National Wildlife Refuge Bunkhouse

LA-27 Bell City, LA 70630

**DRAWING ISSUE** 

DESIGNED BY: S. THOMAS

DRAWN BY: S. THOMAS CHECKED BY: J. LEDYARD SUBMITTED BY: C. CUSICK 02/12/2024 PROJECT #: 1220834

**MECHANICAL GENERAL NOTES** 

> AND DESIGN CRITERIA

**SHEET TITLE** 

SHEET NUMBER

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SHEET TITLE

**MECHANICAL ABBREVIATIONS** AND LEGENDS

**SHEET NUMBER** M-002

ORIGINAL SHEET SIZE:

- 1. REFER TO M-001 FOR MECHANICAL GENERAL NOTES AND DESIGN CRITERIA.
- 2. REFER TO M-002 FOR MECHANICAL ABBREVIATIONS AND LEGENDS.

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PROJECT NAME

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LA-27 Bell City, LA 70630

**DRAWING ISSUE** 


DESIGNED BY: S. THOMAS DRAWN BY: S. THOMAS CHECKED BY: J. LEDYARD SUBMITTED BY: C. CUSICK 02/12/2024 PROJECT #: 1220834

SHEET TITLE

**MECHANICAL HVAC FLOOR** PLAN

SHEET NUMBER MH101

ORIGINAL SHEET SIZE: 24" X 36"

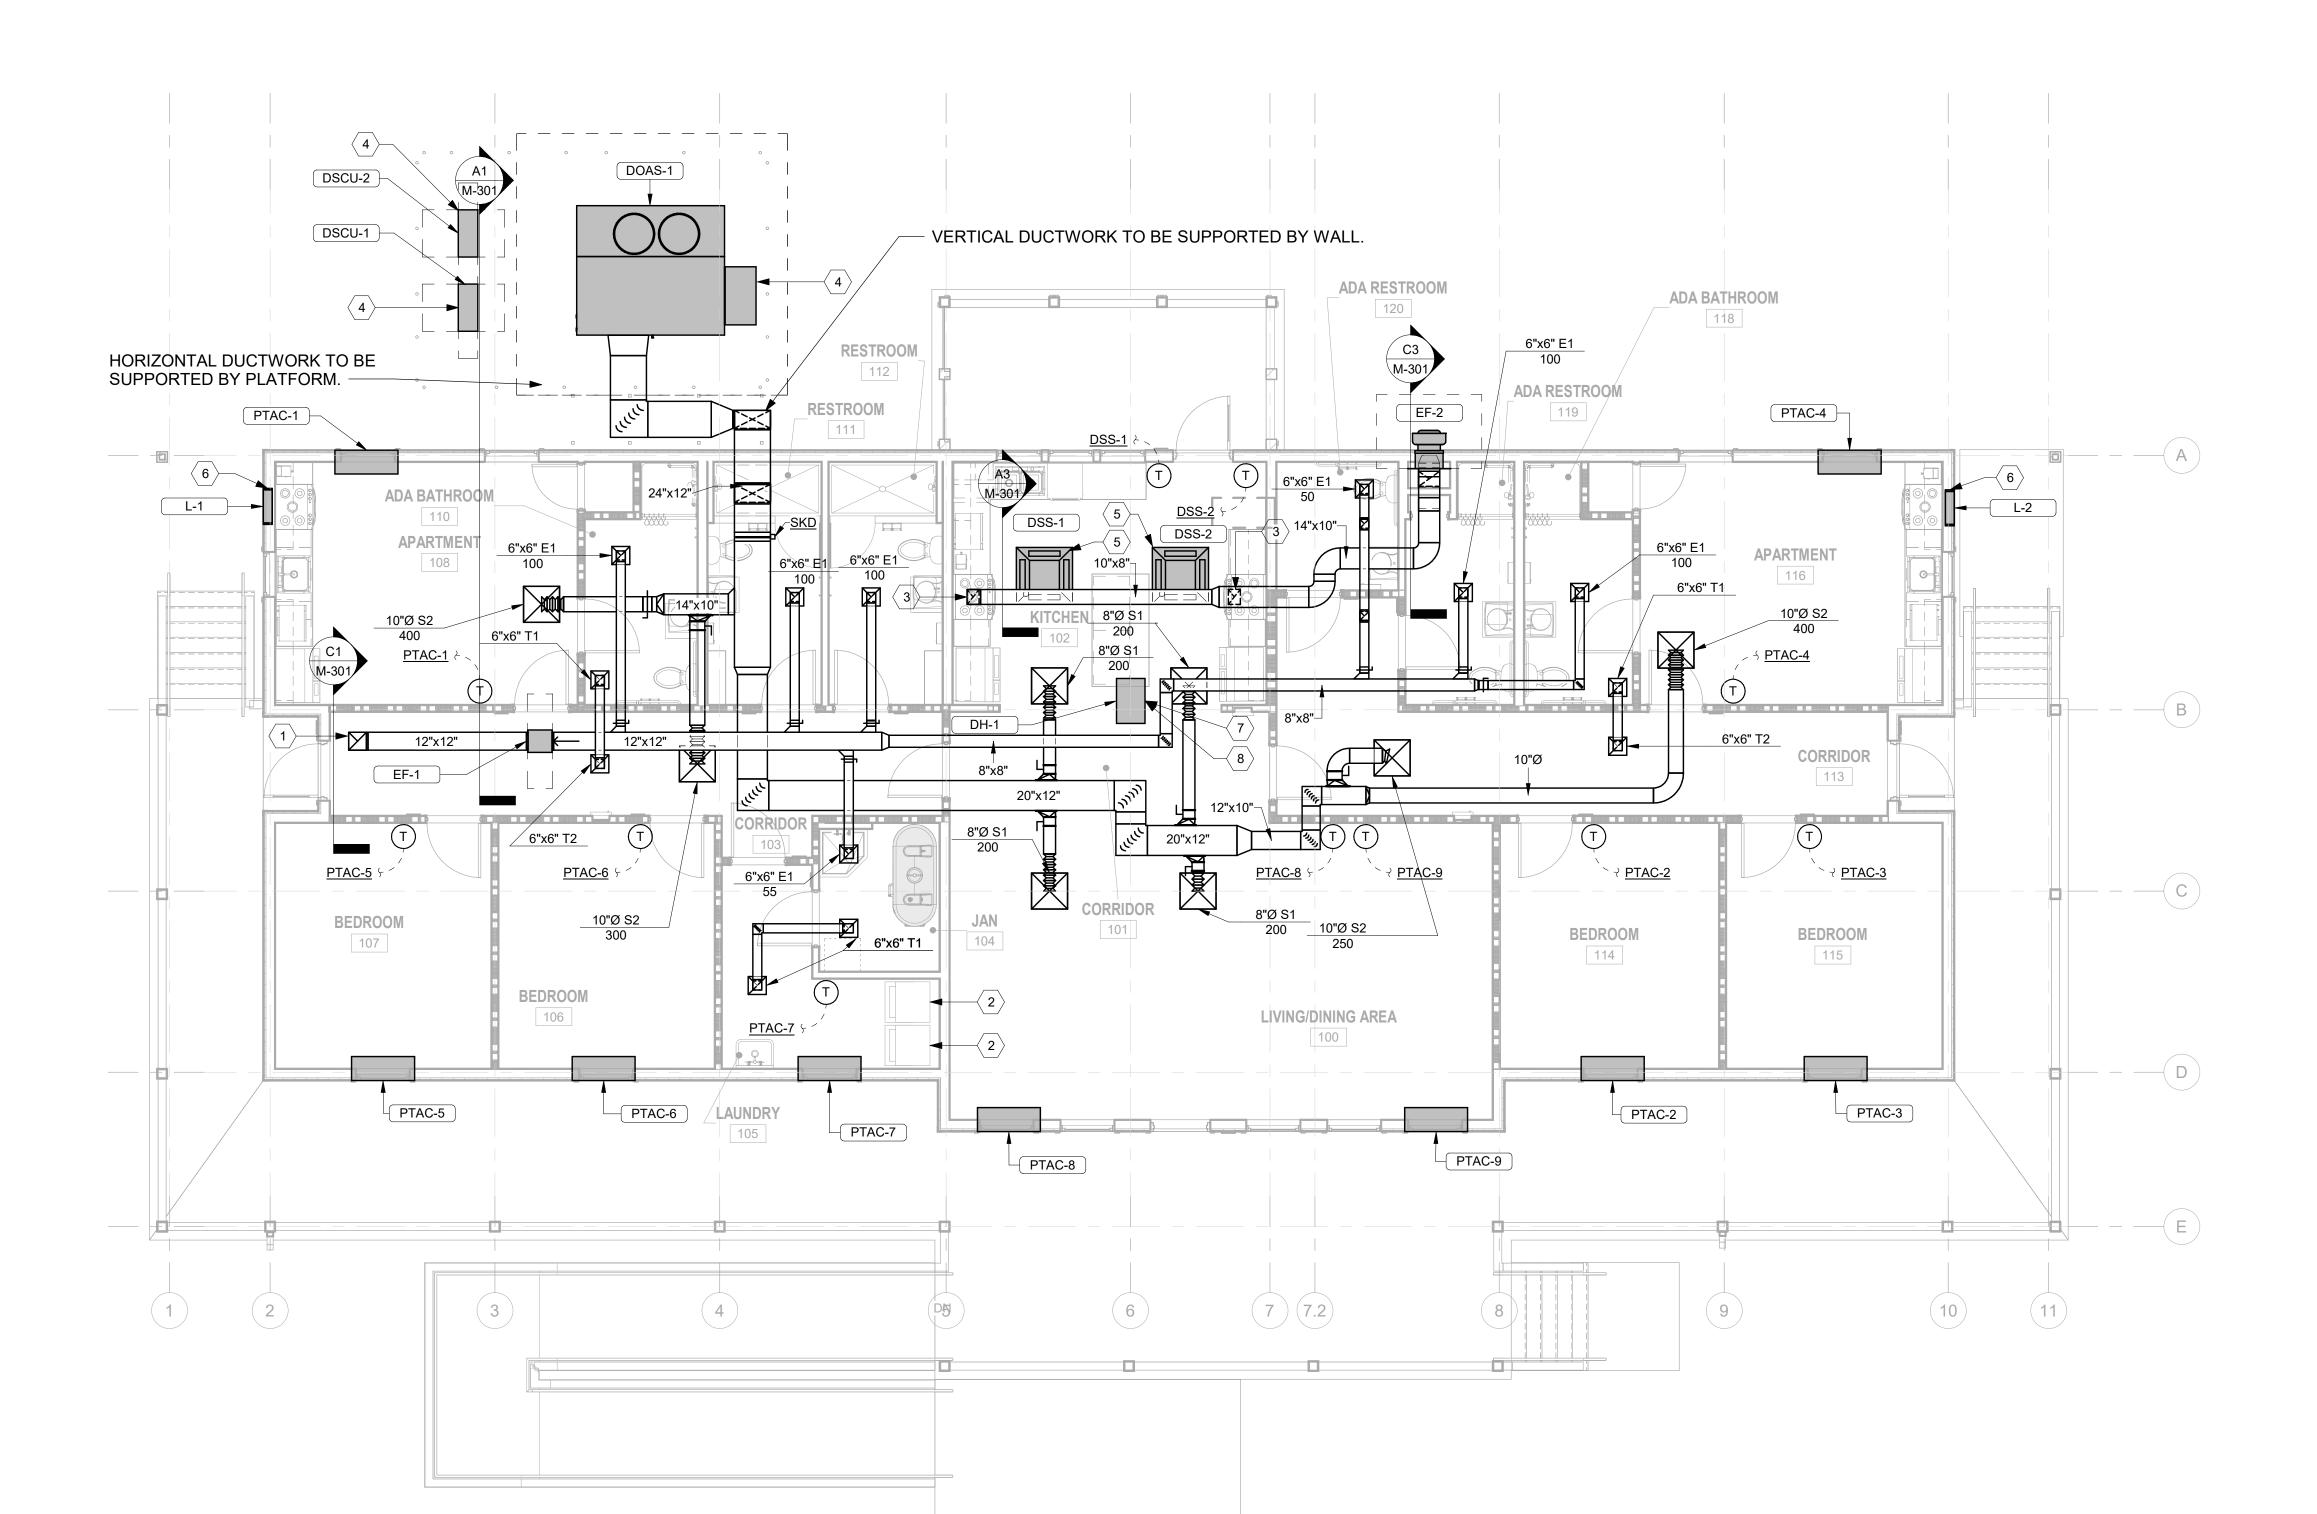


#> KEYNOTES

- 1 EXHAUST DUCTWORK ROUTED UP THROUGH ROOF TO RH-1. SEE A1/MH102 FOR CONTINUATION
- 2 ROUTE 4" DRYER VENT DUCTWORK DOWN PENETRATING THROUGH THE FLOOR AND ROUTING OUT TOWARDS THE STAIR. IT SHALL TERMINATE AT A DRYER VENT CAP ON THE UNDERSIDE OF THE STRUCTURE AT COLUMN LINE E.
- 3 TIE KITCHEN EXHAUST DUCTWORK INTO MICROWAVE EXHAUST PLENUM BOX. THE AIRFLOW SHALL BE BALANCED AT 400 CFM PER MANUFACTURER. PROVIDE PLENUM BOX WITH DAMPER. MATCH DUCT SIZE TO PLENUM CONNECTION SIZE AT CONNECTION. REFER TO MANUFACTURER'S RECOMENDATIONS FOR DETAILS ON HOW TO CONNECT TO PLENUM BOX.
- 4 EQUIPMENT LOCATED ON STRUCTURAL PLATFORM. REFER TO STRUCTURE FOR DETAILS.
- 5 ROUTE CONDENSATE PIPING TO MOP SINK IN 104 JAN. PROVIDE MANUFACTURER'S CONDENSATE PUMP. SLOPE PIPING PER MANUFACTURER'S RECOMMENDATION.
- 6 TIE WALL LOUVER USING MANUFACTURER'S RECOMMENDED DUCTWORK INTO MICROWAVE EXHAUST PLENUM BOX. THE AIRFLOW SHALL BE BALANCED AT 400 CFM PER MANUFACTURER. PROVIDE PLENUM BOX WITH DAMPER. MATCH DUCT SIZE TO LOUVER CONNECTION SIZE AT CONNECTION. REFER TO MANUFACTURER'S RECOMENDATIONS FOR DETAILS ON HOW TO CONNECT TO PLENUM BOX.
- 7 ROUTE DEHUMIDIFIER DRAIN LINE TO MOP SINK IN 104 JAN. PROVIDE MANUFACTURER'S CONDENSATE PUMP. SLOPE PIPING PER MANUFACTURER'S RECOMMENDATION.
- 8 DEHUMIDIFIER SHALL BE SUSPENDED FROM STRUCTURE AND LOCATED IN THE ATTIC. REFER TO STRUCTURE FOR DETAILS.

MECHANICAL HVAC FLOOR PLAN

SCALE: 3/16" = 1'-0"

SCALE: 3/16" = 1'-0"

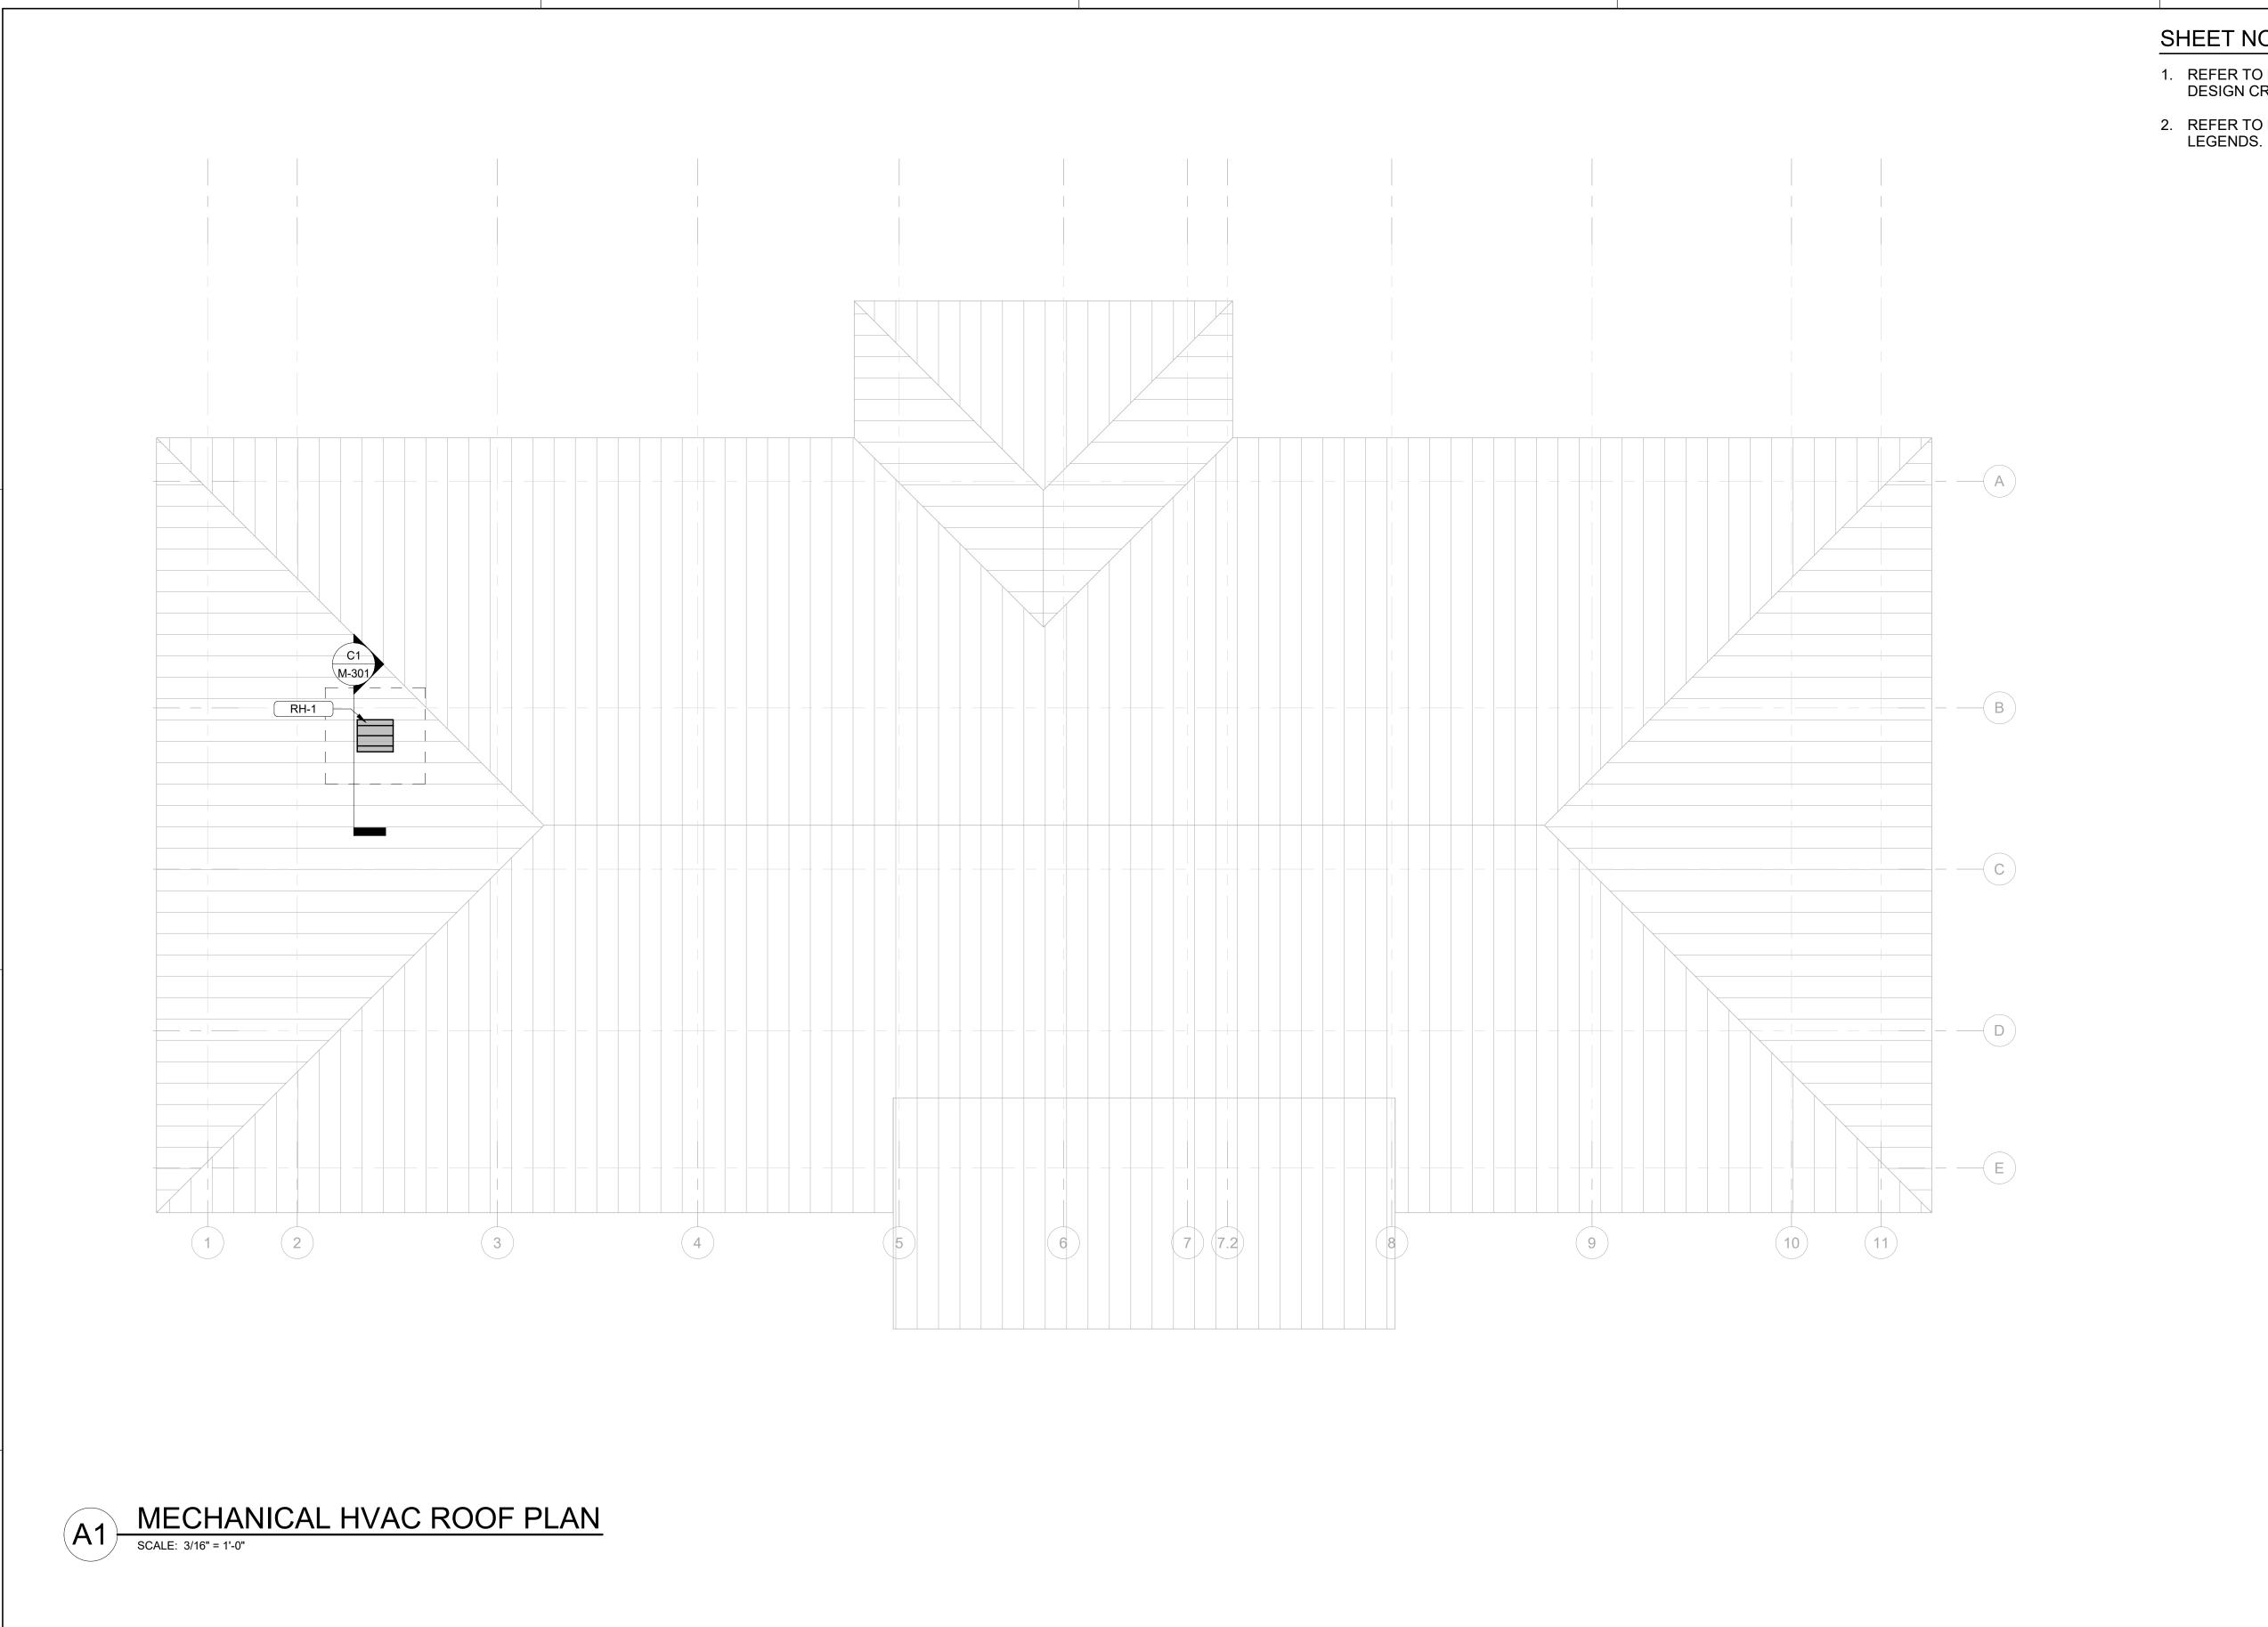

REFER TO M-001 FOR MECHANICAL GENERAL NOTES AND DESIGN CRITERIA.

2. REFER TO M-002 FOR MECHANICAL ABBREVIATIONS AND

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SHEET TITLE

MECHANICAL **HVAC ROOF PLAN** 

SHEET NUMBER

MH102


LEVEL 1 0' - 0" C1 EXHAUST DUCT THROUGH TRUSS 12"x24"-

DOAS AND SUPPLY DUCT THROUGH WALL

DOAS-1

└─\_ EF-1

LEVEL 1 0' - 0"

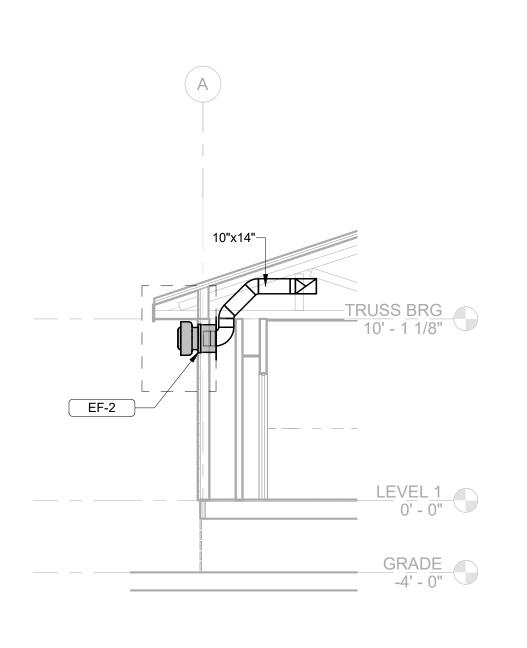

C3 KITCHEN EXHAUST FAN

## SHEET NOTES

- REFER TO M-001 FOR MECHANICAL GENERAL NOTES AND DESIGN CRITERIA.
- 2. REFER TO M-002 FOR MECHANICAL ABBREVIATIONS AND LEGENDS.

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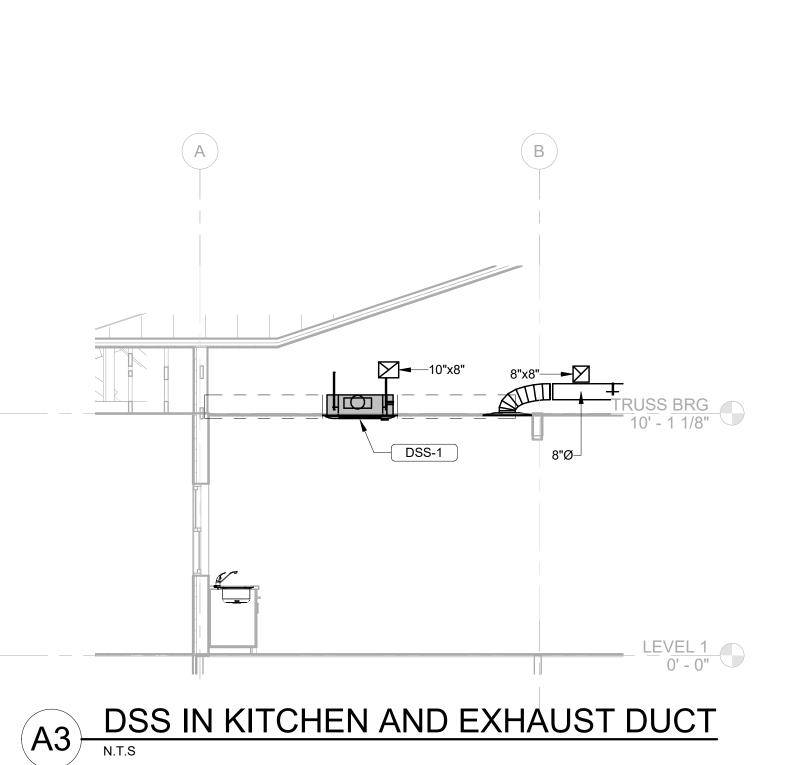
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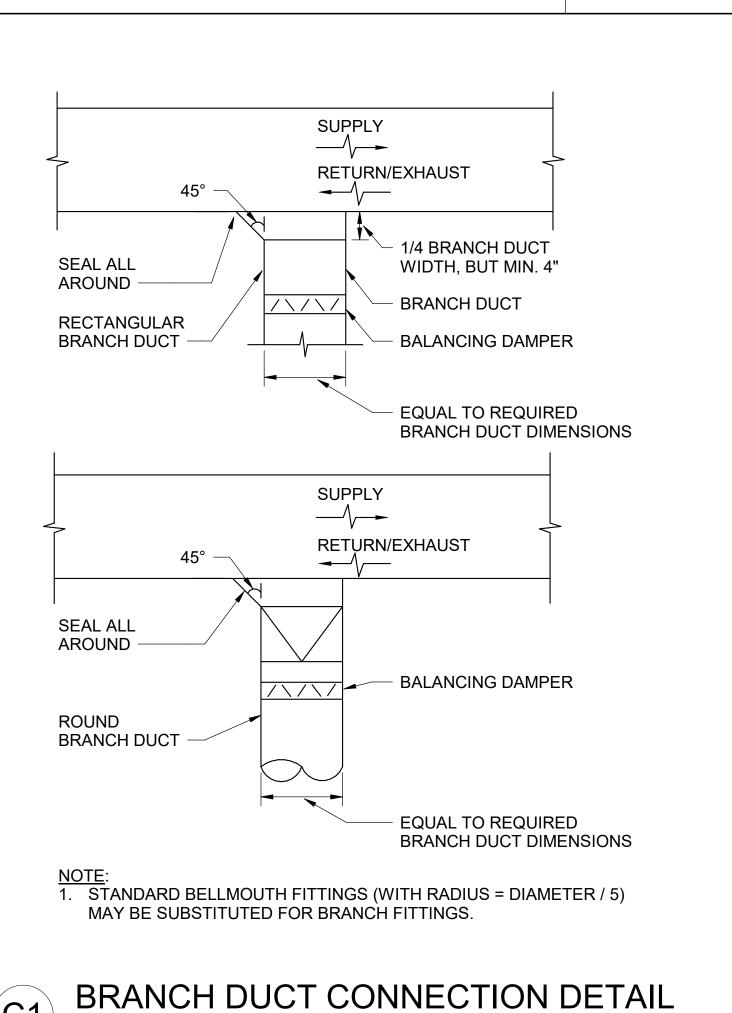
SHEET TITLE

MECHANICAL SECTIONS

SHEET NUMBER

M-301







- CONTROL CONNECTIONS INSULATED REFRIGERANT LINES, SIZED PER MANUFACTURER'S RECOMMENDATIONS SECURE TO STRUCTURE (TYP.) VIBRATION ISOLATOR (TYP.) 3/8" THREADED ROD (TYP.) **OUTDOOR UNIT** HANGING BRACKETS (TYP.) SECURE INDOOR UNIT OUTDOOR UNIT TO CONCRETE PAD -4 WAY SUPPLY AIR DISCHARGE, CENTER RETURN AIR GRILLE - CONDENSATE DRAIN LINE, REFER TO FLOOR PLANS STRUCTURAL PAD; REFER TO TYPICAL STRUCTURAL DETAIL


NOTES:

1. COORDINATE INDOOR UNIT LOCATION ABOVE CEILING WITH OTHER TRADES PRIOR TO INSTALLATION. 2. MAINTAIN MINIMUM REQUIRED SERVICE CLEARANCES IN ACCORDANCE WITH MANUFACTURER'S RECOMMENDATIONS.

CEILING-MOUNTED DUCTLESS SPLIT SYSTEM DETAIL

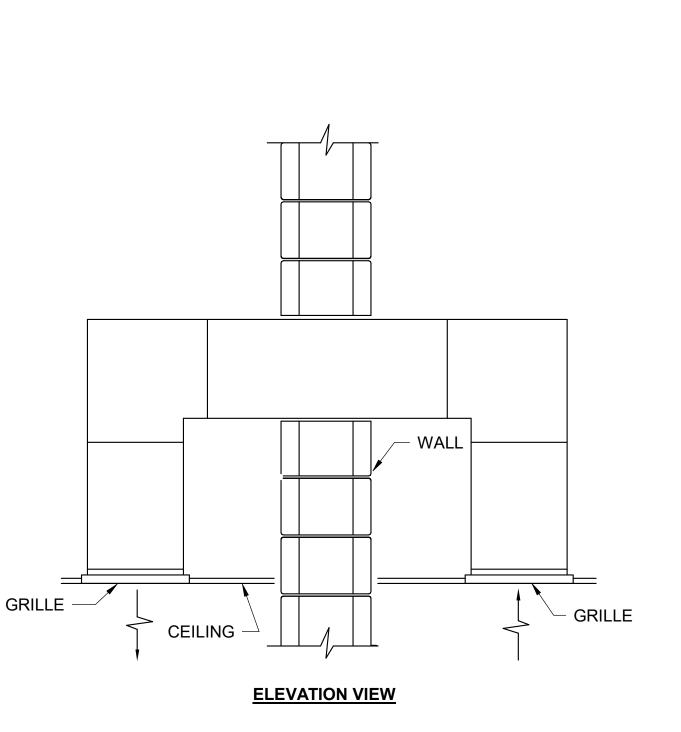

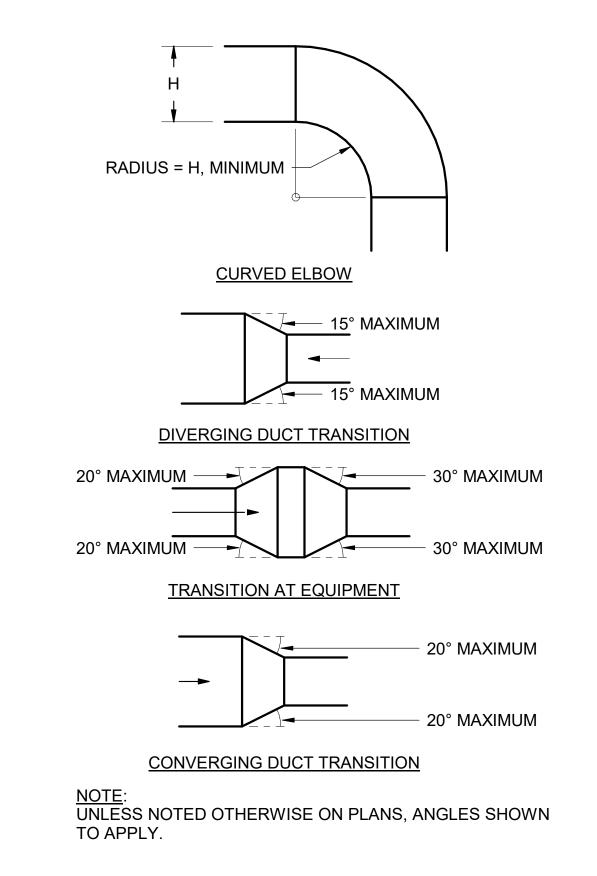

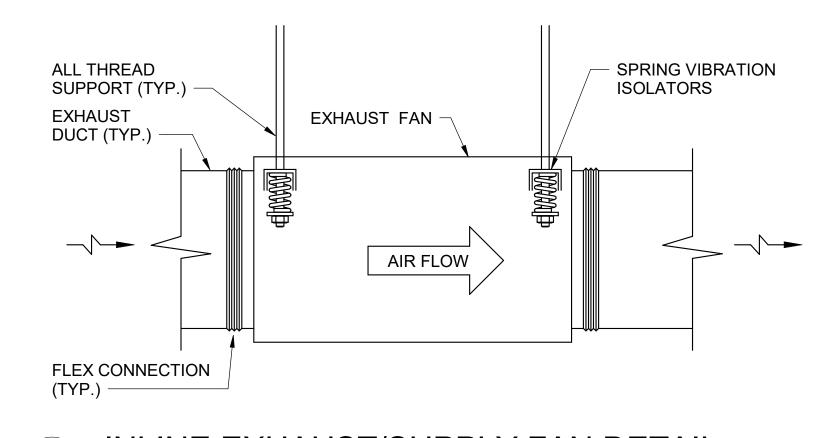

A2 TYPICAL DUCT TRANSITION DETAIL

A4 INLINE EXHAUST/SUPPLY FAN DETAIL

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SHEET TITLE

**MECHANICAL DETAILS** 


SHEET NUMBER M-501

ORIGINAL SHEET SIZE: 24" X 36"


A1 TRANSFER DUCT DETAIL

100% ISSUED FOR CONSTRUCTION

# C1 CONDENSATE DRAIN (BLOW-THROUGH FAN) DETAIL

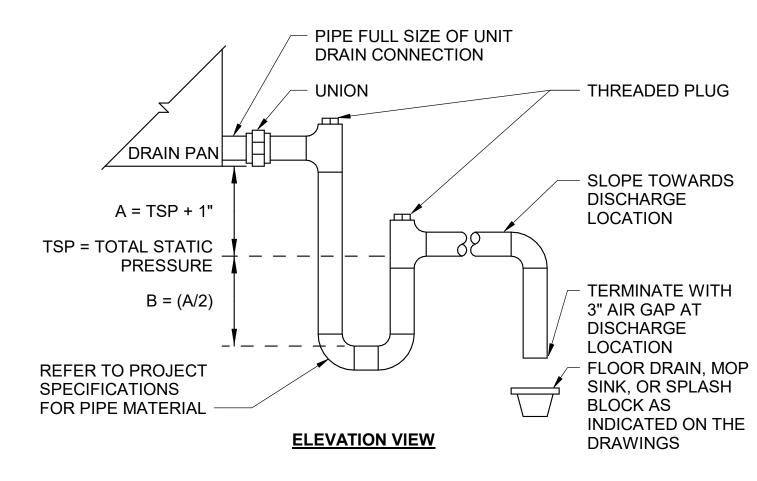


# (B1) CONDENSATE DRAIN (DRAW-THROUGH FAN) DETAIL

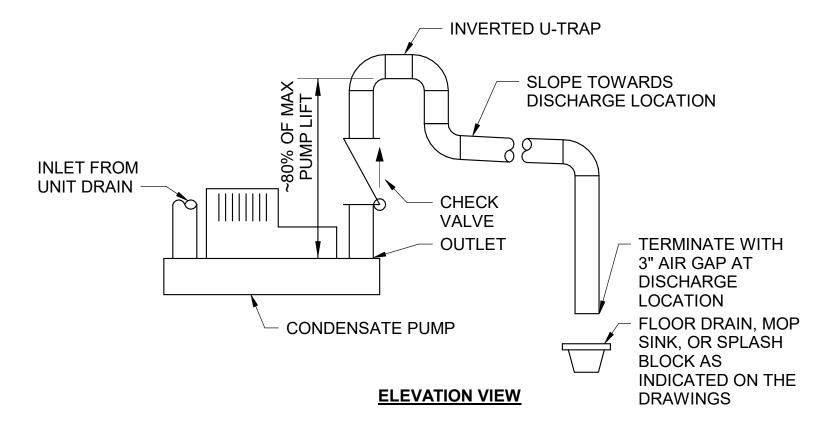


- NOTE:

  1. CONNECT UNIT DRAIN OUTLET TO CONDENSATE PUMP PER MANUFACTURER'S RECOMMENDATIONS. PIPE FULL SIZE OF UNIT
- 2. PROVIDE CONDENSATE PUMP OUTLET DRAIN MATERIAL AND SIZE PER MANUFACTURER'S RECOMMENDATIONS.



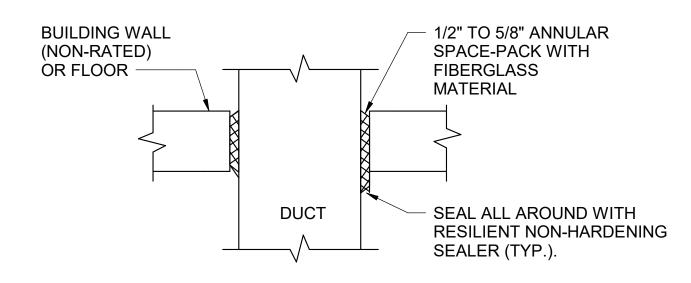


# D4 DUCT PENETRATION DETAIL N.T.S

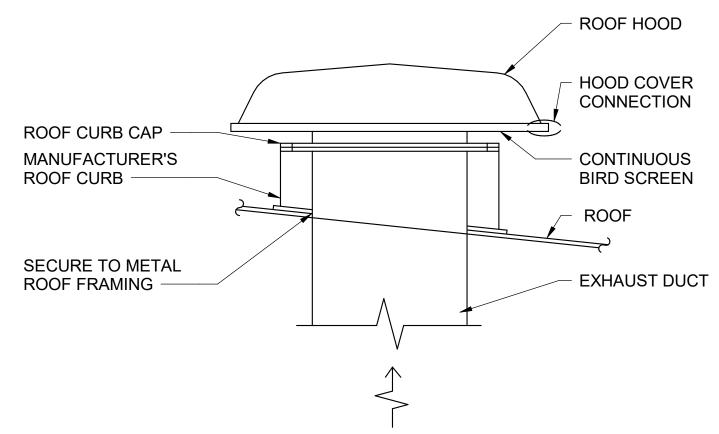

NOTES:

1. INSTALL ROOF HOOD PER ROOF MANUFACTURER'S RECOMMENDATIONS.

## EXHAUST ROOF HOOD DETAIL

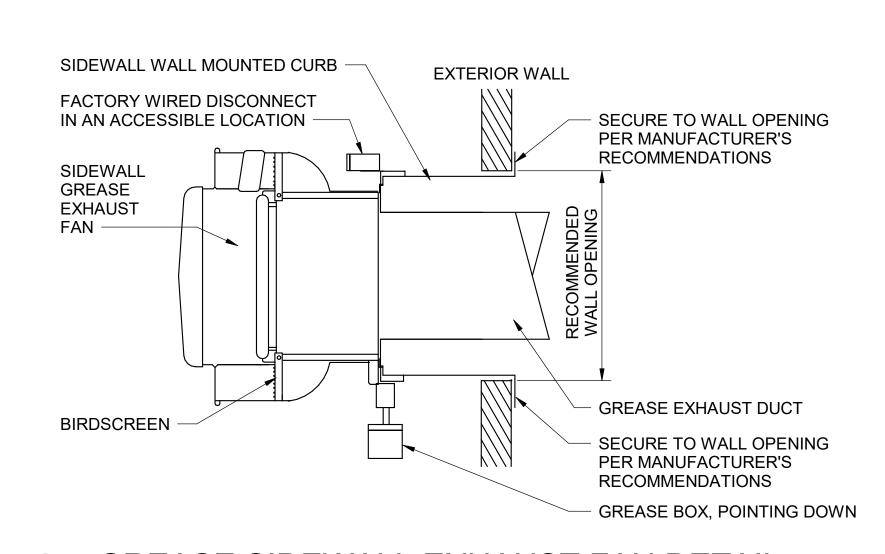

GREASE SIDEWALL EXHAUST FAN DETAIL

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PROJECT #: 1220834 SHEET TITLE

> **MECHANICAL DETAILS**

SHEET NUMBER M-502

TYPICAL ROOFTOP PIPE SUPPORT DETAIL

\_\_\_ TIE OFF TO

**ABOVE** 

STRUCTURE

FLEXIBLE DUCT WITH

FLEXIBLE DUCT WITH

MAX. LENGTH 5'-0"

EXTERNAL INSULATION,

MAX. LENGTH 5'-0"

INSULATED LAY-IN SUPPLY AIR

DIFFUSER WITH ROUND NECK

TIE OFF TO

STRUCTURE

INSULATED LAY-IN SUPPLY AIR

DIFFUSER WITH ROUND NECK

1. NECK SIZE OF DIFFUSER TO MATCH FLEXIBLE DUCT SIZE UNLESS NOTED OTHERWISE ON PLANS.

3. FLEXIBLE RUN-OUT DUCT TO NOT EXCEED 5'-0" IN LENGTH AND ANGLE OF OFFSET TO NOT EXCEED

90 DEGREE INSTALLATION OPTION

**ABOVE** 

**45 DEGREE INSTALLATION OPTION** 

EXTERNAL INSULATION,

T-BAR TYPE

T-BAR TYPE

SUSPENDED CEILING

SUSPENDED CEILING

**BRANCH DUCT** 

BALANCING DAMPER

IN BRANCH DUCT

SUPPLY DUCT

DETAIL

**BRANCH DUCT** 

BALANCING DAMPER

SUPPLY DUCT

DETAIL

BRANCH DUCT TAP, REFER TO BRANCH


**DUCT CONNECTION** 

IN BRANCH DUCT

BRANCH DUCT TAP, **REFER TO BRANCH** 

**DUCT CONNECTION** 

BUILD UP INSULATION ON ONE SIDE TO PROVIDE SLOPE AND PREVENT STANDING WATER ON TOP OF DUCTWORK

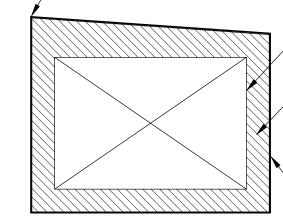

RIGID SHEET METAL AIR DUCT, SIZE AS INDICATED ON THE DRAWINGS

DUCT INSULATION, REFER TO SPECIFICATIONS FOR INSULATION REQUIREMENTS

WRAP ALL EXTERIOR DUCTWORK AND INSULATION WITH WEATHER-PROOF MEMBRANE

1. WATERPROOF ALL SEAMS AND JOINTS IN DUCTS PER SPECIFICATIONS.

- 2. SEAL ALL SEAMS AND JOINTS AT POINTS OF SUPPORT AND
- REINFORCEMENT ATTACHMENTS PER SPECIFICATIONS. 3. REFER TO STRUCTURAL DRAWINGS FOR EXPOSED EXTERIOR DUCT SUPPORT DETAILS.

# C2 EXPOSED EXTERIOR DUCTWORK DETAIL


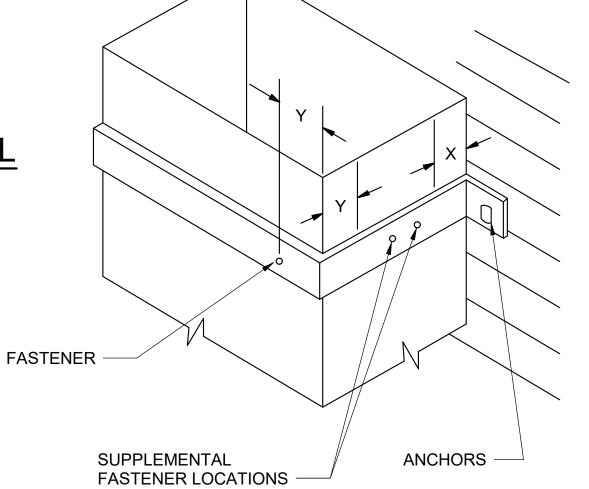



FIG. A - SUGGESTED SIZING

DUCT SIZE 18" x 12" <u>BAND</u> 1 -1/2" x 16" GA 24" x 20" 1" x 1/8"

**ALLOWABLE** LOAD PER **DUCT GAGE FASTENER\*** 28, 26 25 LB 24, 22, 20 35 LB 50 LB 18, 16

\* WELD, BOLT, OR NO. 8 SCREW (MIN.) DEVIATION PERMITTED BY OTHER ANALYSIS. X=1", Y=2"; ADD OTHER TO ACCOMMODATE LOAD. MINIMUM OF 3 ON 24" WIDTH AND UP ADD ALONG SIDES NEAREST ANCHORS.

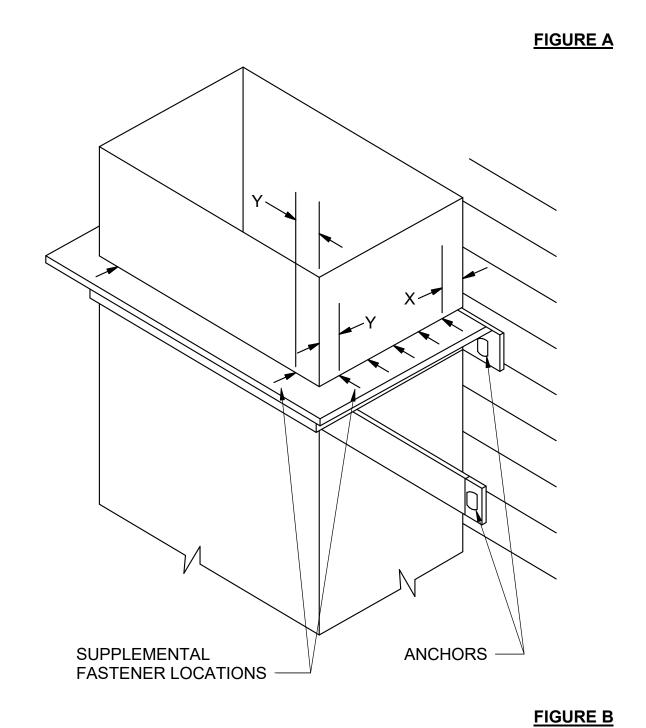

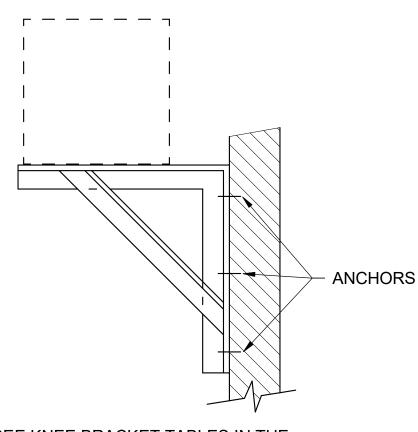

SEE KNEE BRACKET TABLES IN THE SMACNA ROUND INDUSTRIAL STANDARDS

#### FIG. B - SUGGESTED SIZING

116. 6 - 30	GGL31LD SIZING
DUCT SIZE	<u>ANGLE</u>
30" x 12"	1" x 1" x 1/8"
36" x 18"	1" x 1" x 1/8"
42" x 24"	1-1/4" x 1-1/4" x 1/8"
48" x 30"	1-1/4" x 1-1/4" x 1/8"

## NOTES:

- BRACKETS ARE SIZED FOR 12 FEET OF DUCT MAXIMUM.
- 2. LOCATE DUCTS AGAINST WALL OR MAXIMUM OF 2" AWAY FROM WALL.
- 3. EACH WALL ANCHOR TO SATISFY THE FOLLOWING CRITERIA UNLESS OTHER ANALYSIS IS MADE: A. TENSILE LOAD = 3/8 x DUCT WEIGHT; SAFETY FACTOR 4.
- B. SHEAR LOAD x 1/2 x DUCT WEIGHT; SAFETY FACTOR 4.

(DETAIL FROM SMACNA HVAC DUCT CONSTRUCTION STANDARDS METAL AND FLEXIBLE, 3RD EDITION)

FLEXIBLE DUCT CONNECTION DETAIL

2. COORDINATE DIFFUSER FRAME TYPE WITH CEILING.

PROVIDE 45

**ELBOW AND** 

PROVIDE RIGID

**DURABLE ELBOW** 

45 DEGREES.

**ELBOW AND** 

SUPPORT

DEGREE RIGID

DURABLE ELBOW OF ELBOW

METAL BAND

SUPPORT

OF ELBOW

WITHIN 1'-0"

METAL BAND

SUPPORT

WITHIN 1'-0"



RECTANGULAR DUCT SUPPORT FROM WALL DETAIL
N.T.S

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**EOR/AOR SEAL** 

CONSULTANT

**CLIENT INFORMATION** 



US Fish & Wildlife Service

PROJECT NAME

Cameron Prairie National Wildlife Refuge Bunkhouse

LA-27 Bell City, LA 70630

DRAWING ISSUE

DESIGNED BY: S. THOMAS

DRAWN BY: S. THOMAS CHECKED BY: J. LEDYARD SUBMITTED BY: C. CUSICK 02/12/2024 1220834 PROJECT #:

SHEET TITLE

**MECHANICAL** DETAILS

SHEET NUMBER M-503

						PACK	AGED T	ERMIN	NAL HEA	AT PUMP	SCH	IEDUI	LE								
	LOCATION		BASIS OF	DESIGN		F	AN			COOLING DA	ATA		HEA	ATING DATA					ELECTRICA	L DATA	
						AIR MAX	FLOW OUTSIDE	FAN POWER	NOMINAL	MINIMUM	EAT	EAT	NOMINAL	MINIMUM	EAT	UNIT WEIGHT	FFR (@	COP (@		NO. OF	
ID	NAME	NO. M	MANUFACTURER	MODEL NO.	TYPE	CFM	AIR CFM	(W)	(BTUH)	(BTUH)		(wb °F)	(BTUH)	(BTUH)	(db °F)	(LBS)	AHRI)	47°F)	VOLTAGE	POLES	REMARKS
PTAC-1	APARTMENT	108	AMANA	HEH093J	THROUGH WALL	290	55	690.0	9000	9000	81.7	68.4	8200	8000	60.7	102	13	3.9	208	2	
PTAC-2	BEDROOM	114	AMANA	HEH073J	THROUGH WALL	330	10	530.0	7100	7100	79.9	66.9	6300	6100	65.0	106	13.3	3.9	208	2	
PTAC-3	BEDROOM	115	AMANA	HEH073J	THROUGH WALL	330	10	530.0	7100	7100	79.9	66.9	6300	6100	65.0	106	13.3	3.9	208	2	
PTAC-4	APARTMENT	116	AMANA	HEH093J	THROUGH WALL	290	55	690.0	9000	9000	81.7	68.4	8200	8000	60.7	102	13	3.9	208	2	
PTAC-5	BEDROOM	107	AMANA	HEH073J	THROUGH WALL	330	10	530.0	7100	7100	79.9	66.9	6300	6100	65.0	106	13.3	3.9	208	2	
PTAC-6	BEDROOM	106	AMANA	HEH073J	THROUGH WALL	330	35	530.0	7100	7100	80.9	67.8	6300	6100	62.5	106	13.3	3.9	208	2	
PTAC-7	LAUNDRY	105	AMANA	HEH073J	THROUGH WALL	330	25	530.0	7100	7100	80.5	67.4	6300	6100	63.5	106	13.3	3.9	208	2	
PTAC-8	LIVING ROOM	100	AMANA	HEH153J	THROUGH WALL	400	70	1315.0	14500	14500	80.2	67.2	14400	14200	64.1	113	10.7	3.2	208	2	
PTAC-9	LIVING ROOM	100	AMANA	HEH153J	THROUGH WALL	400	70	1315.0	14500	14500	80.2	67.2	14400	14200	64.1	113	10.7	3.2	208	2	

1. PROVIDE MANUFACTURER'S STARTER.

2. PROVIDE MANUFACTURER'S CIRCUIT BREAKER, AND WALL PLUG KIT.

3. PROVIDE MANUFACTURER'S ARCHITECTURAL GRILLE WITH FINISH TO BE SELECTED BY ARCHITECTURAL. PROVIDE MANUFACTURER'S COLOR WHEEL WITH SUBMITTAL PACKAGE.

4. PROVIDE MANUFACTURER'S INTEGRAL SLINGER RING FOR CONDENSATE REMOVAL.

5. PROVIDE MANUFACTURER'S WALL-MOUNTED PROGRAMMABLE THERMOSTAT WITH DISPLAY MODULE. 6. PROVIDE MANUFACTURER'S LEVELING LEGS.

PROVIDE MANUFACTURER'S 18 INCH WALL SLEEVE. 8. OUTDOOR AIR FAN SHALL RUN CONTINUOUSLY TO PROVIDE CODE REQUIRED OUTDOOR AIR.

							ווח	CTLES	192 22	IT HEAT	Γ PUMP :	SCHE	בווום:	=										
							טט	CILL			i i Oivii ,		.DOLL	_										
	LOCATIO	N	BASIS	OF DESIGN	IND	OOR UNIT DATA							OUTD	OOR UN	IIT DATA							ELECTRICA	AL DATA	
								FAN			COOLIN	G DATA	١			HEATING DA	ΛTA		UNIT					
				MODEL NO. (INDOOR/		REFRIGERANT	MAX	POWER		NOMINAL	MINIMUM	EAT	EAT	LAT	NOMINAL	MINIMUM	EAT	LAT(d	WEIGHT	EER (@	COP (@		NO. OF	
ID	NAME	NO.	MANUFACTURER	OUTDOOR)	MOUNTING TYPE	TYPE	CFM	(W)	ID	(BTUH)	(BTUH)	(db °F)	(wb °F)	(db)	(BTUH)	(BTUH)	(db °F)	b) `	(LBS)	AHRI)	47°F)	VOLTAGE	POLES	REMARKS
DSS-1	KITCHEN	102	MITSUBISHI	TPLA0A0241EA70B / TRUZA0241KA70BA	CASSETTE	R32	665	46.0	DSCU-1	24000	10000	93.2	77.8	55.0	17400	14900	33.7	85.0	155	14.3	4.3	208	2	ALL
DSS-2	KITCHEN	102	MITSUBISHI	TPLA0A0241EA70B / TRUZA0241KA70BA	CASSETTE	R32	665	46.0	DSCU-2	24000	10000	93.2	77.8	55.0	17400	14900	33.7	85.0	155	14.3	4.3	208	2	ALL

#### REMARKS:

1. DISCONNECT PROVIDED BY ELECTRICAL FOR OUTDOOR UNIT.

2. SINGLE POINT POWER FROM OUTDOOR UNIT. INDOOR UNIT MUST BE INTERLOCKED WITH ASSOCIATED OUTDOOR UNIT.

3. PROVIDE MANUFACTURER'S 7-DAY PROGRAMMABLE THERMOSTAT WITH DIGITAL MODULE.

4. PROVIDE MANUFACTURER'S STANDARD EQUIPMENT STAND FOR OUTDOOR UNIT.

5. PROVIDE MANUFACTURER'S HAIL GUARD. 6. PROVIDE CONDENSATE PUMP WITH RESERVOIR AND OVERFLOW SENSOR FOR INDOOR UNIT.

7. PROVIDE MANUFACTURER'S CEILING GRILLE PANEL.

8. PROVIDE MANUFACTURER'S SEACOAST PACKAGE.

9. FOR EQUIPMENT PROCURED ON OR AFTER JANUARY 1, 2025, THE SYSTEM REFRIGERANT MUST HAVE A GLOBAL WARMING POTENTIAL (GWP) LESS THAN OR EQUAL TO 700 IN ACCORDANCE WITH THE AMERICAN INNOVATION AND MANUFACTURING (AIM) ACT (ADOPTED DECEMBER 27, 2020) AS PART OF THE CODE OF FEDERAL REGULATIONS (CFR).

					EXHAUS	T FAN SC	HEDIII								
						I I AN SC	ILDOLI								
	LOCATION			BASIS OF D	ESIGN			F.	AN DATA				ELECTRICA	AL DATA	
										MOTO	)R	UNIT			
							<b>AIRFLOW</b>	ESP (IN.	DRIVE	POWER		WEIGHT		NO. OF	
ID	NAME	NO.	SERVICE	MANUFACTURER	MODEL NO.	TYPE	(CFM)	WG.)	TYPE	(HP)	RPM	(LBS)	VOLTAGE	POLES	REMARKS
EF-1	CORRIDOR	103	RESTROOM EXHAUST	GREENHECK	SQ-95-VG	INLINE FAN	605	0.50	DIRECT	0.25	1688	47	120	1	1,2, 5, 6
EF-2	APARTMENT	16	KITCHEN HOOD	GREENHECK	CUE-095-VG	SIDEWALL	800	0.50	DIRECT	0.2	1723	33	120	1	1-7
			EXHAUST												

## **REMARKS**:

1. PROVIDE MANUFACTURER'S STARTER.

2. DISCONNECT PROVIDED BY ELECTRICAL.

3. PROVIDE HINGED CURB CAP AND GREASE COLLECTION BOX. COORDINATE HINGE LOCATION WITH POWER FEED TO ALLOW FULL RANGE OF HINGE.

4. PROVIDE WALL HOUSING WITH OSHA-COMPLIANT GUARD.

5. FAN SHALL RUN CONTINUOUSLY DURING OCCUPIED HOURS.

6. PROVIDE INTEGRAL BACKDRAFT DAMPER. 7. UNIT MUST BE HIGH-WIND RATED. PROVIDE BRACING CABLES DESIGNED FOR EXPOSURE CATEGORY AND BASIC WIND SPEEDS INDICATED IN PROJECT

SPECIFICATIONS.

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**EOR/AOR SEAL** 

CONSULTANT

**CLIENT INFORMATION** 

US Fish & Wildlife Service

PROJECT NAME

Cameron Prairie National Wildlife Refuge Bunkhouse

Bell City, LA 70630

**DRAWING ISSUE** 

DESIGNED BY: S. THOMAS

CHECKED BY: J. LEDYARD SUBMITTED BY: C. CUSICK 02/12/2024 PROJECT #: 1220834

DRAWN BY: S. THOMAS

SHEET TITLE

**MECHANICAL** SCHEDULES

SHEET NUMBER

					DEDIC	ATED O	UTDOOR A	IR SYST	TEM C	X CO	OLING	AND ELECT	RIC HEATING	S SCHEE	DULE									
															PRIMAR'	Y HEAT PUMP								
	LOCATION	N BASIS OF	DESIGN		SUPF	LY FAN DA	TA	DX COO	LING CC	OIL DATA	4		HOT GAS REHEAT	COIL DATA		DATA	SECONDA	RY HEAT	「DATA	FILTER		ELECTRICA	AL DATA	
					DESIGN	ESP POWI	ER CA	PACITY			FACE										UNIT	1		
					AIRFLOW			SENSIBLE	LAT	LAT	VELOCITY	REFRIGERANT		LAT (db	CAPACITY	EAT LAT	CAPACITY	EAT	LAT	EFF	WEIGHT	I	NO. OF	
ID	NAME	NO. MANUFACTURER	MODEL NO.	TYPE	(CFM)	WG.) (HP	) RPM (BTUH)	(BTUH)	(db °F)	(wb °F)	(FPM)	TYPE	CAPACITY (MBH)	°F)	(BTUH)	(db °F) (db °F	) (kW)	(db °F)	(db °F)	(MERV)	(LBS)	VOLTAGE	POLES	REMARKS
DOAS-1	OUTSIDE	- GREENHECK	RV-25-15A-1-F1	AIR SOURCE HEAT PUMP	2150	1.00 1	1150 192800	97700	52.0	52.0	173	R410A	59.200	77.5	123300.0	33.7 86.8	12.3	86.8	104.9	13	2652	208	3	ALL

#### **REMARKS:**

1. PROVIDE MANUFACTURER'S MOTOR CONTROLLER.

2. DISCONNECT PROVIDED BY ELECTRICAL.

3. SINGLE POINT POWER.

4. SHALL RUN CONTINUOUSLY WHILE BUILDING IS OCCUPIED.

5. PROVIDE NEMA PREMIUM EFFICIENCY MOTOR.

6. PROVIDE VIBRATION ISOLATION FOR FAN SECTION. 7. PROVIDE INTEGRAL BASE RAIL FRAME, MINIMUM 4 INCH HEIGHT.

8. PROVIDE MANUFACTURER'S STANDARD COIL DRAIN PAN IN COMPLIANCE WITH ASHRAE 62.1.

9. UNIT CASING MUST BE DOUBLE WALL WITH INTERNAL INSULATION AND WITH MAXIMUM 1% LEAKAGE

10. PROVIDE FACTORY-APPLIED ANTI-CORROSION COATING ON CONDENSER COILS FOR SEACOAST ENVIRONMENT.

11. PROVIDE MODULATING SILICON-CONTROLLED RECTIFIER (SCR) ELECTRIC HEATER CONTROL. 12. PROVIDE UNIT WITH FACTORY WIRED MARINE LIGHTS AND SWITCH IN FAN SECTION.

13. UNIT MUST BE HIGH-WIND RATED. PROVIDE BRACING CABLES DESIGNED FOR EXPOSURE CATEGORY AND BASIC WIND SPEEDS INDICATED IN PROJECT SPECIFICATIONS. 14. PROVIDE SUPPLY DUCT SMOKE DETECTOR.

15. FOR EQUIPMENT PROCURED ON OR AFTER JANUARY 1, 2025, THE SYSTEM REFRIGERANT MUST HAVE A GLOBAL WARMING POTENTIAL (GWP) LESS THAN OR EQUAL TO 700 IN ACCORDANCE WITH THE AMERICAN

INNOVATION AND MANUFACTURING (AIM) ACT (ADOPTED DECEMBER 27, 2020) AS PART OF THE CODE OF FEDERAL REGULATIONS (CFR). 16. PROVIDE MANUFACTURER'S LOCAL CONTROLS OPTION WITH 24 HOUR 7 DAY PROGRAMMABLE SPACE HUMIDITY AND TEMPURATURE SENSOR. ENSURE FULL UNITS FULL SEQUENCE OF OPERATIONS ARE AVAILABLE

WITH LOCAL CONTROLS OPTION.

					LOU	JVER SC	HEDULE								
	LOCATION		BASIS OF D	ESIGN				DESIGN	FREE	FREE AREA	MAX	DIMEN	SIONS	UNIT	
								AIRFLOW	AREA	VELOCITY	PRESSURE			WEIGHT	
ID	NAME	NO.	MANUFACTURER	MODEL NO.	SERVES	SYSTEM	MATERIAL	(CFM)	(SF)	(FPM)	DROP (IN. WG.)	WIDTH	HEIGHT	(LBS)	REMARKS
L-1	APARTMENT	108	GREENHECK	ESD-635X	KITCHEN HOOD EXHAUST	EXHAUST	ALUMINUM	400	0.9	437	0.03	2' - 0"	1' - 4"	10	ALL
L-2	APARTMENT	116	GREENHECK	ESD-635X	KITCHEN HOOD EXHAUST	EXHAUST	ALUMINUM	400	0.9	437	0.03	2' - 0"	1' - 4"	10	ALL

1. HURRICANE-RATED TYPE.

2. AMCA 500-L LICENSED FOR AIR PERFORMANCE, WATER PENETRATION, AND WIND DRIVEN RAIN.

3. AMCA 540 LICENSED FOR WIND-BORNE DEBRIS IMPACT RESISTANCE.

4. AMCA 550 LICENSED FOR HIGH-VELOCITY WIND-DRIVEN RAIN RESISTANCE.

5. FINISH TO BE SELECTED BY ARCHITECTURAL. PROVIDE MANUFACTURER'S COLOR WHEEL WITH SUBMITTAL PACKAGE.

6. PROVIDE BIRDSCREEN. SCREEN MUST BE CONTAINED WITHIN A REMOVABLE FRAME.

				AIR TERMINALS	SCHEDU	JLE					
	BASIS OF	DESIGN						BORDER	FINISH	DESIGN	
TAG	MANUFACTURER	MODEL	SYSTEM	DESCRIPTION	MOUNTING	FACE SIZE	MATERIAL	TYPE	COLOR	NC	REMARKS
E1	TITUS	50F	EXHAUST	EGGCRATE GRILLE	CEILING	VARIES	ALUMINUM	LAY-IN	WHITE	25	ALL
S1	TITUS	TMS-AA	SUPPLY	THREE CONE DIFFUSER	CEILING	24" X 24"	ALUMINUM	LAY-IN	WHITE	25	ALL
S2	TITUS	XG-5500S-FRS	SUPPLY	THREE CONE DIFFUSER	CEILING	24" X 24"	ALUMINUM	LAY-IN	WHITE	25	ALL
T1	TITUS	50F	EXHAUST	EGGCRATE GRILLE	CEILING	VARIES	ALUMINUM	LAY-IN	WHITE	25	ALL
T2	TITUS	XG-7550DF-FRS	EXHAUST	EGGCRATE GRILLE	CEILING	VARIES	ALUMINUM	LAY-IN	WHITE	25	ALL

1. WHERE COLOR LISTED IN AIR TERMINAL SCHEDULE CONFLICTS WITH COLOR LISTED IN INTERIOR DESIGN OR ARCHITECTURAL SHEETS,

SPECIFICATION FROM INTERIOR DESIGNER OR ARCHITECT MUST TAKE PRECEDENCE.

2. PROVIDE MOUNTING HARDWARE/FRAME FOR DIFFUSERS AND GRILLES TO MATCH CEILING TYPE. 3. PROVIDE INLET DAMPER WITH REMOTE CABLE OPERATOR. LOCATE OPERATOR IN CEILING NEAR DIFFUSER.

4. PROVIDE UL CLASSIFIED FIRE-RATED ASSEMBLY WITH INTEGRAL CEILING RADIATION DAMPER.

						DEHUM	IIDIFIER S	CHEDULE	<b>=</b>						
	LOCATION	1	BASIS OF DE	SIGN			<b>EXTRACTION</b>	<b>EXTRACTION</b>	DIN	MENSIO	NS		ELECTRIC	AL DATA	
					MAX		AT 80°F /	AT 73°F /				UNIT			
				MODEL	OPERATING	AIRFLOW	60% RH	60% RH				WEIGHT		NO. OF	
ID	NAME	NO.	MANUFACTURER	NO.	TEMP (°F)	(CFM)	(PPD)	(PPD)	LENGTH	WIDTH	HEIGHT	(LBS)	VOLTAGE	POLES	REMARKS
DH-1	LIVING ROOM	100	APRILAIRE	E130	140	310	130	105	2' - 6"	1' - 7"	1' - 6"	110	120	1	ALL

DISCONNECT PROVIDED BY ELECTRICAL.

PROVIDE MANUFACTURER'S STANDARD CONTROL FEATURES INCLUDING (BUT NOT LIMITED TO): ELECTRONIC DEFROST, ADJUSTABLE HUMIDISTAT, HOT GAS DEFROST SYSTEM.

					ROO	F HOC	D SC	HEDULE						
					1100	1 1100	<i>,</i> D 00							
	BASIS OF DE	ESIGN			THROAT	THROAT	MAX			DIME	ENSIONS		UNIT	
				AIRFLOW	_	AREA	PD (IN.		THRO	DAT	CUF	RB	WEIGHT	
ID	MANUFACTURER	MODEL NO.	TYPE	(CFM)	(FPM)	(ft^2)	WĠ.)	DAMPER TYPE	LENGTH	WIDTH	LENGTH	WIDTH	(LBS)	REMARKS
RH-1	GREENHECK	FGR-10x10	EXHAUST	605	872	1.0	0.18	BACKDRAFT	2' - 3"	2' - 0"	1' - 4"	1' - 4"	37	ALL

1. PROVIDE ROOF CURB TO MATCH ROOF SLOPE.

2. PROVIDE BIRD SCREEN.

3. PROVIDE INTEGRAL GRAVITY BACKDRAFT DAMPER.

4. HIGH-WIND RATED ASSEMBLY.

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US Fish & Wildlife Service

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Bell City, LA 70630

**DRAWING ISSUE** 

DESIGNED BY: S. THOMAS DRAWN BY: S. THOMAS CHECKED BY: J. LEDYARD SUBMITTED BY: C. CUSICK 02/12/2024 PROJECT #: 1220834

SHEET TITLE

**MECHANICAL** SCHEDULES

SHEET NUMBER

#### NOTES:

**PROJECT** 

1. ALL EXISTING EQUIPMENT IS SHOWN IN THIN LINEWORK. ALL DEMOLISHED EQUIPMENT IS SHOWN IN BOLD LINEWORK, DASHED AND HATCHED. ALL NEW OR RELOCATED EQUIPMENT IS SHOWN IN BOLD LINEWORK. BELOW IS AN EXAMPLE OF EACH:

**EXISTING EQUIPMENT** 

NEW OR RELOCATED EQUIPMENT

□ ✓ HATCH INDICATES EQUIPMENT TO BE DEMOLISHED

#### WIRE SIZE FOR ALL 120V, 20A CIRCUITS, UIO:

FOR ALL ONE-WAY CIRCUITS OF LENGTH LESS THAN 75 FT, PROVIDE 2#12 & 1#12G, 3/4"C.

FOR ALL ONE-WAY CIRCUITS OF LENGTH LESS THAN 125 FT AND GREATER THAN OR EQUAL TO 75 FT, PROVIDE 2#10 & 1# 10G, 3/4"C.

FOR ALL ONE-WAY CIRCUITS OF LENGTH LESS THAN 190 FT AND GREATER THAN OR EQUAL TO 125 FT, PROVIDE 2#8 & 1#8G, 3/4"C.

FOR ALL ONE-WAY CIRCUITS OF LENGTH LESS THAN 300 FT AND GREATER THAN OR EQUAL TO 190 FT, PROVIDE 2#6 & 1#6G, 3/4"C. PROVIDE CABLE REDUCING ADAPTER PRIOR TO TERMINATION INTO CIRCUIT BREAKER AS NECESSARY.

#### **ELECTRICAL GENERAL NOTES**

- 1. THE WORK MUST CONFORM WITH ALL REQUIREMENTS OF: A. NFPA 70-2020 (NATIONAL ELECTRICAL CODE) WITH AMENDMENTS
- B. INTERNATIONAL BUILDING CODE (IBC), 2021 AMENDMENTS C. INTERNATIONAL ENERGY CONSERVATION CODE (IECC), 2009
- D. APPLICABLE LOCAL CODES AND FEDERAL AND STATE LAWS.
- 2. MINIMUM RACEWAY SIZE MUST BE 3/4". INCREASE RACEWAY SIZE AS REQUIRED TO LIMIT RACEWAY FILL RATIO TO LESS THAN 40% FULL.
- 3. CONTRACTOR MUST COORDINATE WORK WITH OTHER TRADES AND MUST BE RESPONSIBLE FOR SECURING SPACE REQUIREMENTS FOR ELECTRICAL EQUIPMENT, CLEARANCE FOR RECESSED LUMINAIRES, AND CORRECT ROUGH-IN LOCATIONS OF ELECTRICAL CONNECTIONS.

TOP OF BACKSPLASH. IF NO BACKSPLASH IS USED, LOCATE BOTTOM OF OUTLET BOX 6" ABOVE COUNTERTOP.

- 4. CONTRACTOR MUST BE RESPONSIBLE FOR VERIFYING CATALOG NUMBERS ON THESE DRAWINGS TO MATCH WITH MATERIAL DESCRIPTIONS INDICATED.
- 5. VERIFY EXACT HEIGHT OF EACH COUNTERTOP AND BACKSPLASH ON ARCHITECTURAL DETAILS AND/OR CASE WORK SHOP DRAWINGS AND ADJUST SPECIFIED MOUNTING HEIGHT OF WALL OUTLETS TO LOCATE BOTTOM OF OUTLET BOX 4" ABOVE
- 6. VERIFY DOOR SWINGS WITH ARCHITECTURAL DRAWINGS BEFORE ROUGHING IN WALL SWITCHES. SWITCHES IN THE SAME LOCATION MUST BE GANGED TOGETHER IN ONE COMMON BACKBOX AND MUST HAVE ONE COMMON FACE PLATE.
- 7. ALL FEEDERS AND BRANCH CIRCUITS MUST INCLUDE A GREEN INSULATED EQUIPMENT GROUNDING CONDUCTOR, SIZE PER NATIONAL ELECTRICAL CODE, OR AS SHOWN, CONNECTED TO EACH DEVICE AND OUTLET BOX ON THE CIRCUIT AND TO THE PANELBOARD GROUND BUS. PROVIDE NEUTRAL CONDUCTORS AS INDICATED HEREIN. MULTIPLE BRANCH CIRCUITS IN ONE RACEWAY REQUIRE ONLY ONE EQUIPMENT GROUNDING CONDUCTOR.
- 8. VERIFY LUMINAIRE AND CEILING MOUNTED OCCUPANCY SENSOR LOCATIONS WITH ARCHITECTURAL REFLECTED CEILING PLANS FOR EXACT LOCATIONS AND DIMENSIONS PRIOR TO INSTALLATION. VERIFY EXACT LOCATIONS OF MOTORS AND EQUIPMENT BEFORE ROUGHING-IN.
- 9. EXISTING ELECTRICAL WORK (NOT SHOWN) MUST REMAIN, UNLESS INDICATED OTHERWISE. SHOULD ANY EXISTING ELECTRICAL POWER, LIGHTING OR AUXILIARY CIRCUIT, FEEDER OR EQUIPMENT BE SEVERED, DISCONNECTED OR DEMOLISHED IN THE PROCESS OF CONSTRUCTION OR REMODELING WHICH IS DONE AS A RESULT OF CONTRACT PLANS AND SPECIFICATIONS, AND UNLESS SPECIFICALLY DESIGNATED BY THE DRAWINGS TO BE DEMOLISHED, THEN SAID CIRCUIT OR FEEDER MUST BE RESTORED TO WORKING CONDITION. THE RESTORATION MUST INCLUDE RE-ROUTING, RELOCATION, RECONNECTION OR REPLACEMENT AS MAY BE REQUIRED BY THE NEW WORK. ANY SUCH WORK REQUIRED MUST BE INCLUDED IN THE CONTRACT AT NO ADDITIONAL COST TO THE OWNER.
- 10. NEW WORK MUST BE MADE TO TIE INTO THE EXISTING IN A UNIFORM MANNER. SIMILAR ITEMS OF NEW WORK MUST BE CHECKED AGAINST EXISTING WORK FOR TYPE MOUNTING, MOUNTING HEIGHTS, ETC. ITEMS SHOWN IN NEW WORK AT VARIANCE FROM THE EXISTING MUST BE REFERRED TO THE ARCHITECT FOR DECISION BEFORE ROUGH-IN.
- 11. REFER TO ONE-LINE DIAGRAMS, SCHEDULES AND RISER DIAGRAMS FOR CONDUCTOR AND CONDUIT SIZES NOT SHOWN ON PLANS.
- 12. PROVIDE IS AN INCLUSIVE TERM USED TO DESCRIBE ASPECTS OF THE WORK THAT MUST BE ACCOMPLISHED, AND IS HEREBY DEFINED TO REQUIRE TO STORE, FURNISH, INSTALL, MOUNT, CONNECT, CONTROL AND POWER EQUIPMENT INDICATED, AS WELL AS ALL APPURTENANCES REQUIRED TO MAKE ELECTRICAL SYSTEMS OPERATE AS INDICATED WITHIN THESE DRAWINGS AND SPECIFICATIONS AND TO FULFILL THE SCOPE OF WORK.
- 13. DEMOLISH IS AN INCLUSIVE TERM USED TO DESCRIBE ASPECTS OF THE WORK THAT MUST BE ACCOMPLISHED, AND IS HEREBY DEFINED TO REQUIRE CONTRACTOR TO DISCONNECT EQUIPMENT FROM ALL CONNECTIONS, REMOVE FROM THE OWNER'S SITE, AND DISPOSE OF IN ACCORDANCE WITH FEDERAL, STATE AND LOCAL LAWS AND ORDINANCES. COST OF DISPOSAL IS ENTIRELY THE CONTRACTOR'S RESPONSIBILITY.
- 14. ALL CONDUCTORS MUST BE COPPER UNLESS SPECIFICALLY NOTED AS ALUMINUM
- 15. CONTRACTOR MUST FIELD VERIFY ALL EXISTING CONDITIONS, DIMENSIONS AND ELEVATIONS BEFORE PROCUREMENT OF ANY MATERIALS AND DEVELOPMENT OF ANY SHOP DRAWINGS OR SUBMITTALS.
- 16. PROVIDE LABELS ON ALL RECEPTACLES, WALL MOUNTED LIGHT SWITCHES/OCCUPANCY SENSORS AND JUNCTION BOXES INDICATING THE SOURCE PANEL & CIRCUIT(S). HANDWRITTEN LABELS ARE NOT PERMITTED EXCEPT FOR JUNCTION BOXES LOCATED ABOVE FINISHED CEILING WHICH MAY BE HANDWRITTEN WITH AN INDELIBLE MARKER.
- 17. ALL EQUIPMENT PADS FOR INTERIOR ELECTRICAL EQUIPMENT MUST EXTEND 2" BEYOND THE FOOTPRINT OF THE EQUIPMENT. EQUIPMENT PADS FOR EXTERIOR ELECTRICAL EQUIPMENT MUST EXTEND 6" BEYOND THE FOOTPRINT OF THE

#### **ELECTRICAL ABBREVIATIONS**

A or AMP	AMPERE(S)	HZ	HERTZ
AC	AIR COMPRESSOR or AIR CURTAIN or	IDS IMC	INTRUSION DETECTION SYSTEM
ACC	ALTERNATING CURRENT AIR COOLED CHILLER	IRH	INTERMEDIATE METAL CONDUIT INFRARED HEATER
AF	AMP FRAME	J OR JB	JUNCTION BOX
AFF	ABOVE FINISHED FLOOR	K	KILO
AFG	ABOVE FINISHED GRADE	KAIC	THOUSAND AMPERE INTERRUPTING CAPACITY
AHU	AIR HANDLING UNIT	KCMIL	THOUSAND OF CIRCULAR MILS
AIC	AMPERE INTERRUPTING CAPACITY	KEF	KITCHEN EXHAUST FAN
AL	ALUMINUM	KH	KITCHEN HOOD
AM	AMMETER	KK	KIRK KEY INTERLOCK
ASYM	ASYMMETRICAL	KV	KILOVOLT
ATC	AMP TRIP	KVA	KILOVOLT AMPERES REACTIVE
ATS AUTO	AUTOMATIC TRANSFER SWITCH AUTOMATIC	KVAR KW	KILOVOLT AMPERES REACTIVE KILOWATT
AWG	AMERICAN WIRE GAUGE	KWHR	KILOWATT KILOWATT-HOUR
В	BOILER	L	LENGTH
ВС	BRANCH CONTROLLER	LA	LIGHTNING ARRESTOR
BCW	BARE COPPER WIRE	LAN	LOCAL AREA NETWORK
BFF	BELOW FINISHED FLOOR	LAV	LAVATORY
BFG	BELOW FINISHED GRADE	LS	LONG TIME, SHORT TIME
BLDG C	BUILDING	LSI	LONG TIME, SHORT TIME & INSTANTANEOUS
CAT	CONDUIT CATEGORY	LSIG	LONG TIME, SHORT TIME, INSTANTANEOUS & GROUND FAULT
CB	CIRCUIT BREAKER	LTG	LIGHTING
CCT	CORRELATED COLOR TEMPERATURE	MAU	MAKE-UP AIR UNIT
CCTV	CLOSED CIRCUIT TELEVISION	MAX	MAXIMUM
CFCI	CONTRACTOR FURNISHED CONTRACTOR	MCA	MINIMUM CIRCUIT AMPACITY
	INSTALLED	MCB	MAIN CIRCUIT BREAKER
CHIMCB	CHILLER WATER CIRCUITATING BUMB	MCC MCB	MOTOR CONTROL CENTER
CHWCP CHWP	CHILLED WATER CIRCULATING PUMP CHILLED WATER PUMP	MGB MH	MAIN GROUND BAR MANHOLE
CHWSP	CHILLED WATER PUMP CHILLED WATER SUPPLY PUMP	MIN	MINIMUM
CKT	CIRCUIT	MLO	MAIN LUGS ONLY
CMH	COMMUNICATIONS MANHOLE	MOD	
CP	CONDENSATE PUMP	MRS	MOTOR RATED SWITCH
CPT	CONTROL POWER TRANSFORMER	MT or MTD	
CRAC	COMPUTER ROOM AC UNIT	MTS	MANUAL TRANSFER SWITCH
CRI CT	COLOR RENDERING INDEX CURRENT TRANSFORMER or COOLING TOWER	N N/A	NEUTRAL NOT APPLICABLE
CU	COPPER COPPER	NC NC	NOT APPLICABLE NORMALLY CLOSED
CWP	CONDENSER WATER PUMP	NEC	NATIONAL ELECTRICAL CODE
D	DEPTH	NEMA	NATIONAL ELECTRICAL MANUFACTURER'S
DC	DIRECT CURRENT		ASSOCIATION
DF	DESTRATIFICATION FAN	NESC	NATIONAL ELECTRICAL SAFETY CODE
DH	DUCT HEATER OF DEHUMIDIFIER	NFPA	NATIONAL FIRE PROTECTION ASSOCIATION
DHWCP DISC	DOMESTIC HOT WATER CIRCULATING PUMP DISCONNECT SWITCH	NL NO	NIGHT LIGHT NORMALLY OPEN
DOAS		NTS	NOT TO SCALE
DPDT		P	POLE(S) or PUMP
DPST		PA	PUBLIC ADDRESS
DSCU	DUCTLESS SPLIT CONDENSING UNIT	PDU	POWER DISTRIBUTION UNIT
DSHP	DUCTLESS SPLIT HEAT PUMP	PF	POWER FACTOR
DSS	DUCTLESS SPLIT SYSTEM (INDOOR UNIT)	PH	PHASE
DUH DWBP		PIU PMT	PRIMARY INDUCTION UNIT (VAV TERMINAL UNIT) PAD MOUNTED TRANSFORMER
DX	DIRECT EXPANSION COOLING COIL	PNL	PANEL OR PANELBOARD
E or EMER	EMERGENCY	PTAC	PACKAGED THRU-WALL AIR CONDITIONER
EC	EMPTY CONDUIT	PVC	POLYVINYL CHLORIDE
EF	EXHAUST FAN	RECP	RECEPTACLE
ELEC EMEW	ELECTRICAL EMERGENCY EYEWASH	RF RH	RETURN FAN RADIANT HEATERS (ELECTRIC)
EMH	ELECTRICAL MANHOLE	RMC	RIGID METAL CONDUIT
EMSH	EMERGENCY SHOWER	RMS	ROOT MEAN SQUARE
EMT	ELECTRICAL METALLIC TUBING	RTU	ROOF TOP UNIT
EPA	EFFECTIVE PROJECTED AREA	RVNR	REDUCED VOLTAGE NON-REVERSING
EQUIP	EQUIPMENT	SA	SURGE ARRESTOR
ERU	ENERGY RECOVERY UNIT	SBB	SECONDARY BONDING BAR
ERV ESEW	ENERGY RECOVERY VENTILATOR EMERGENCY SHOWER / EYEWASH	SCCR SD	SHORT CIRCUIT CURRENT RATING SMOKE DAMPER
EUH	ELECTRIC UNIT HEATER	SF	SWOKE DAMPER SUPPLY FAN
EWC	ELECTRIC WATER COOLER	S/N	SOLID NEUTRAL
EWH	ELECTRIC WATER HEATER	SP	SUMP PUMP
EX or EXIST		SPD	SURGE PROTECTIVE DEVICE
EXP	EXPLOSION PROOF	SPDT	SINGLE POLE DOUBLE THROW
F EACD	FUSE FIRE ALARM CONTROL PANEL	SPEC SPST	SPECIFICATIONS SINGLE POLE SINGLE THROW
FACP FCU	FIRE ALARM CONTROL PANEL FAN COIL UNIT	SPST SWBD	SINGLE POLE SINGLE THROW SWITCHBOARD
FLEX		SWGR	SWITCHBOARD
FWE	FURNISHED WITH EQUIPMENT	TMGB	TELECOMMUNICATIONS MAIN GROUNDING
G or GND	GROUND		BUSBAR
GFCI	GROUND FAULT CIRCUIT INTERRUPTER	TOL	THERMAL OVERLOAD
GUH	GAS UNIT HEATER	TP TVD	TWISTED PAIR
GWH	GAS WATER HEATER	TYP U	TYPICAL URINAL
H or HT HAC	HEIGHT HEATED AIR CURTAIN	U UG	UNDERGROUND
HOA	HAND-OFF AUTOMATIC	UH	UNIT HEATER
HP	HORSE POWER or HEAT PUMP	UIO	UNLESS INDICATED OTHERWISE
HT	HEAT TRACKING	UL	UNDERWRITERS LABORATORY
HVU	HEATING/VENTILATING UNIT	UTP	UNSHIELDED TWISTED PAIR
HWCP		V	VOLTS
HWP HWPD	HEATING WATER PUMP	VA VAR	VOLT AMPERES VOLT AMPERES REACTIVE
HWRP HWSP	HOT WATER RECIRCULATION PUMP HEATING WATER SUPPLY PUMP	VAR VAV	VOLT AMPERES REACTIVE VAV TERMINAL UNIT
HWUH	HOT WATER SUPPLY POMP	VAV VEF	VAV TERMINAL ONT VEHICLE EXHAUST FAN
• • • •		VM	VOLTMETER
		VRF	VARIABLE REFRIGERANT FLOW SYSTEM
		W	WATTS or WIRE
		WC	WATER CLOSET
		WEF	WELDING EXHAUST FAN
		WH WHDM	WATER HEATER WATTHOUR DEMAND METER
		WP	WEATHERPROOF
		WSHP	WATER SOURCE HEAT PUMP
		XFMR	TRANSFORMER
		7	IMPEDANCE

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**CLIENT INFORMATION** 



US Fish & Wildlife Service

**PROJECT NAME** 

Cameron Prairie National Wildlife Refuge Bunkhouse

> LA-27 Bell City, LA 70630

**DRAWING ISSUE** 

DESIGNED BY: J. REYES J. REYES

DRAWN BY: CHECKED BY: J. WILLIAMS SUBMITTED BY: C. CUSICK 02/12/2024

PROJECT #: 1220834 **SHEET TITLE** 

**ELECTRICAL GENERAL NOTES** AND **ABBREVIATIONS** 

**SHEET NUMBER** E-001

ORIGINAL SHEET SIZE:

24" X 36"

**IMPEDANCE** 

COAXIAL CABLE TELEVISION OUTLET WALL MOUNTED 60" ABOVE FINISHED FLOOR, UNLESS INDICATED OTHERWISE

COMMUNICATIONS COMBINATION VOICE/DATA OUTLET MOUNT 18" ABOVE FINISHED FLOOR. UNLESS INDICATED OTHERWISE

COMMUNICATIONS VOICE OUTLET MOUNT 48" ABOVE FINISHED FLOOR, UNLESS INDICATED OTHERWISE

COMMUNICATIONS DATA OUTLET, MOUNT 18" ABOVE

FINISHED FLOOR, UNLESS INDICATED OTHERWISE

**WIRELESS ACCESS POINT** 

**ELECTRICAL LEGEND LUMINAIRES** LUMINAIRE AND OUTLET BOX. LETTER INDICATES LUMINAIRE TYPE. SEE LUMINAIRE SCHEDULE. LUMINAIRE AND OUTLET BOX WIRED FOR MULTILEVEL SWITCHING, LOWER CASE LETTER INDICATES SWITCHLEG DESTINATION.  $igspace\longrightarrow$  LUMINAIRE AND OUTLET BOX, WITH PROVISIONS FOR EMERGENCY LIGHTING. LETTER INDICATES AE AE LUMINAIRE TYPE. SEE LUMINAIRE SCHEDULE. WALL MOUNTED LUMINAIRE AND OUTLET BOX. LETTER INDICATES LUMINAIRE TYPE. SEE LUMINAIRE SCHEDULE. CEILING OR WALL MOUNTED EXIT SIGN AND OUTLET BOX. PROVIDE NUMBER OF ARROWS AND FACES INDICATED. LETTER INDICATES LUMINAIRE TYPE. SEE LUMINAIRE SCHEDULE. WALL MOUNT AT 96" ABOVE FINISHED FLOOR.  $\mathsf{C} \circ \square \mathsf{C}$ RECESSED OR PENDANT MOUNTED LUMINAIRE AND OUTLET BOX. LETTER INDICATES

LUMINAIRE TYPE. SEE LUMINAIRE SCHEDULE.

WALL MOUNTED LUMINAIRE AND OUTLET BOX. LETTER INDICATES LUMINAIRE TYPE. SEE LUMINAIRE SCHEDULE.

CEILING OR WALL MOUNTED LUMINAIRE AND OUTLET BOX WITH PROVISIONS FOR **EMERGENCY LIGHTING. LETTER INDICATES** LUMINAIRE TYPE. SEE LUMINAIRE SCHEDULE.

EMERGENCY LIGHT UNIT. LETTER INDICATES LUMINAIRE TYPE. SEE LUMINAIRE SCHEDULE. REMOTE HEAD OR FLOOD LUMINAIRE. LETTER INDICATES LUMINAIRE TYPE. SEE LUMINAIRE

SCHEDULE. WALL WASH DOWNLIGHT. LETTER INDICATES LUMINAIRE TYPE. SEE LUMINAIRE SCHEDULE.

POLE MOUNTED LUMINAIRE. LETTER INDICATES LUMINAIRE TYPE. SEE LUMINAIRE SCHEDULE.

POST-TOP OR BOLLARD LUMINAIRE. LETTER INDICATES LUMINAIRE TYPE. SEE LUMINAIRE SCHEDULE.

**EQUIPMENT** 

MOTOR, HORSEPOWER AS INDICATED

MOTORIZED DAMPER

2/60/40/1 3-POLE COMBINATION MOTOR CONTROLLER/ DISCONNECT (POLES/FRAME SIZE/FUSE SIZE/NEMA ENCLOSURE) NF = NONFUSED

DISCONNECT SWITCH. (FRAME SIZE/FUSE SIZE/POLES/NEMA ENCLOSURE) NF = NON-60/40/3/3R FUSED

INDIVIDUALLY MOUNTED CIRCUIT BREAKER, (CIRCUIT BREAKER SIZE/ POLES/ NEMA ✓ 40/3/3R ENCLOSURE)

> MOTOR CONTROLLER MOUNTED 48" AFF. UNLESS OTHERWISE NOTED.

DRY TYPE TRANSFORMER SURFACE MOUNTED PANELBOARD. DASHED

BOX INDICATES WORKING ACCESS REQUIRED BY CODE. RECESSED MOUNTED PANELBOARD. DASHED **BOX INDICATES WORKING ACCESS REQUIRED** 

DISTRIBUTION PANELBOARD, DASHED BOX INDICATES WORKING ACCESS REQUIRED BY CODE.

EQUIPMENT AS INDICATED

BY CODE.

CEILING OR WALL MOUNTED JUNCTION BOX PULL OR JUNCTION BOX

CEILING MOUNTED BLUE LIGHT SYSTEM **ROTATING BEACON** 

> WHITE NOISE PLENUM SPEAKER; MOUNT ABOVE DROP CEILING

**CEILING FAN** 

**WIRING DEVICES** SIMPLEX RECEPTACLE NEMA 5-20R, MOUNT 18" ABOVE FINISHED FLOOR, UNLESS INDICATED

DUPLEX RECEPTACLE NEMA 5-20R. MOUNT 18" ABOVE FINISHED FLOOR, UNLESS INDICATED OTHERWISE

OTHERWISE.

DUPLEX RECEPTACLE, NEMA 5-20R, MOUNT 6" ABOVE COUNTERTOP (TO BOTTOM OF DEVICE) OR 4" ABOVE BACKSPLASH (TO BOTTOM OF DEVICE)

DUPLEX GROUND FAULT CIRCUIT INTERRUPTER RECEPTACLE NEMA 5-20R, MOUNT 18" ABOVE FINISHED FLOOR, UNLESS INDICATED OTHERWISE

DUPLEX GROUND FAULT CIRCUIT INTERRUPTER RECEPTACLE NEMA 5-20R, MOUNT 6" ABOVE COUNTERTOP (TO BOTTOM OF DEVICE) OR 4" ABOVE BACKSPLASH (TO BOTTOM OF DEVICE)

DOUBLE-DUPLEX RECEPTACLE NEMA 5-20R. MOUNT 18" ABOVE FINISHED FLOOR, UNLESS INDICATED OTHERWISE

SPLIT YOKE, DUPLEX RECEPTACLE NEMA 5-20R WITH ONE CONTROLLED AND ONE NON-CONTROLLED RECEPTACLE. MOUNT 18" ABOVE FINISHED FLOOR, UNLESS INDICATED OTHERWISE.

SPLIT YOKE, DUPLEX RECEPTACLE NEMA 5-20R WITH ONE CONTROLLED AND ONE NON-CONTROLLED RECEPTACLE. MOUNT 6" ABOVE COUNTERTOP (TO BOTTOM OF DEVICE) OR 4" ABOVE BACKSPLASH (TO BOTTOM OF DEVICE)

SPLIT YOKE, DUPLEX GROUND FAULT CIRCUIT INTERRUPTER RECEPTACLE NEMA 5-20R WITH ONE CONTROLLED AND ONE NON-CONTROLLED RECEPTACLE. MOUNT 18" ABOVE FINISHED FLOOR, UNLESS INDICATED OTHERWISE

SPLIT YOKE, DUPLEX GROUND FAULT CIRCUIT INTERRUPTER RECEPTACLE NEMA 5-20R, WITH ONE CONTROLLED AND ONE NON-CONTROLLED RECEPTACLE. MOUNT OR 6" ABOVE COUNTERTOP (TO BOTTOM OF DEVICE) OR 4" ABOVE BACKSPLASH (TO BOTTOM OF DEVICE)

DOUBLE-DUPLEX GROUND FAULT CIRCUIT INTERRUPTER RECEPTACLE, NEMA 5-20R, MOUNTED CONCEALED BEHIND ELECTRIC WATER COOLER

FLOOR BOX WITH DUPLEX RECEPTACLE NEMA 5-20R. PROVIDE FIRE RATED POKE-THROUGH DEVICES ON ALL FLOORS ABOVE GROUND LEVEL.

FLOOR RECEPTACLE NEMA 5-30R. PROVIDE FIRE RATED POKE-THROUGH DEVICES ON ALL FLOORS ABOVE GROUND LEVEL.

> SPECIAL RECEPTACLE, NEMA TYPE AS INDICATED, MOUNT 18" ABOVE FINISHED FLOOR, UNLESS INDICATED OTHERWISE

CEILING BOX WITH DUPLEX RECEPTACLE, NEMA 5-30R

CEILING BOX WITH DUPLEX RECEPTACLE, NEMA

RECEPTACLE WP = IN-USE WEATHER PROOF SUBSCRIPTS TR = TAMPER RESISTANT TV = TELEVISION, MOUNT AT 60" ABOVE

FINISHED FLOOR AFCI = ARC FAULT CIRCUIT INTERRUPTER M1 = PTAC (PACKAGED TERMINAL AIR CONDITIONER)

FLOOR BOX SUITABLE FOR CONCRETE FLOOR POUR: TWO COMPARTMENTS - POWER AND TELECOMMUNICATIONS; FLUSH COVER/FLANGE WITH HINGED ACCESS TO RECEPTACLES AND JACKS RECESSED BELOW COVER IN FLOOR BOX. PROVIDE 8" FIRE RATED POKE-THROUGH ABOVE GROUND FLOOR.

WALL SWITCH, AC TYPE, SPST, MOUNT 48" ABOVE FINISHED FLOOR WALL SWITCH, AC TYPE, DPDT, MOUNT 48"

ABOVE FINISHED FLOOR 3-WAY WALL SWITCH, MOUNT 48" ABOVE FINISHED FLOOR

WIRING DEVICES

FINISHED FLOOR SLIDE DIMMER. MOUNT 48" ABOVE FINISHED FLOOR

4-WAY WALL SWITCH, MOUNT 48" ABOVE

MOTOR RATED DISCONNECT SWITCH WITH THERMAL OVERLOADS. SINGLE POLE SINGLE THROW, MOUNT ON UNIT, UNLESS INDICATED OTHERWISE.

WALL MOUNTED, DUAL TECHNOLOGY OCCUPANCY SWITCH, MOUNT 48" ABOVE FINISHED FLOOR

WALL MOUNTED, DUAL TECHNOLOGY VACANCY SWITCH, MOUNT 48" ABOVE FINISHED FLOOR LOW VOLTAGE ON/OFF WALL SWITCH, WALL MOUNT 48" ABOVE FINISHED FLOOR, PROVIDE

INTEGRAL WITH SWITCH. BLUE LIGHT LOCAL CONTROL SWITCH; MOUNT 48" ABOVE FINISHED FLOOR, UNLESS INDICATED

DIMMER CONTROL WITH DIMMABLE FIXTURES

OTHERWISE WHITE NOISE ROTARY VOLUME CONTROL: MOUNT

48" ABOVE FINISHED FLOOR, UNLESS INDICATED

OTHERWISE. CEILING MOUNTED DUAL TECHNOLOGY OCCUPANCY SENSOR

CEILING MOUNTED DUAL TECHNOLOGY VACANCY SENSOR

(DS) CEILING MOUNTED DAYLIGHT SENSOR

PHOTOELECTRIC CELL

**WIRING** 

(PE)

CIRCUIT HOMERUN TO PANELBOARD. P2A-1,3,5, ADJACENT TO ARROW. INDICATES HOMERUN P2A-1.3.5 CIRCUITS 1, 3, AND 5 IN PANEL P2A. MARKS ACROSS RACEWAY INDICATE THE NUMBER OF PHASE CONDUCTORS AND NEUTRALS IN RACEWAY. NEUTRAL CONDUCTORS ARE INDICATED BY LONGER HASHMARKS. NO MARKS ACROSS RACEWAY INDICATES 2#12 CONDUCTORS AND 1#12 GROUND CONDUCTOR. CONDUCTOR SIZE #12 UNLESS INDICATED OTHERWISE.

P2A-2 (#10) ← PANEL, BRANCH CIRCUIT AND WIRE SIZE (IF OTHER THAN #12)

WP

RECEPTACLE TYPE IF APPLICABLE P2A-2 (#8) (SEE SHEET E-002 - WIRING DEVICES) PANEL BRANCH CIRCUIT AND WIRE SIZE (IF OTHER THAN #12)

A1 ← LUMINAIRE TYPE (SEE SHEET E-611) (IF OTHER THAN #12)

(IF OTHER THAN #12)

RACEWAY EXPOSED TO VIEW

CONCEALED RACEWAY, LOCATED IN WALL OR ABOVE FINISHED CEILING

UNDERGROUND RACEWAY, LOCATED BELOW GRADE OR CONCRETE SLAB

FLEXIBLE RACEWAY RACEWAY TURNED TOWARD VIEWER

RACEWAY TURNED AWAY FROM VIEWER

RACEWAY TERMINATION, STUB-OUT AND CAP PLUG-IN BUSWAY, UNLESS INDICATED OTHERWISE

SURFACE METAL RACEWAY OR MULTIOUTLET ASSEMBLY AS INDICATED

> LADDER TYPE CABLE TRAY (SIZE AS INDICATED ON PLAN)

**GROUNDING AND LIGHTNING PROTECTION** 3/4" x 10'-0" COPPERCLAD GROUND ROD, 18"

BELOW FINISHED GRADE **GROUND ROD TEST WELL** 

BARE COPPER GROUND CONDUCTOR, 1/0 UNLESS INDICATED OTHERWISE.

——G4—— 4/0 BARE COPPER GROUND CONDUCTOR LIGHTNING PROTECTION SYSTEM AIR TERMINAL

——LP—— LIGHTNING PROTECTION ROOF CONDUCTOR

ELECTRICAL CONNECTION

**ELECTRICAL MANHOLE** 

<u>SITE</u>

**ELECTRICAL HANDHOLE** PAD MOUNTED TRANSFORMER

**POWER POLE** DOWN GUY AND ANCHOR (QUANTITY AS INDICATED)

DUCTBANK, TEXT INDICATES QUANTITY AND 2W4" SIZE OF DUCTS (I.E. 2W4" = TWO 4" DUCTS)

**ONE-LINE** 

**TRANSFORMER**  $\widetilde{\mathcal{M}}$ **CURRENT TRANSFORMER** 

FUSE 

> **ELECTRICAL CONNECTION CIRCUIT BREAKER**

SWITCH 0 0 SURGE ARRESTORS

SEPARABLE CONNECTION

Juli DRY TYPE TRANSFORMER, KVA AS INDICATED **GROUND** 

INDIVIDUALLY MOUNTED MOTOR STARTER OR VARIABLE FREQUENCY DRIVE, NEMA SIZE AS

INDICATED FUSED DISCONNECT, FRAME, POLE AND FUSE 

SIZE AS INDICATED. 800A/3P/400A T DENCLOSED INDIVIDUALLY MOUNTED CIRCUIT BREAKER,

I ON CIRCUIT TRIP AND POLE SIZE AS INDICATED. BREAKER I ₀/I 50/3P

**SCHEMATIC** 

 $\sqcup$   $\sqcup$ 

PILOT LIGHT (G=GREEN, R=RED, Y=AMBER) CONTROL RELAY COIL

SHUNT TRIP COIL

TIME DELAY RELAY COIL

MOTOR STARTER COIL METER

**ELECTRONIC METER** 

CHECKED BY: J. WILLIAMS SUBMITTED BY: C. CUSICK DATE: 02/12/2024

> SHEET TITLE **ELECTRICAL**

DESIGNED BY:

DRAWN BY:

PROJECT #:

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US Fish & Wildlife Service

Cameron Prairie

National Wildlife

Refuge

Bunkhouse

LA-27


Bell City, LA 70630

**DRAWING ISSUE** 

**PROJECT NAME** 

LEGEND

**SHEET NUMBER** E-002

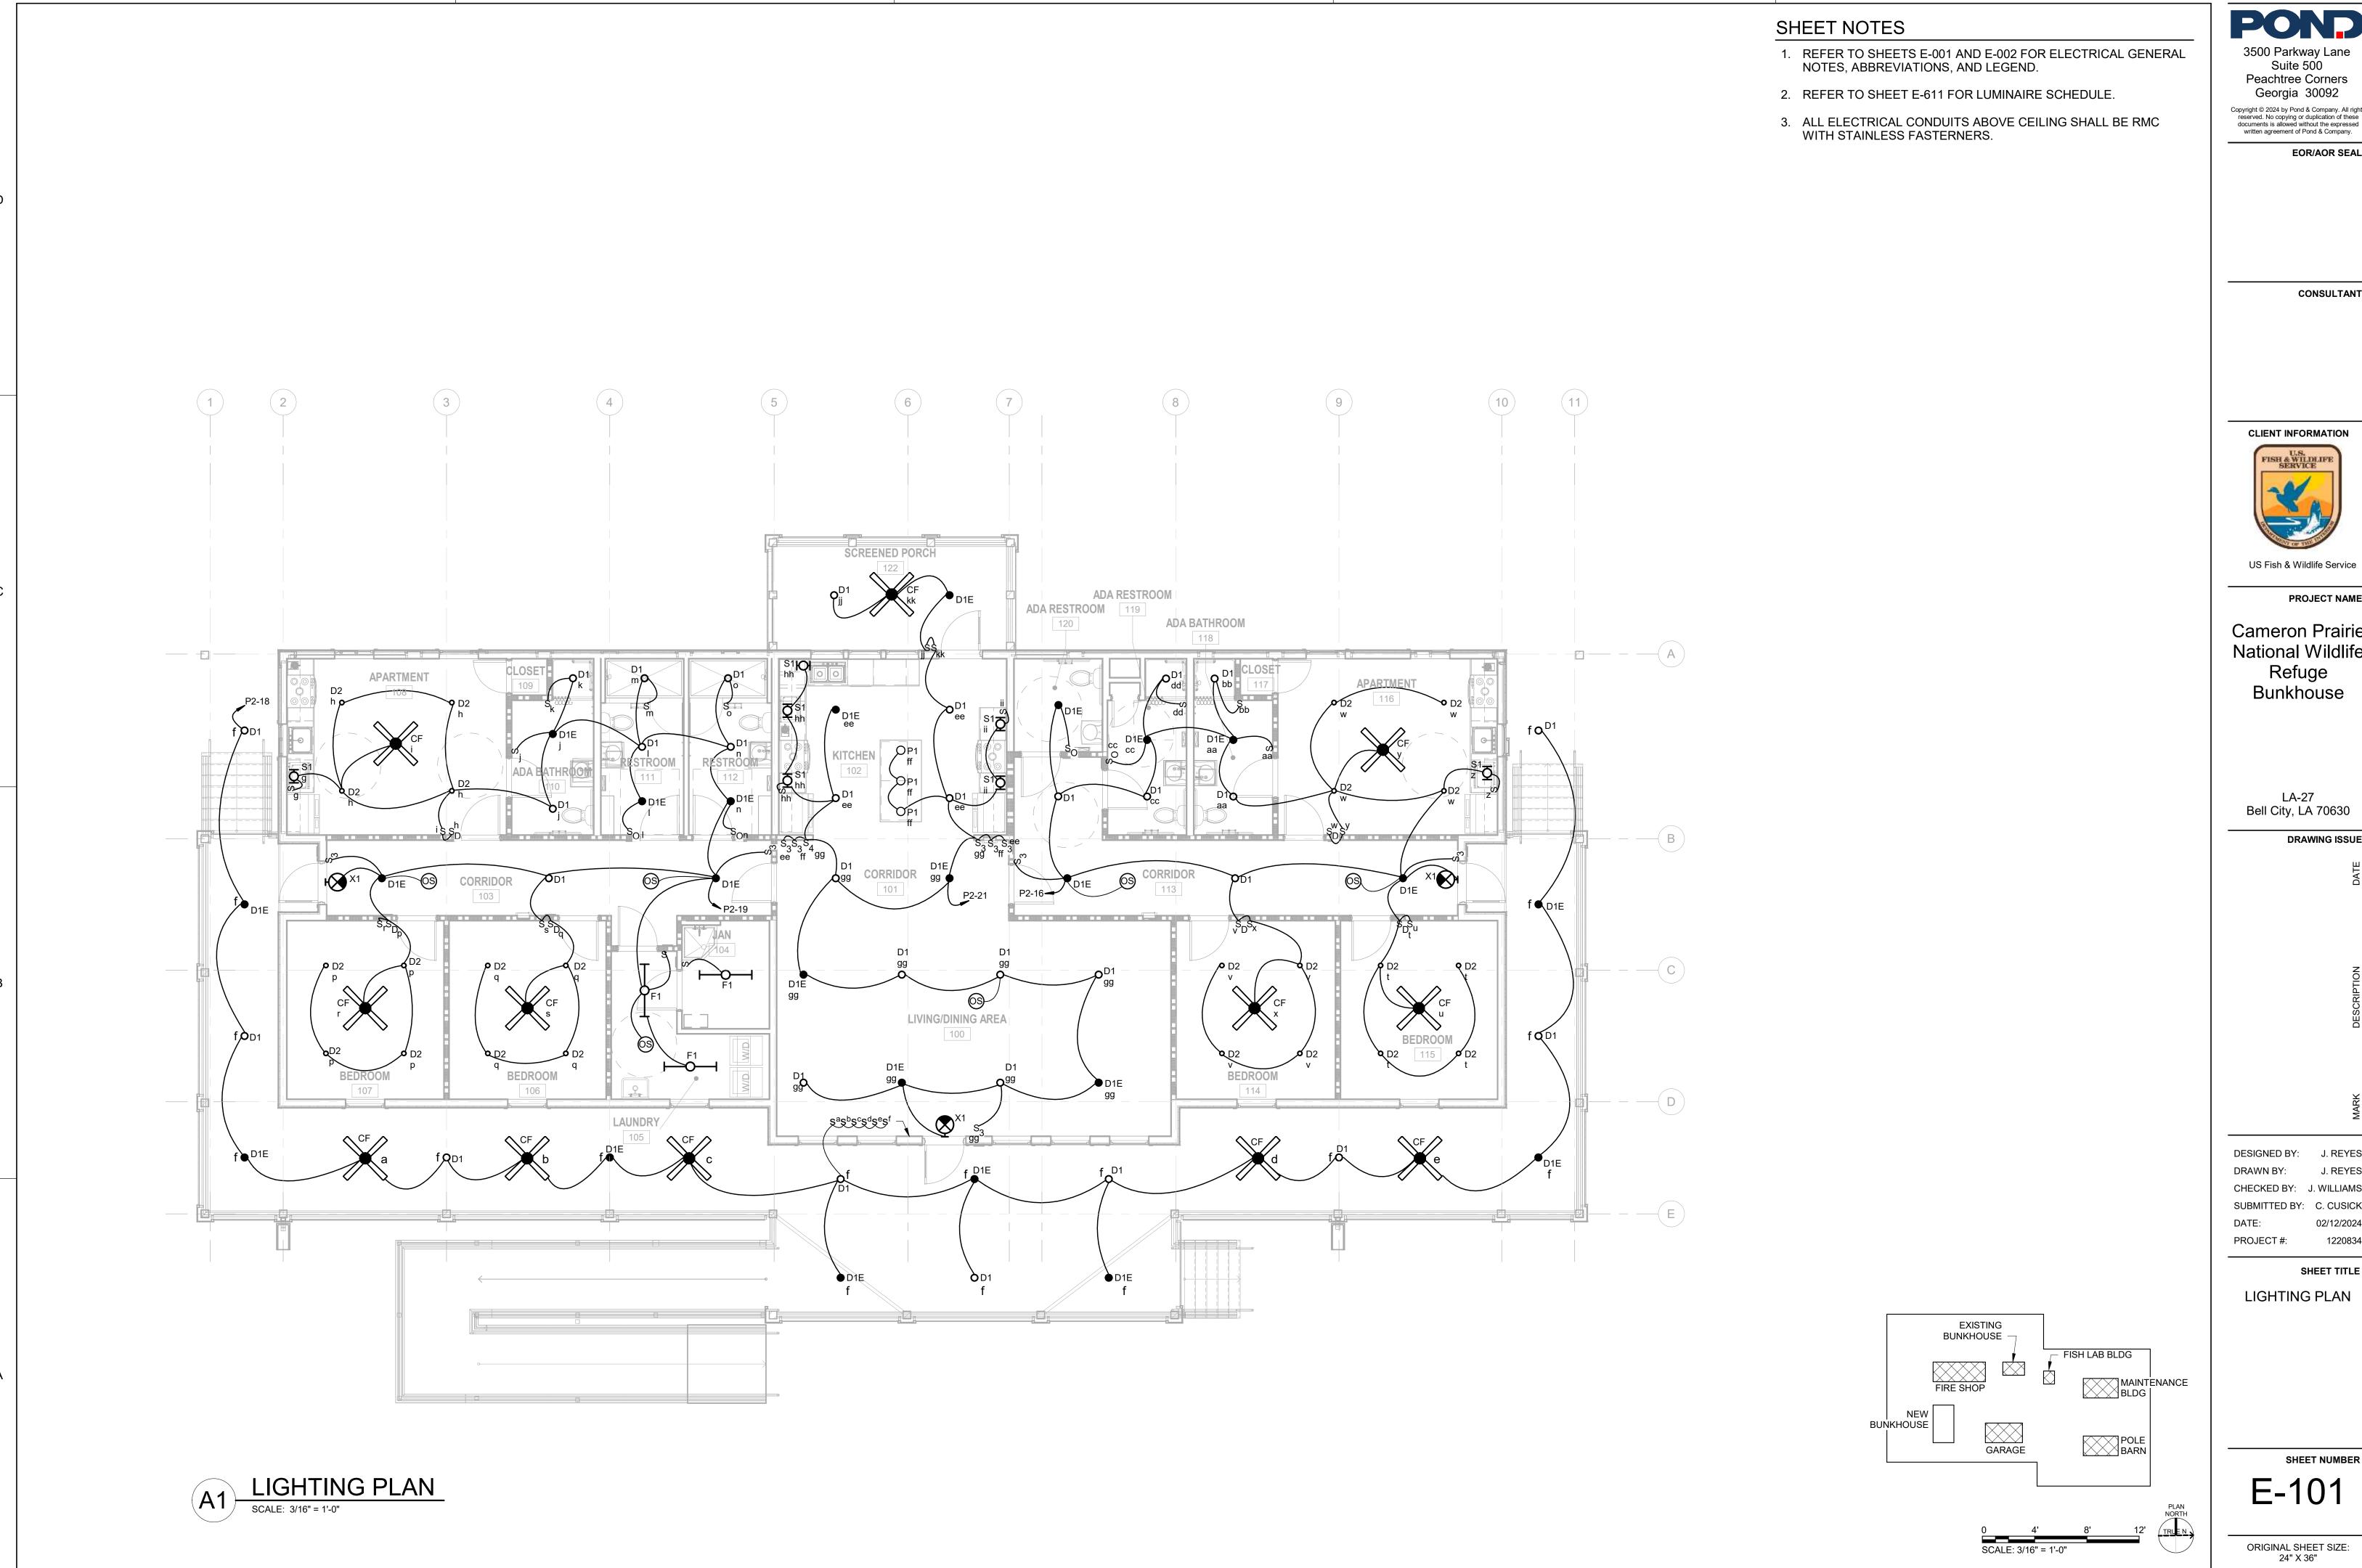

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PROJECT NAME

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LA-27 Bell City, LA 70630

DRAWING ISSUE


DESIGNED BY: J. REYES

CHECKED BY: J. WILLIAMS

SHEET TITLE

LIGHTING PLAN

SHEET NUMBER E-101

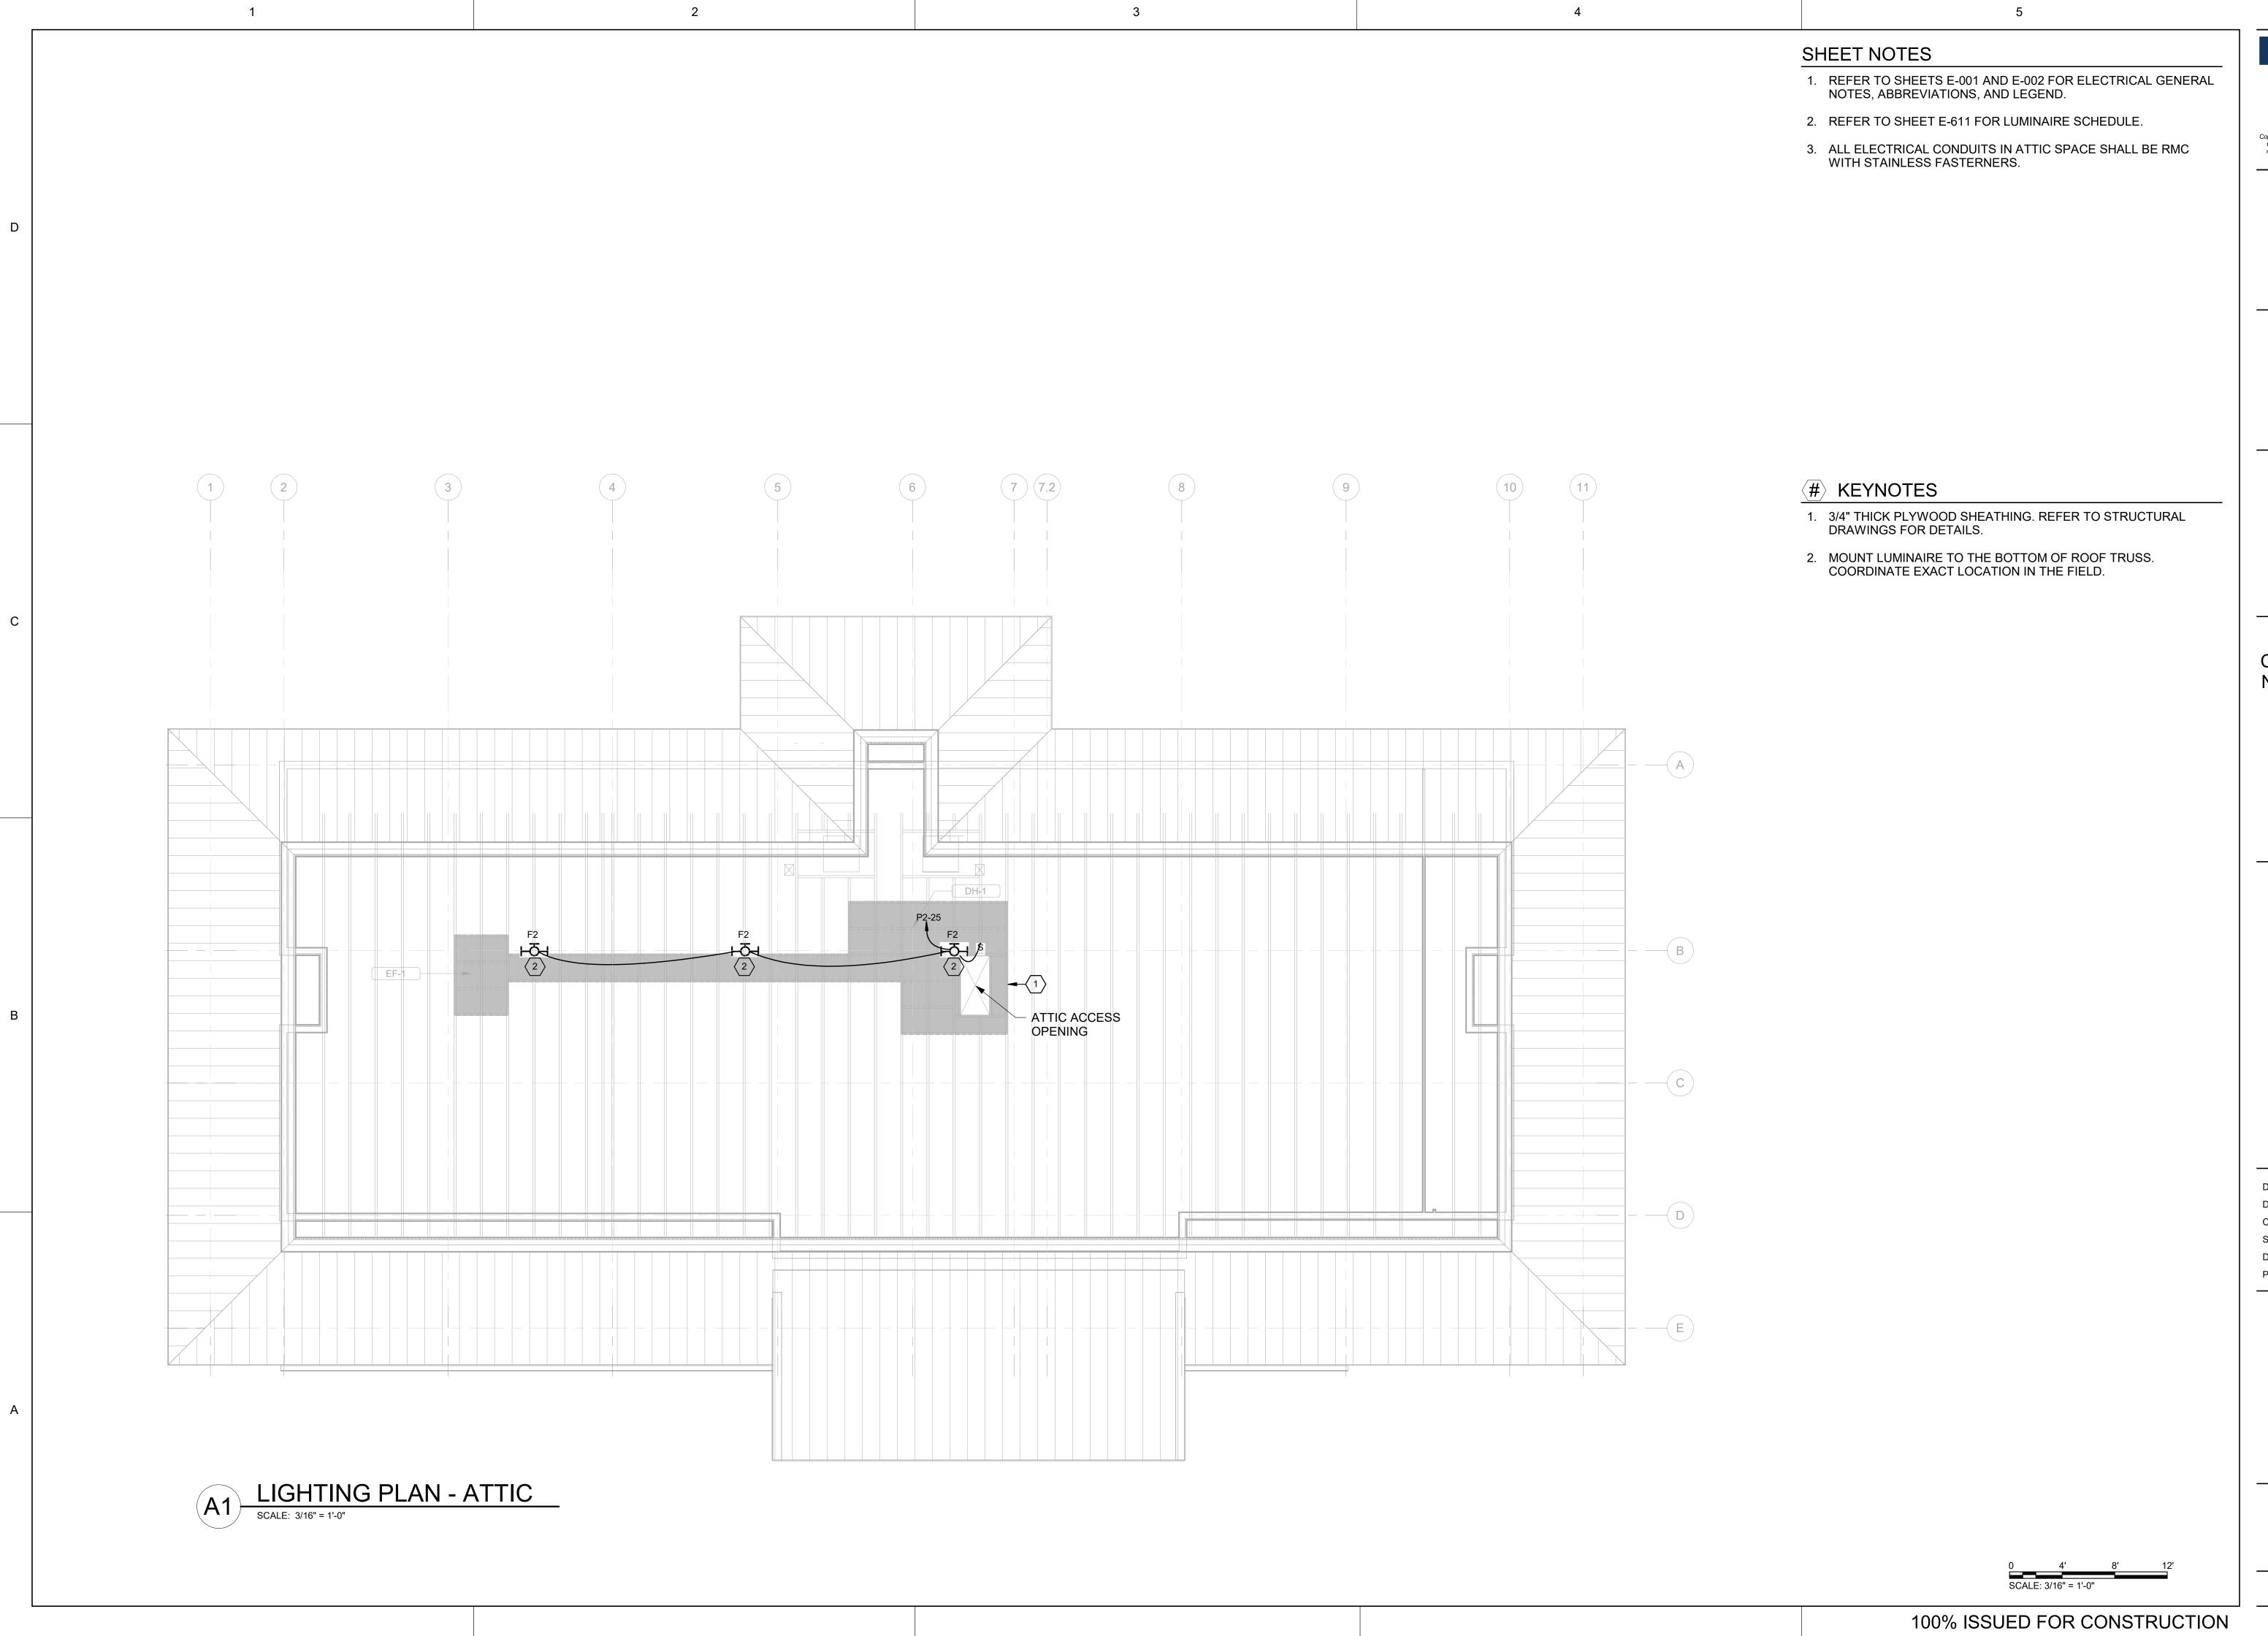

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PROJECT NAME

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DRAWING ISSUE

DRAWING ISC

RIPTION

MARK

DESIGNED BY: Designer
DRAWN BY: Author
CHECKED BY: Checker
SUBMITTED BY: Approver

SHEET TITLE

LIGHTING PLAN -ATTIC

SHEET NUMBER

E-102

- REFER TO SHEETS E-001 AND E-002 FOR ELECTRICAL GENERAL NOTES, ABBREVIATIONS, AND LEGEND.
- 2. REFER TO SHEET E-601 FOR ELECTRICAL SCHEDULES AND ONE-LINE DIAGRAM.
- 3. COORDINATE WITH ARCHITECTURAL DRAWINGS, ELEVATIONS, AND CASEWORK DETAILS FOR EXACT LOCATIONS AND MOUNTING HEIGHTS OF EQUIPMENT.
- 4. REFER TO ARCHITECTURAL DRAWINGS FOR EXACT LOCATIONS OF DEVICES NEEDING PRECISE INSTALLATION.
- 5. ALL BUILDING EXTERIOR ELECTRICAL CONDUITS SHALL BE RMC WITH STAINLESS FASTERNERS.
- 6. REFER TO INFORMATION RESOURCES AND TECHNOLOGY MANAGEMENT (IRTM) FOR TELECOMMUNICATIONS REQUIREMENTS FOR FWS AGENCY SPECIFIC REQUIREMENTS FOR IT INFRASTRUCTURE.

## #> KEYNOTES

- 1. PROVIDE JUNCTION BOX FOR ELECTRICAL CONNECTION TO FIRE ALARM CONTROL PANEL. COORDINATE EXACT LOCATION AND ALL REQUIREMENTS WITH EQUIPMENT SUPPLIER.
- PROVIDE (2) CAT6A CABLE FOR DATA CONNECTION TO GFCI WIRELESS ACCESS POINT.

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US Fish & Wildlife Service

PROJECT NAME

Cameron Prairie National Wildlife Refuge Bunkhouse

LA-27 Bell City, LA 70630

DRAWING ISSUE

ATE

SCRIPTION

J. REYES

CHECKED BY: J. WILLIAMS
SUBMITTED BY: C. CUSICK
DATE: 02/12/2024
PROJECT #: 1220834

DESIGNED BY:

SHEET TITLE

POWER PLAN

SHEET NUMBER

ORIGINAL SHEET SIZE: 24" X 36"

100% ISSUED FOR CONSTRUCTION

NEW BUNKHOUSE

) 4' 8'

- FISH LAB BLDG


MAINTENANCE BLDG |

POLE BARN

EXISTING BUNKHOUSE

GARAGE

E-111

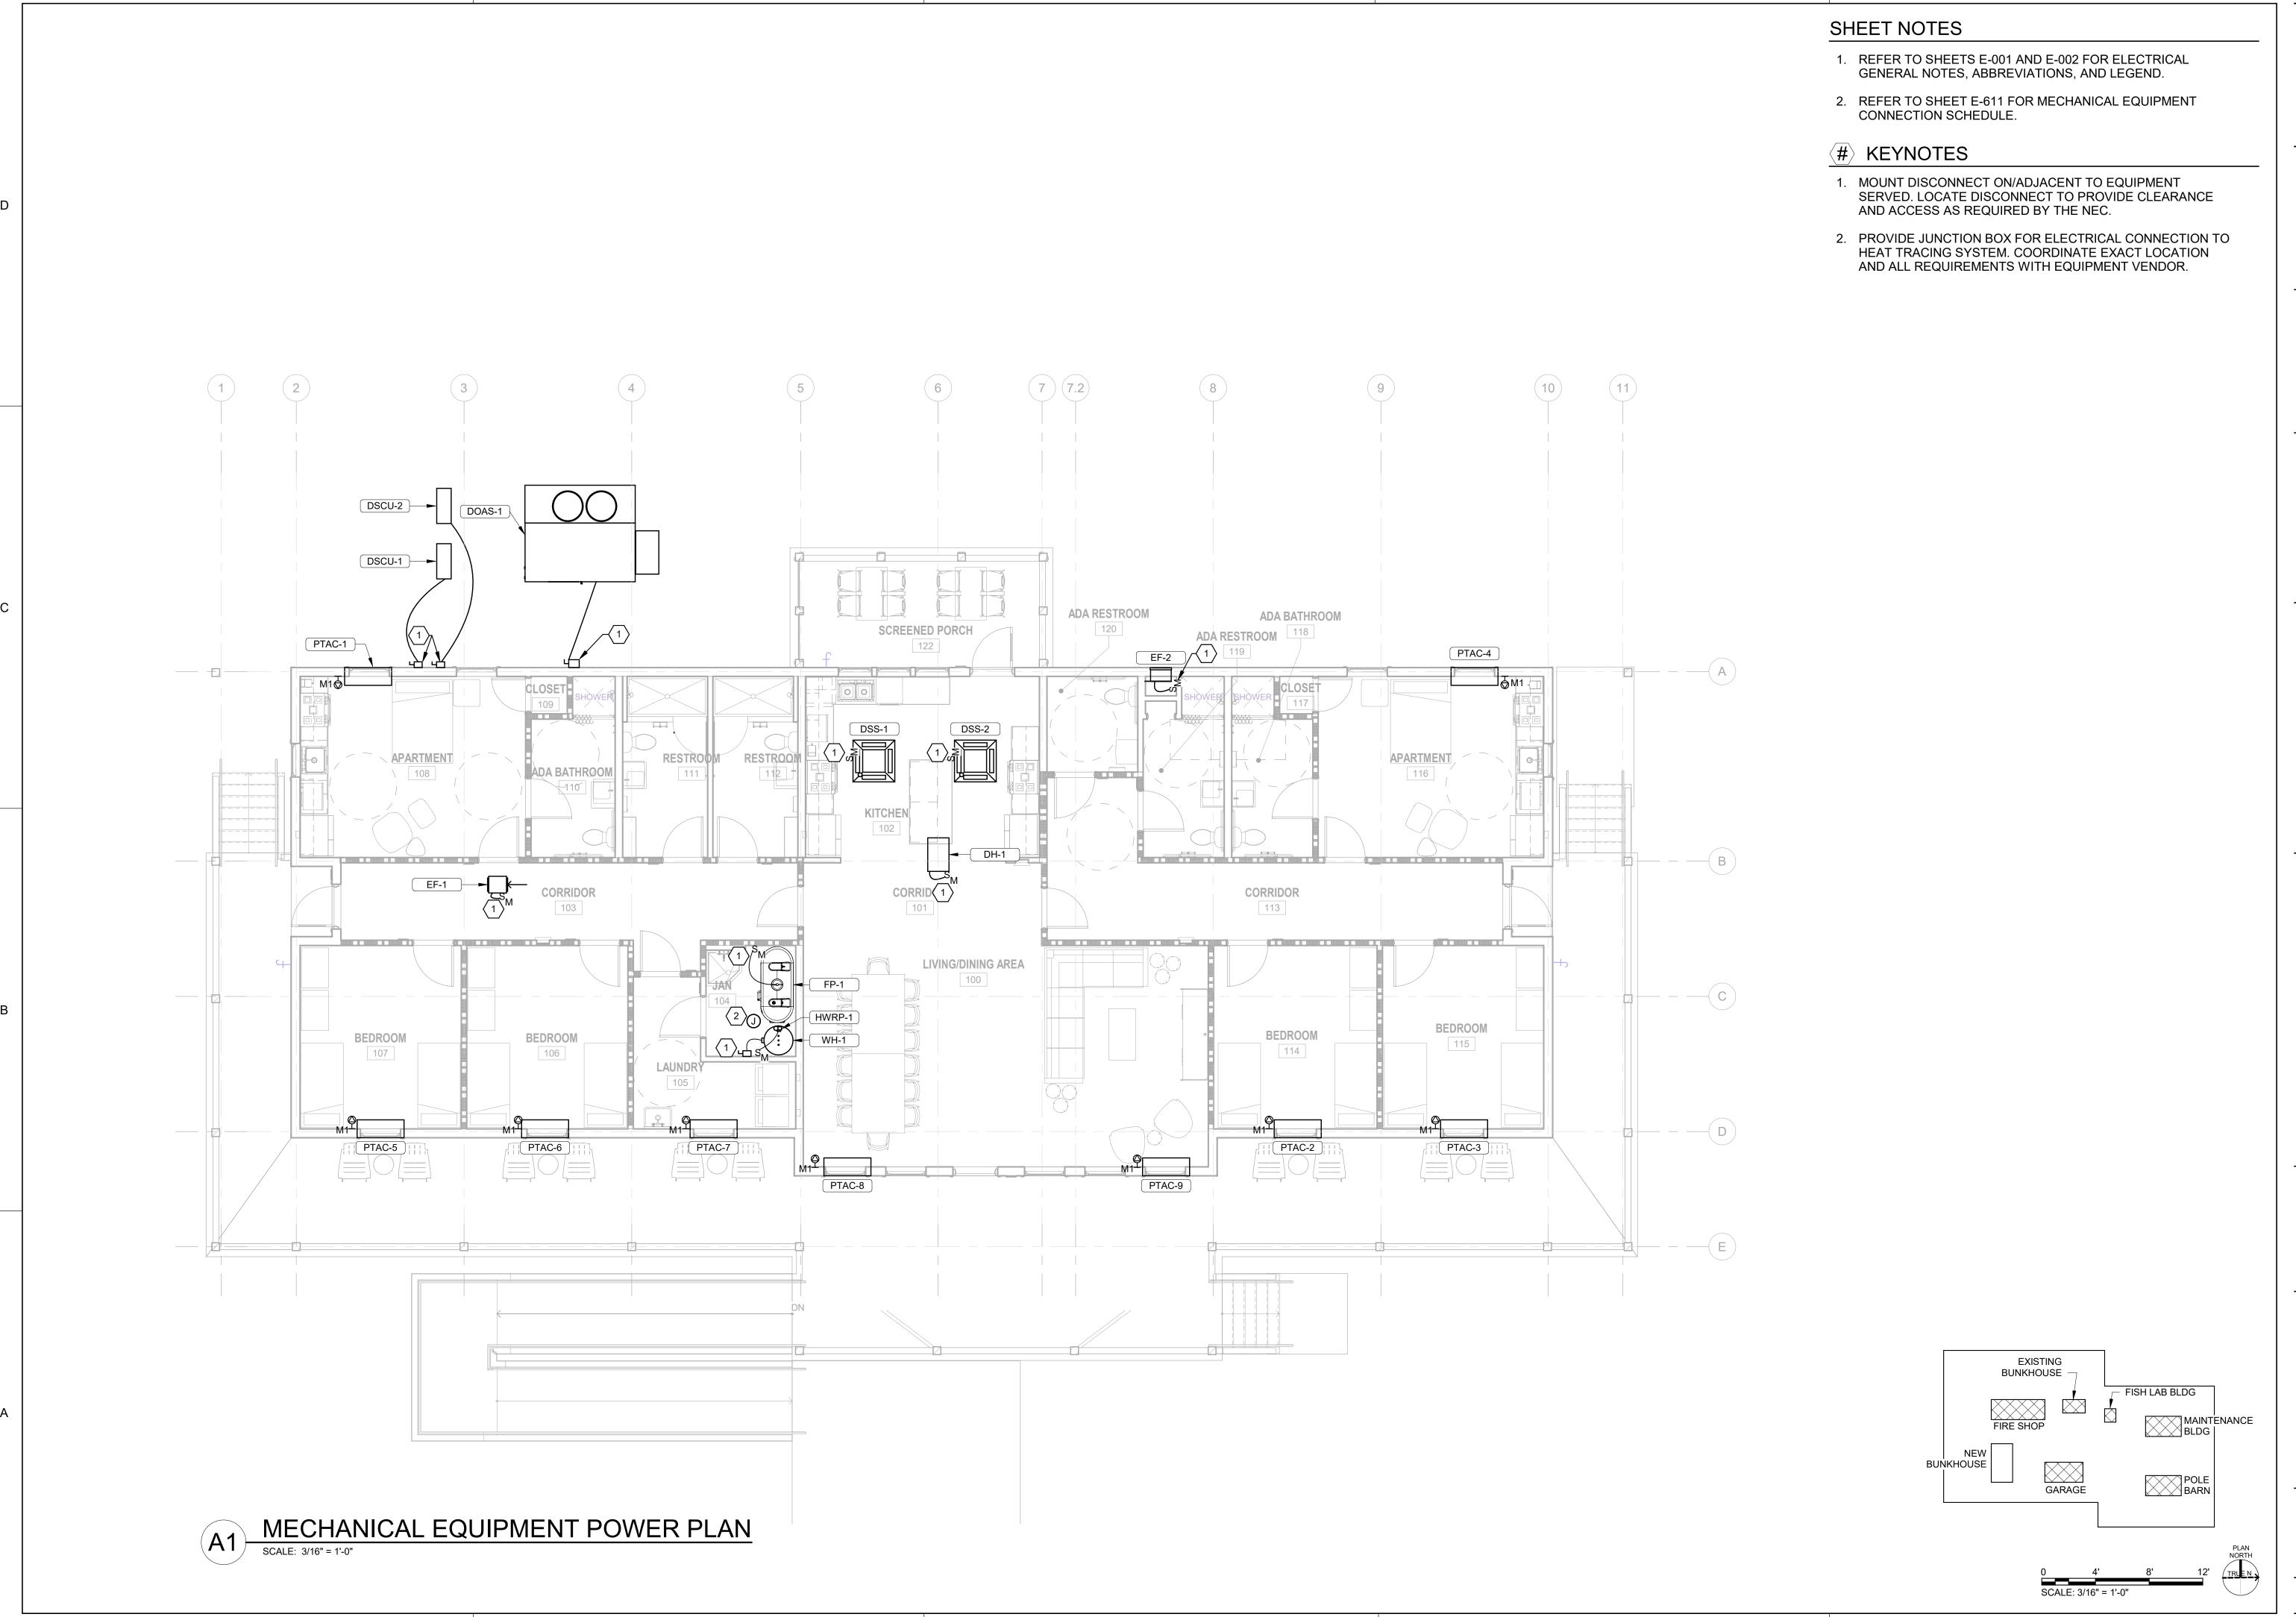

\_ POND

3500 Parkway Lane Suite 500 Peachtree Corners Georgia 30092

Peachtree Corners
Georgia 30092

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CONSULTANT



US Fish & Wildlife Service

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LA-27 Bell City, LA 70630

DRAWING ISSUE

TE

CRIPTION

MARK

DESIGNED BY: J. REYES
DRAWN BY: J. REYES
CHECKED BY: J. WILLIAMS
SUBMITTED BY: C. CUSICK
DATE: 02/12/2024

SHEET TITLE

MECHANICAL EQUIPMENT POWER PLAN

SHEET NUMBER
E-121

\_ .\_

RG 6 - 1"C TO

TELECOM RACK

- 1. REFER TO SHEETS E-001 AND E-002 FOR ELECTRICAL GENERAL NOTES, ABBREVIATIONS AND LEGEND.
- 2. REFER TO SHEET E-601 FOR ELECTRICAL SCHEDULES AND ONE-LINE DIAGRAM.
- 3. COORDINATE WITH ARCHITECTURAL DRAWINGS, ELEVATIONS, AND CASEWORK DETAILS FOR EXACT LOCATIONS AND MOUNTING HEIGHTS OF EQUIPMENT.
- 4. REFER TO ARCHITECTURAL DRAWINGS FOR EXACT LOCATIONS OF DEVICES NEEDING PRECISE INSTALLATION.

JACK LABEL

(ROOM#-

JACK#)

532-1

•

 $\bigcirc$ 

TYPICAL TV OUTLET

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DESIGNED BY: J. REYES J. REYES DRAWN BY: CHECKED BY: J. WILLIAMS SUBMITTED BY: C. CUSICK

PROJECT #: 1220834


SHEET TITLE

02/12/2024

**ELECTRICAL** DETAILS

SHEET NUMBER E-501


ORIGINAL SHEET SIZE: 24" X 36"

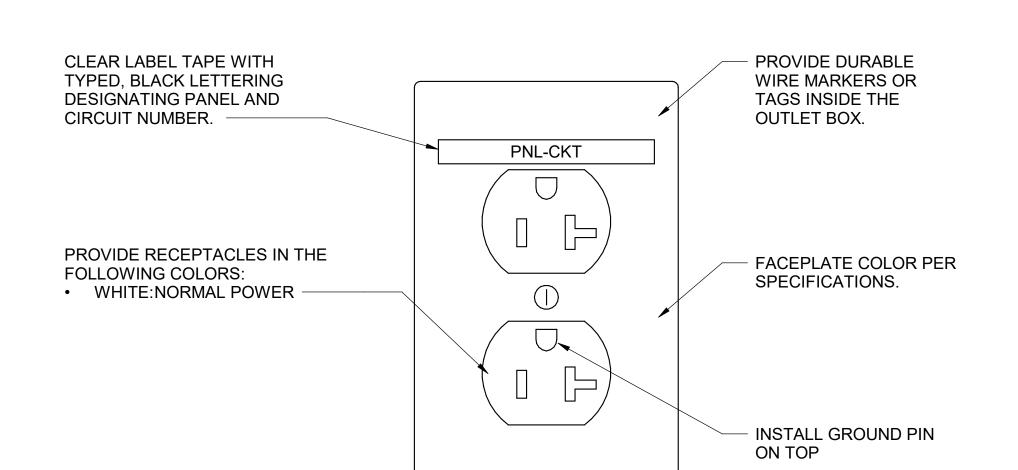


1. RECEPTACLES MARKED AS CONTROLLED SHALL BE SPLIT YOKE WITH THE CONTROLLED RECEPTACLE INSTALLED ABOVE THE NON-CONTROLLED RECEPTACLE.

RECEPTACLE DETAIL (TYP)


SCALE: N.T.S.

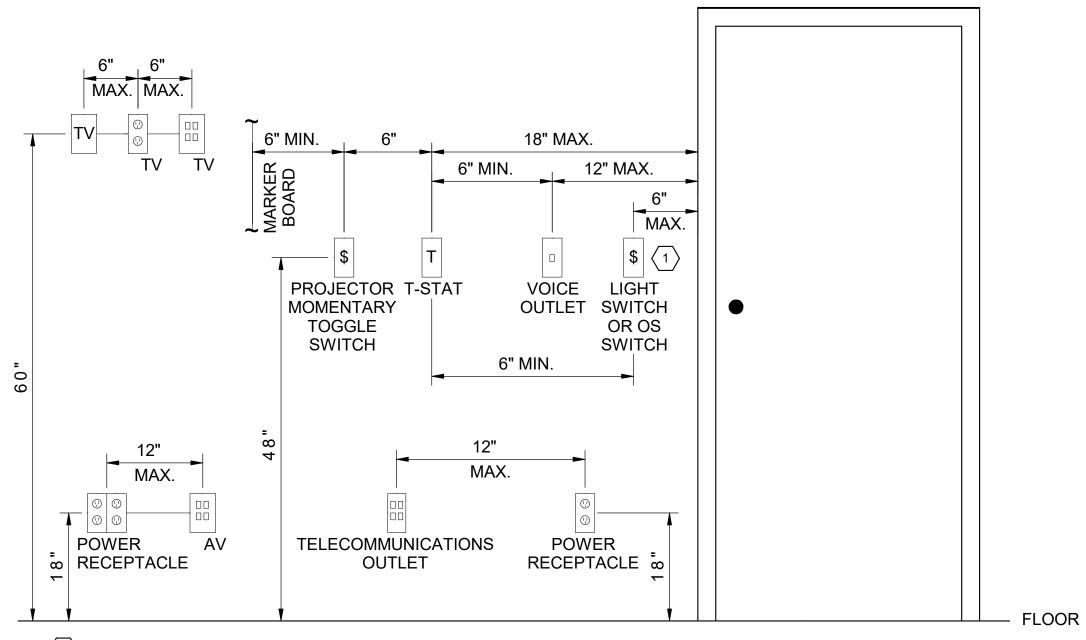


1. ELECTRICAL CONTRACTOR TO SHIFT LIGHT SWITCH IF SOLID FRAMING IS ENCOUNTERED NEXT TO

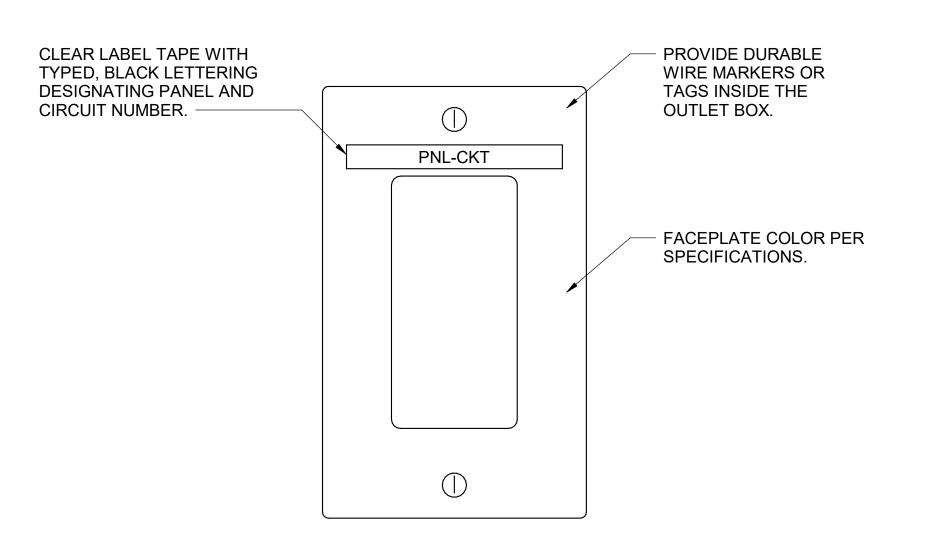


LIGHT SWITCH DETAIL (TYP)

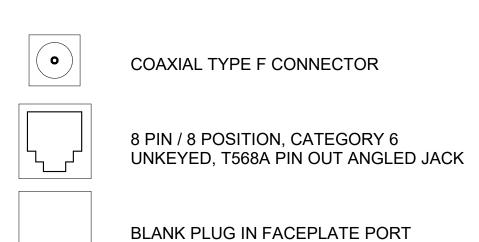



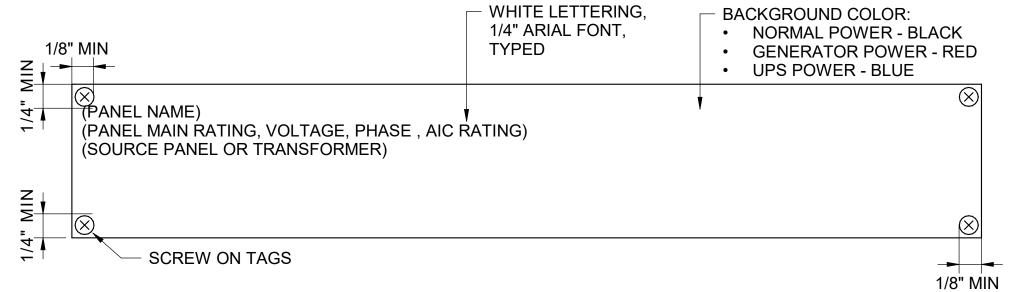



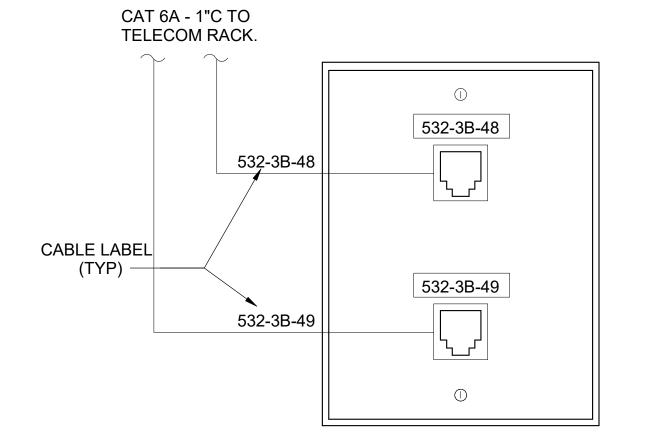




**EXAMPLE**: 150A MCB, 208V, 3Ø, 4W, 10KAIC SOURCE: T-P21A

MOUNTING HEIGHT DETAIL

100% ISSUED FOR CONSTRUCTION

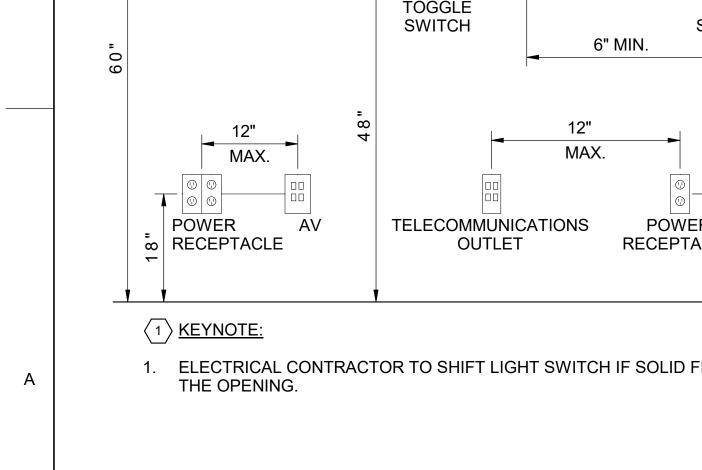

FEE	DER SCHEDULE
FEEDER	
TAG	COPPER FEEDER
20CU	4#12 & 1#12G, 3/4"C.
25CU	4#10 & 1#10G, 3/4"C.
30CU	4#10 & 1#10G, 3/4"C.
35CU	4#8 & 1#10G, 1"C.
40CU	4#8 & 1#10G, 1"C.
45CU	4#6 & 1#10G, 1"C.
50CU	4#6 & 1#10G, 1"C.
60CU	4#4 & 1#10G, 1-1/2"C.
70CU	4#4 & 1#8G, 1-1/2"C.
80CU	4#2 & 1#8G, 1-1/2"C.
90CU	4#2 & 1#8G, 1-1/2"C.
100CU	4#1 & 1#8G, 2"C.
110CU	4#1 & 1#6G, 2"C.
125CU	4#1/0 & 1#6G, 2"C.
150CU	4#1/0 & 1#6G, 2"C.
175CU	4#2/0 & 1#6G, 2"C.
200CU	4#3/0 & 1#6G, 3"C.
225CU	4#4/0 & 1#4G, 3"C.
250CU	4-250 KCMIL & 1#4G, 3"C.
300CU	4-350 KCMIL & 1#4G, 3"C.

FEE	DER SCHEDULE
FEEDER	
TAG	COPPER FEEDER
350CU	4-500 KCMIL & 1#2G, 4"C.
400CU	4-500 KCMIL & 1#2G, 4"C.
400CU*	TWO 3-INCH CONDUITS, EACH WITH FOUR 350 KCMIL AND ONE #1G
450CU	TWO 3-INCH CONDUITS, EACH WITH FOUR 4/0 AND ONE #2G
500CU	TWO 3-INCH CONDUITS, EACH WITH FOUR 250 KCMIL AND ONE #2G
600CU	TWO 3-INCH CONDUITS, EACH WITH FOUR 350 KCMIL AND ONE #1G
700CU	TWO 4-INCH CONDUITS, EACH WITH FOUR 500 KCMIL AND ONE 1/0G
800CU	TWO 4-INCH CONDUITS, EACH WITH FOUR 500 KCMIL AND ONE 1/0G
1000CU	THREE 4-INCH CONDUITS, EACH WITH FOUR 500 KCMIL AND ONE 2/0G
1200CU	FOUR 3-INCH CONDUITS, EACH WITH FOUR 350 KCMIL AND ONE 3/0G
1600CU	FIVE 4-INCH CONDUITS, EACH WITH FOUR 500 KCMIL AND ONE 4/0G
2000CU	SIX 4-INCH CONDUITS, EACH WITH FOUR 500 KCMIL AND ONE 250KCMIL G
EXIST	THREE 3-INCH CONDUITS, EACH WITH FOUR 350 KCMIL AND ONE #1/0G

- 1. FEEDER TAGS WITH A " \* " IN THE TAG HAVE BEEN INCREASED IN SIZE TO ACCOUNT FOR VOLTAGE DROP.
- 2. COORDINATE PANEL LUG SIZE AND QUANTITIES WITH THE SPECIFIED CONDUCTOR SIZES AND NUMBER OF PARALLEL RUNS AS APPLICABLE. LUG SIZES AND QUANTITIES MUST ACCOUNT FOR CONDUCTORS THAT WERE INCREASED IN SIZE AND/OR PARALLEL RUNS ADDED TO ACCOUNT FOR VOLTAGE DROP.
- 3. ALUMINUM CONDUCTORS ARE NOT PERMITTED TO BE USED FOR MECHANICAL EQUIPMENT OR ANY OTHER EQUIPMENT REQUIRING FLEXIBLE CONNECTIONS.

#### OVERHEAD 208/120V, 3PH FIRE SHOP NEW UTILITY TRANSFORMER OUTDOORS | BUILDING BUNKHOUSE MTS WITH CAMLOCK CONNECTORS 600A, 208V, 3-POLE, NEMA 3R 65,000 SCCR LAUNDRY KITCHEN ROOM **EXISTING** STAND-BY 600A/600A/3/3R **GENERATOR** 600AS/600AF 50kW, 208/120V, 3Ø - WALL MOUNTED 3P/3R RACK IN **GROUNDING** PANEL **PANEL** PANEL LAUNDRY ROOM ELECTRODE 100CU C.T./METER -P1 MDP (EG)SYSTEM. CONNECT TO EXISTING SPD **GROUNDING ELECTRODE SYSTEM** (600CU) - 24 STRANDS OM4 FIBER IN 4-INCH – #2G CONDUIT GRADE 」、TO FISH LAB - #3/0G BUILDING 400CU\* (EXIST) (EXIST) **EXOTHERMIC WELD OR HEAVY DUTY** GROUND CLAMP (TYPICAL FOR EACH ELECTRODE CONNECTION) CONNECT TO CONNECT TO **BUILDING METAL** 3/4" X 10' ELECTRICAL RISER DIAGRAM SUPPORT STRUCTURE **GROUND ROD** SCALE: N.T.S. CONNECT TO METAL COLD WATER PIPE

- 1. REFER TO SHEETS E-001 AND E-002 FOR ELECTRICAL GENERAL NOTES, ABBREVIATIONS, AND LEGEND.
  - 2. ENSURE THAT ARC-FAULT CIRCUIT INTERRUPTERS (AFCIs) ARE INSTALLED AND LISTED PER NFPA 70, SECTION 210.12, SPECIFICALLY 210.12(B) THROUGH (E). THE AFCIs SHALL BE LISTED AND INSTALLED IN A READILY ACCESSIBLE LOCATION.

## # KEYNOTES

- 1. REPLACE EXISTING 800A DISCONNECT WITH NEW 600A DISCONNECT AS INDICATED.
- 2. REPLACE EXISTING 800A MTS WITH NEW 600A MTS AS INDICATED.
- 3. CONTRACTOR SHALL PERFORM A 30-DAY LOAD STUDY ON EXISTING PANEL MDP USING A RECORDING AMMETER OR POWER METER CONNECTED TO THE HIGHEST LOADED PHASE OF THE FEEDER. THE RECORDING SHALL REFLECT THE MAXIMUM DEMAND OF THE FEEDER WHEN THE BUILDING IS OCCUPIED. CONTRACTOR SHALL PROVIDE THE RESULTS OF THE STUDY TO THE ENGINEER IMMEDIATELY UPON COMPLETION FOR ANALYSIS.

SHEET NOTES

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Bell City, LA 70630

**DRAWING ISSUE** 

DESIGNED BY: J. REYES DRAWN BY: J. REYES CHECKED BY: J. WILLIAMS SUBMITTED BY: C. CUSICK

PROJECT #:

SHEET TITLE

02/12/2024

1220834

**ELECTRICAL FEEDER** SCHEDULE AND ONE-LINE DIAGRAM

SHEET NUMBER

E-601

1. REFER TO SHEETS E-001 AND E-002 FOR ELECTRICAL GENERAL NOTES, ABBREVIATIONS, AND LEGEND.

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Bell City, LA 70630

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DESIGNED BY: J. REYES DRAWN BY: J. REYES CHECKED BY: J. WILLIAMS SUBMITTED BY: C. CUSICK 02/12/2024

PROJECT #: 1220834

SHEET TITLE

LUMINAIRE AND MECHANICAL **EQUIPMENT** SCHEDULES

E-611

SHEET NUMBER

ORIGINAL SHEET SIZE:
24" X 36"

			LUMINAI	RE SCI	HEDULE	<u> </u>				
FIXTURE	DESCRIPTION	LAMP	LUMENS	CRI	CCT	VOLTAGE	WATTAGE	MOUNTING	MANUFACTURER	NOTES
CF	52" CEILING FAN WITH LIGHT KIT.	LED	1600			120	100 W	FLUSH MOUNT	GENERATION LIGHTING DISCUS 52-IN MATTE BLACK INTEGRATED LED INDOOR/OUTDOOR DOWNROD OR FLUSH MOUNT WITH LIGHT (5-BLADE)	1
D1	6" RECESSED DOWNLIGHT, WET RATED, WHITE FINISH	LED	850	80	3500	120	14 W	RECESSED	LITHONIA LDN6 6" DOWNLIGHT	1,2
D1E	6" RECESSED DOWNLIGHT WITH EMERGENCY BATTERY PACK, WET RATED, WHITE FINISH	LED	850	80	3500	120	14 W	RECESSED	LITHONIA LDN6 6" DOWNLIGHT	1,2,3
D2	4" RECESSED FIRE RATED DOWNLIGHT, WHITE FINISH, DIMMABLE	LED	700	90	3500	120	10 W	RECESSED	JUNO FIREWALL LED DOWNLIGHT SERIES 4" FIRE RATED INTERNALLY	1,2
F1	4' LINEAR STRIP, ACRYLIC ROUND DIFFUSER, WHITE FINISH.	LED	2500	80	3500	120	22 W	SURFACE MOUNT	LITHONIA ZL1D STRIPLIGHT	1,2
F2	2' LINEAR STRIP, ACRYLIC ROUND DIFFUSER, WHITE FINISH.	LED	1500	80	3500	120	17 W	SURFACE MOUNT	LITHONIA ZL1D STRIPLIGHT	1
P1	6" LED PENDANT DOWNLIGHT, WHITE FINISH	LED	1600	90	3000	120	19 W	PENDANT	WAC LIGHTING AMELIA MINI PENDANT SCOTT ARCHITECTURAL LIGHTING METEOR	1,2
S1	12" STRIP LIGHT, WHITE FINISH	LED	520	80	3000	120	4 W	SURFACE MOUNT	SHELF LIGHTING	1
X1	DECORATIVE EDGE LIT ACRYLIC PANEL EXIT SIGN WITH RED LETTERS AND MIRROR BACKGROUND, UNIVERSAL ARROWS.	LED				120	5 W	CEILING, WALL	LIGHTALARMS DUAL-LITE LITHONIA	1,2,3

- 1. DESIGN BASIS SHOWN FOR REFERENCE ONLY. FIXTURES OF EQUAL QUALITY AND PERFORMANCE ARE ACCEPTABLE. ALL FIXTURES MUST BE EQUAL IN MATERIAL, QUALITY, WARRANTY, PHOTOMETRIC, SIZE AND FINISH.
- 2. VERIFY CEILING TYPES WITH ARCHITECTURAL DRAWINGS PRIOR TO ORDERING.
- 3. WIRE ALL EXIT SIGNS AND EMERGENCY BATTERY PACKS IN EMERGNECY LUMINAIRES AHEAD OF ALL LOCAL LIGHTING CONTROL DEVICES.

			MECHA	NICAL	EQUIPMEN	IT CONNECTION	SCHE	DULE			
		NUMBER				BRANCH CIRCUIT			LC	CATION	
UNIT	VOLTAGE	OF POLES	KVA	MCA	DISCONNECT	FEEDER SIZE	PANEL	CIRCUIT	NUMBER	NAME	NOTES
DH-1	120 V	1	0.80 kVA	8.3 A	MRS	2#12 & 1#12G ~ 3/4" C	P1	42	100	LIVING ROOM	2
DOAS-1	208 V	3	22.70 kVA	76.0 A	100/80/3/3R	3#2 & 1#8G, 1"C.	P1	28,30,32	-	OUTSIDE	2
DSCU-1	208 V	2	3.20 kVA	19.0 A	30/30/2//3R	2#10 & 1#10G ~ 3/4" C	P1	34,36	-	OUTSIDE	1,2
DSCU-2	208 V	2	3.20 kVA	19.0 A	30/30/2//3R	2#10 & 1#10G ~ 3/4" C	P1	38,40	-	OUTSIDE	1,2
DSS-1	208 V	2	0.12 kVA	1.0 A	MRS	2#12 & 1#12G ~ 3/4" C	P1	34,36	102	KITCHEN	1,2
DSS-2	208 V	2	0.12 kVA	1.0 A	MRS	2#12 & 1#12G ~ 3/4" C	P1	38,40	102	KITCHEN	1,2
EF-1	120 V	1	0.46 kVA	4.8 A	MRS	2#12 & 1#12G ~ 3/4" C	P1	16	103	CORRIDOR	2
EF-2	120 V	1	0.34 kVA	3.5 A	MRS	2#12 & 1#12G ~ 3/4" C	P1	18	16	APARTMENT	2
FP-1	208 V	2	0.20 kVA	1.0 A	MRS	2#12 & 1#12G ~ 3/4" C	P1	44,46	104	JAN	2
HWRP-1	120 V	1	0.63 kVA	0.7 A	MRS	2#12 & 1#12G ~ 3/4" C	P1	20	105	LAUNDRY	2
PTAC-1	208 V	2	0.69 kVA	4.9 A	NEMA 6-20R	2#12 & 1#12G ~ 3/4" C	P1	13,15	108	APARTMENT	2
PTAC-2	208 V	2	0.53 kVA	3.7 A	NEMA 6-20R	2#12 & 1#12G ~ 3/4" C	P1	17,19	114	BEDROOM	2
PTAC-3	208 V	2	0.53 kVA	3.7 A	NEMA 6-20R	2#12 & 1#12G ~ 3/4" C	P1	21,23	115	BEDROOM	2
PTAC-4	208 V	2	0.69 kVA	4.9 A	NEMA 6-20R	2#12 & 1#12G ~ 3/4" C	P1	25,27	116	APARTMENT	2
PTAC-5	208 V	2	0.53 kVA	3.7 A	NEMA 6-20R	2#12 & 1#12G ~ 3/4" C	P1	29,31	107	BEDROOM	2
PTAC-6	208 V	2	0.53 kVA	3.7 A	NEMA 6-20R	2#12 & 1#12G ~ 3/4" C	P1	33,35	106	BEDROOM	2
PTAC-7	208 V	2	0.53 kVA	3.7 A	NEMA 6-20R	2#12 & 1#12G ~ 3/4" C	P1	37,39	105	LAUNDRY	2
PTAC-8	208 V	2	1.36 kVA	6.7 A	NEMA 6-20R	2#12 & 1#12G ~ 3/4" C	P1	41,43	100	LIVING ROOM	2
PTAC-9	208 V	2	1.36 kVA	6.7 A	NEMA 6-20R	2#12 & 1#12G ~ 3/4" C	P1	45,47	100	LIVING ROOM	2
WH-1	208 V	3	24.00 kVA	83.0 A	100/90/3/1	3#2 & 8G ~ 1" C	P1	22,24,26	104	JAN	2

- NOTES:
  1. INDOOR DSS UNIT FED FROM ASSOCIATED OUTDOOR UNIT.
- 2. ALL CONDUCTORS FOR MECHANICAL AND PLUMBING EQUIPMENT SHALL BE COPPER. THE USE OF ALUMINUM CONDUCTORS TO FEED THIS EQUIPMENT IS NOT PERMITTED.

**CLIENT INFORMATION** 

ORIGINAL SHEET SIZE:

## PANELBOARD SCHEDULE: P1

**MAINS RATING**: 400A MCB  $\langle 1 \rangle$ **LOCATION:** KITCHEN 102 MINIMUM BREAKER SCCR: 25,000 **VOLTAGE**: 208Y/120 SUPPLY FROM: MDP MOUNTING: FLUSH PHASES: 3 **ENCLOSURE**: NEMA 1 WIRES: 4

	СКТ		TRIP	POLE		A	l	3	(		POLE	TRIP	CIRCUIT DESCRIPTION	CKT	
**	1	RANGE ROOM 108	60 A	2	4.55	4.55					2	60 A	RANGE ROOM 102	2	**
	3						4.55	4.55						4	
**	5	RANGE ROOM 102	60 A	2					4.55	4.55	2	60 A	RANGE ROOM 116	6	**
	7				4.55	4.55								8	
	9	WASHER/DRYER RM 105	30 A	2			1.18	1.18			2	30 A	WASHER/DRYER RM 105	10	
	11								1.18	1.18				12	
	13	PTAC-1	20 A	2	0.35	0.18					1	20 A	FIRE ALARM CONTROL PANEL	14	
	15						0.35	0.46			1	20 A	EF-1	16	
	17	PTAC-2	20 A	2					0.27	0.34	1	20 A	EF-2	18	
	19				0.27	0.63					1	20 A	HWRP-1	20	
	21	PTAC-3	20 A	2			0.27	8.00			3	90 A	WH-1	22	
	23								0.27	8.00				24	
	25	PTAC-4	20 A	2	0.35	8.00								26	
	27						0.35	7.57			3	80 A	DOAS-1	28	
	29	PTAC-5	20 A	2					0.27	7.57				30	
	31				0.27	7.57								32	
	33	PTAC-6	20 A	2			0.27	1.66			2	30 A	DSCU-1, DSS-1	34	
	35								0.27	1.66				36	
		PTAC-7	20 A	2	0.27	1.66					2	30 A	DSCU-2, DSS-2	38	
	39						0.27	1.66						40	
		PTAC-8	20 A	2			0.21	1.00	0.68	0.80	1	20 A	DH-1	42	
	43	1 1AC-0	20 /		0.68	0.10			0.00	0.00	2	20 A	FP-1	44	
		PTAC-9	20 A	2	0.00	0.10	0.68	0.10					11-1	46	
	47	F IAC-9					0.00	0.10	0.68	1.10	1		MICROWAVE ROOM 108	48	
		MICROWAVE ROOM 108	 20 A	1	1.10	1.10			0.00	1.10	1		MICROWAVE ROOM 102	50	
		MICROWAVE ROOM 102	20 A	1	1.10	1.10	1.10	0.50			1		DISHWASHER ROOM 102	52	
			20 A	-			1.10	0.50	4.40	4 4 4	-	20 A			
		MICROWAVE ROOM 116	20 A	1	0.40	4.44			1.10	1.44	2		L5-30R RACK RECP	54	
**		REFRIGERATOR ROOM 102	20 A	1	0.18	1.44	4.40	0.00						56	
		MICROWAVE ROOM 116	20 A	1			1.10	0.36	4.40	0.00	1		RACK RECP	58	
		MICROWAVE ROOM 102	20 A	1	0.00	0.00			1.10	0.00	1		SPARE	60	
		SPARE	20 A	1	0.00	0.00	0.00	0.00			1		SPARE	62	
		SPARE	20 A	1			0.00	0.00			1	20 A	SPARE	64	
		SPARE	20 A	1					0.00	0.00	1	20 A	SPARE	66	
		SPACE		1							1		SPACE	68	
		SPACE		1							1		SPACE	70	
		SPACE		1							1		SPACE	72	
		SPACE		1							1		SPACE	74	
		SPACE		1							1		SPACE	76	
		SPACE		1							1		SPACE	78	
	79	PANEL P2	100 A	3	5.24	0.00					3	30 A	SPD	80	
	81						5.52	0.00						82	
	83								4.86	0.00				84	

NOTES: 1. PROVIDE AFCI CIRCUIT BREAKERS FOR BRANCH CIRCUITS NOTED WITH "\*" 2. PROVIDE GFCI CIRCUIT BREAKERS FOR BRANCH CIRCUITS NOTED WITH "\*\*"

Load Classification	Connected Load	Estimated Demand	Panel Totals	
HVAC	56.12 kVA	62.12 kVA	Total Conn. Load:	131.03 kVA
LTG	1.13 kVA	1.13 kVA	Total Est. Demand Load:	135.03 kVA
Other	6.52 kVA	6.52 kVA	Total Conn. Current:	364 A
Power	0.18 kVA	0.18 kVA	Total Est. Demand Current:	375 A
Recp - General Purpose	14.00 kVA	12.00 kVA	Total Est. Design Current:	375 A
Recp - Specific Appliance or Load	53.08 kVA	53.08 kVA		

## PANELBOARD SCHEDULE: P2

**LOCATION**: KITCHEN 102 MAINS RATING: 100A MCB MINIMUM BREAKER SCCR: 25,000 SUPPLY FROM: P1 **VOLTAGE**: 208Y/120

**ENCLOSURE**: NEMA 1 WIRES: 4

	СКТ	CIRCUIT DESCRIPTION	TRIP	POLE		4	E	3	C		POLE	TRIP	CIRCUIT DESCRIPTION	СКТ	
**	1	RECP ROOM 102	20 A	1	0.72	1.05					1	20 A	RECP ROOM 115	2	*
*	3	RECP ROOM 106	20 A	1			1.05	1.05			1	20 A	RECP ROOM 107	4	*
**	5	RECP ROOM 102	20 A	1					0.72	1.05	1	20 A	RECP ROOM 114	6	*
**	7	RECP ROOM 116	20 A	1	0.45	0.45					1	20 A	RECP ROOM 108	8	*
*	9	RECP ROOM 108	20 A	1			0.87	1.05			1	20 A	RECP ROOM 100	10	*
*	11	RECP ROOM 116	20 A	1					0.87	0.54	1	20 A	RECP RM 112,103,111,110	12	*
**	13	RECP RM 100,101,104,105	20 A	1	0.72	0.90					1	20 A	RECP EXTERIOR	14	
*	15	RECP RM 120,119,118,113	20 A	1			0.54	0.28			1	20 A	INTERIOR LIGHTING	16	
	17	RECP EXTERIOR	20 A	1					0.90	0.24	1	20 A	EXTERIOR LIGHTING	18	
	19	INTERIOR LIGHTING	20 A	1	0.36	0.54					1	20 A	RECP CORRIDOR 103	20	
	21	INTERIOR & PORCH LIGHTING	20 A	1			0.32	0.36			1	20 A	RECP LAUNDRY 105	22	
	23	RECP CORRIDOR 113	20 A	1					0.54	0.00	1	20 A	SPARE	24	
	25	ATTIC LIGHTING	20 A	1	0.05	0.00					1	20 A	SPARE	26	
	27	SPARE	20 A	1			0.00	0.00			1	20 A	SPARE	28	
	29	SPARE	20 A	1					0.00	0.00	1	20 A	SPARE	30	
	31	SPARE	20 A	1	0.00	0.00					1	20 A	SPARE	32	
	33	SPARE	20 A	1			0.00	0.00			1	20 A	SPARE	34	
	35	SPARE	20 A	1					0.00	0.00	1	20 A	SPARE	36	
	37	SPACE		1							1		SPACE	38	
	39	SPACE		1							1		SPACE	40	
	41	SPACE		1							1		SPACE	42	
	•		TOTAL	LOAD:	5.	24	5.	52	4.8	86					

Load Classification	Connected Load	Estimated Demand	Panel Totals
LTG	1.13 kVA	1.13 kVA	Total Conn. Load: 15.62 kVA
Other	0.12 kVA	0.12 kVA	Total Est. Demand Load: 14.05 kVA
Recp - General Purpose	13.14 kVA	11.57 kVA	Total Conn. Current: 43 A
Recp - Specific Appliance or Load	1.23 kVA	1.23 kVA	Total Est. Demand Current: 39 A
			Total Ect. Docion Current: 20 A

**EXISTING DISTRIBUTION PANEL: MDP** LOCATION: FIRE SHOP MAINS RATING: 800A MLO **MOUNTING:** SURFACE **VOLTAGE**: 208Y/120 **ENCLOSURE**: NEMA 1 PHASES: 3

WIRES: 4 **SCCR RATING:** 65,000

СКТ	CIRCUIT DESCRIPTION	POLES	TRIP RATING	LOAD	COMMENTS
1	NEW PANEL P1	3	400 A	131.0 kVA	SEE NOTE 1
2	EXISTING PANEL MPFH	3	400 A	40.0 kVA	SEE NOTE 2
3	SPARE	3	200 A	0.0 kVA	
4	UNKNOWN LOAD	3	225 A	20.0 kVA	SEE NOTE 2
5	EXISTING PANEL STORAGE BUILDING	3	125 A	10.0 kVA	SEE NOTE 2
6	SPACE	3			
7	SPACE	3			

NOTES: 1. PROVIDE 100% RATED CIRCUIT BREAKER.

LOAD CLASSIFICATION:	CONNECTED LOAD	ESTIMATED DEMAND	PANEL TOTALS	
HVAC	56.12 kVA	62.12 kVA	TOTAL CONN. LOAD: 20°	1.03 kVA
LTG	1.13 kVA	1.13 kVA	TOTAL EST. DEMAND LOAD: 209	5.03 kVA
Other	6.52 kVA	6.52 kVA	TOTAL CONN. CURRENT: 558	8 A
Power	0.18 kVA	0.18 kVA	TOTAL EST. DEMAND CURRENT: 569	9 A
Spare	70.00 kVA	70.00 kVA	TOTAL EST. DESIGN CURRENT:	
Recp - Specific Appliance or Load	53.08 kVA	53.08 kVA		
Recp - General Purpose	14.00 kVA	12.00 kVA		

MOUNTING: FLUSH PHASES: 3

						CONN	IECTE	D LOA	D KVA						
	СКТ	CIRCUIT DESCRIPTION	TRIP	POLE		A	ı	В		С	POLE	TRIP	CIRCUIT DESCRIPTION	СКТ	
**	1	RECP ROOM 102	20 A	1	0.72	1.05					1	20 A	RECP ROOM 115	2	
*	3	RECP ROOM 106	20 A	1			1.05	1.05			1	20 A	RECP ROOM 107	4	Г
**	5	RECP ROOM 102	20 A	1					0.72	1.05	1	20 A	RECP ROOM 114	6	
**	7	RECP ROOM 116	20 A	1	0.45	0.45					1	20 A	RECP ROOM 108	8	
*	9	RECP ROOM 108	20 A	1			0.87	1.05			1	20 A	RECP ROOM 100	10	
*	11	RECP ROOM 116	20 A	1					0.87	0.54	1	20 A	RECP RM 112,103,111,110	12	
**	13	RECP RM 100,101,104,105	20 A	1	0.72	0.90					1	20 A	RECP EXTERIOR	14	
*	15	RECP RM 120,119,118,113	20 A	1			0.54	0.28			1	20 A	INTERIOR LIGHTING	16	
	17	RECP EXTERIOR	20 A	1					0.90	0.24	1	20 A	EXTERIOR LIGHTING	18	
	19	INTERIOR LIGHTING	20 A	1	0.36	0.54					1	20 A	RECP CORRIDOR 103	20	
	21	INTERIOR & PORCH LIGHTING	20 A	1			0.32	0.36			1	20 A	RECP LAUNDRY 105	22	
	23	RECP CORRIDOR 113	20 A	1					0.54	0.00	1	20 A	SPARE	24	
	25	ATTIC LIGHTING	20 A	1	0.05	0.00					1	20 A	SPARE	26	
	27	SPARE	20 A	1			0.00	0.00			1	20 A	SPARE	28	
	29	SPARE	20 A	1					0.00	0.00	1	20 A	SPARE	30	
	31	SPARE	20 A	1	0.00	0.00					1	20 A	SPARE	32	
	33	SPARE	20 A	1			0.00	0.00			1	20 A	SPARE	34	
	35	SPARE	20 A	1					0.00	0.00	1	20 A	SPARE	36	
	37	SPACE		1							1		SPACE	38	
	39	SPACE		1							1		SPACE	40	
	41	SPACE		1							1		SPACE	42	
		•	TOTAL	LOAD	_	0.4	_	<b>F</b> 0		00	l		•		-

NOTES: 1. PROVIDE AFCI CIRCUIT BREAKERS FOR BRANCH CIRCUITS NOTED WITH "\*"
2. PROVIDE GFCI CIRCUIT BREAKERS FOR BRANCH CIRCUITS NOTED WITH "\*\*"

Load Classification	Connected Load	Estimated Demand	Panel Totals	
LTG	1.13 kVA	1.13 kVA	Total Conn. Load:	15.62 kVA
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Recp - General Purpose	13.14 kVA	11.57 kVA	Total Conn. Current:	43 A
Recp - Specific Appliance or Load	1.23 kVA	1.23 kVA	Total Est. Demand Current:	39 A
			Total Est. Design Current:	39 A

SHEET NOTES

1. REFER TO SHEETS E-001 AND E-002 FOR ELECTRICAL GENERAL NOTES, ABBREVIATIONS, AND LEGEND.

#> KEYNOTES

1. PROVIDE 100% RATED CIRCUIT BREAKER.

US Fish & Wildlife Service

Bell City, LA 70630

**DRAWING ISSUE** 

DESIGNED BY: J. REYES

PROJECT #: 1220834

PANELBOARD

SHEET NUMBER

24" X 36"