VICINITY MAP Goldsboro 170 Kinstop Dover Tuscarora Tuscarora Tuscarora Trenton DAK GRUVE Havelock Hav

22-0005 BUILDING AS2818 HEAD REPAIRS

MARINE CORPS AIR STATION, NEW RIVER, N.C.

LOCATION MAP

AS2818 BERKELEY MANOR \ ROBINZ [H] NEW RIVER PARADISE POINT AREA WATKINS LANDFILI T|L 7 | woodpecker LARK T L PIGEON T L PENGUIN MEANS HIGH WATER +1.00 MEANS SEA LEVEL 0.00 MEANS LOW WATER +0.50 T L Z CARDINAL FRENCH CREEK M VERONA LOOP ROAD Z CONDOR STONE BAY -||SANDPIPER / AMPHIBIAN[\] BASE OSPREYT L ELLIS COVE T L Z CANARY

GENERAL NOTES

- CONSTRUCTION AND MATERIALS INDICATED ARE GENERAL IN NATURE AND ARE NOT INTENDED TO FULLY DESCRIBE THE EXISTING CONSTRUCTION PRESENT. THE CONTRACTOR IS RESPONSIBLE TO INSPECT ALL FACILITIES TO BE DEMOLISHED TO HIS OWN SATISFACTION AND INCLUDE ALL NECESSARY COSTS TO COMPLETELY REMOVE EACH FACILITY AS DESCRIBED. CONTRACTOR SHALL BE RESPONSIBLE FOR ACTUAL FIELD VERIFICATION PRIOR TO BIDDING ORDERING MATERIALS AND DURING EVERY STEP OF CONSTRUCTION FOR EXISTING SURFACES, DIMENSIONS AND CONDITIONS. NUMBER OF ITEMS AND LOCATIONS SHOWN ARE APPROXIMATE, CONTRACTOR MUST VERIFY ALL CONDITIONS AND INCLUDE IN SCOPE OF WORK ACCORDINGLY.
- PRIOR TO STARTING DEMOLITION ON ANY STRUCTURES OR UTILITIES, THE CONTRACTOR SHALL FAMILIARIZE HIMSELF WITH THE EXISTING CONDITIONS OF ANY STRUCTURES AND UTILITIES. THE CONTRACTOR SHALL DEVELOP A PLAN OF DEMOLITION THAT ENSURES ALL ACTIVITIES ARE COMPLETED IN A SAFE MANNER. PROVIDE ANY TEMPORARY SHORING, SHEETING OR SUPPORT REQUIRED TO COMPLETE WORK IN A SAFE MANNER.
- COMPLETELY REMOVE ALL STRUCTURE AND UTILITIES INDICATED, BOTH ABOVE GROUND AND BELOW GROUND.
 WHERE ROADS, SIDEWALKS, ETC ARE INDICATED TO BE CUT AND PATCHED, EACH SHALL BE REMOVED AND REPLACED ALONG NEAT SAW CUT LINES, AND TO THE NEAREST JOINT WHERE IT EXISTS.
- 5. REPAIR AND REFINISH AREAS DAMAGED OR DISTURBED BY NEW WORK TO BE PROVIDED UNDER THIS CONTRACT.
 6. DIMENSIONS PROVIDED ON EXISTING ITEMS ARE PROVIDED TO AID THE CONTRACTOR UNDERSTAND THE SCOPE OF WORK. FIELD VERIFY ALL CONDITIONS. ALL THE DIMENSIONS SHOWN ARE APPROXIMATE ONLY.
- METHOD OF REMOVAL OF ANY BUILDING COMPONENT SHALL BE APPROVED BY THE COR (CONTRACTING OFFICER REPRESENTATIVE). THE CONTRACTOR SHALL BE RESPONSIBLE FOR ENSURING THAT REMOVAL OF EXISTING
- DEMOLITION OPERATIONS SHALL BE COMPLETED IN COMPLIANCE WITH ALL STATE AND FEDERAL REGULATIONS AND AS SPECIFIED.
- ALL CONSTRUCTION ACTIVITIES SHALL BE IN ACCORDANCE WITH OSHA STANDARDS, AND GOVERNMENT REQUIREMENTS
- 10. THE NOTATION (TYP) INDICATES THAT THE CONDITION OCCURS IN MORE THAN ONE PLACE INCLUDING ALL SIMILAR CONDITIONS NOT INDIVIDUALLY NOTED.
- 11. COORDINATE STAGING AREA, SITE ACCESS, TOILET USE WITH THE COR (CONTRACTING OFFICER REPRESENTATIVE).
- 12. CONTRACTOR SHALL BE RESPONSIBLE FOR SITE SECURITY AND JOB SAFETY.

COMPONENTS DO NOT AFFECT ADJACENT OCCUPIED AREAS.

- 13. AREAS OUTSIDE THE LIMITS OF PROPOSED WORK DISTURBED BY THE CONTRACTOR'S OPERATIONS SHALL BE RESTORED BY THE CONTRACTOR TO THEIR ORIGINAL CONDITION AT THE CONTRACTOR'S EXPENSE AS SOON AS PRACTICABLE.
- 14. CONTRACTOR SHALL MINIMIZE DUST, SEDIMENT AND DEBRIS FROM EXITING THE CONSTRUCTION SITE AND SHALL BE RESPONSIBLE FOR CLEANUP, REPAIRS AND CORRECTIVE ACTION IF SUCH OCCURS. CONTRACTOR SHALL DISPOSE OF DEBRIS IN ACCORDANCE WITH APPLICABLE FEDERAL, STATE, AND LOCAL REGULATIONS, ORDINANCE AND STATUTES.
- 15. BURNING WILL NOT BE ALLOWED ON THE PROJECT SITE UNLESS AUTHORIZED IN WRITING BY THE CONTRACTING OFFICER.
- 16. ADJACENT STRUCTURES AND UTILITIES MUST REMAIN IN OPERATION DURING DEMOLITION ACTIVITIES. EXISTING ROADS SHALL REMAIN OPEN AND ACCESSIBLE BY VEHICULAR AND PEDESTRIAN TRAFFIC. IF ROADWAY CLOSURE IS REQUIRED, APPROVAL SHALL BE SECURED FROM THE CONTRACTING OFFICER. THE CONTRACTOR SHALL PROVIDE BARRICADES, LIGHTS, SIGNAGE AND OTHER PROTECTIVE DEVICES IN ACCORDANCE
- 7. ALL EXISTING UTILITIES AND EXISTING FEATURES ARE TO BE FIELD VERIFIED PRIOR TO CONSTRUCTION. CONTRACTOR MUST BE RESPONSIBLE FOR ANY DAMAGE TO EXISTING UTILITIES.
- 18. CONTRACTOR'S PERSONNEL MUST WEAR IDENTIFICATION AT ALL TIMES.

DRAWING INDEX

		שאאוט	
NO.	SHEET#	NAVFAC #	SHEET NAME
1	G-001	60039605	TITLE SHEET, GENERAL NOTES AND AREA MAPS
2	G-002	60039606	GENERAL NOTES
3	C-101	60039607	SITE DEMOLITION PLAN
4	C-102	60039608	NEW WORK SITE PLAN
5	C-103	60039609	SITE DETAILS
6	A-101	60039610	FLOOR PLAN - DEMOLITION
7	A-102	60039611	FLOOR PLAN - RENOVATION
8	A-103	60039612	ROOF PLAN
9	A-401	60039613	INTERIOR ELEVATIONS, SCHEDULES, AND DETAILS
10	A-501	60039614	DETAILS
11	A-601	60039615	SCHEDULES AND SIGNAGE
12	P1	60039616	PLUMBING DEMOLITION
13	P2	60039617	PLUMBING NEW WORK
14	P3	60039618	WATER ISOMETRIC
15	P4	60039619	WASTE AND VENT ISOMETRIC
16	P5	60039620	PLUMBING DETAILS
17	P6	60039621	PLUMBING DETAILS AND SCHEDULE
18	M1	60039622	MECHANICAL LAYOUT AND DETAILS
19	E-100	60039623	ELECTRICAL LEGEND AND NOTES
20	E-101	60039624	SITE AND DEMOLITION PLAN
21	E-102	60039625	LIGHTING AND POWER PLAN
22	E-103	60039626	DETAILS, SCHEDULES, AND RISER

- A. THE CONTRACTOR SHALL NOT RELEASE TO ANYONE OUTSIDE THE CONTRACTOR'S ORGANIZATION ANY UNCLASSIFIED INFORMATION, REGARDLESS OF MEDIUM (E.G., FILM, TAPE, DOCUMENT), PERTAINING TO ANY PART OF THIS CONTRACT OR ANY PROGRAM RELATED TO THIS CONTRACT, UNLESS:
- CONTRACT, UNLESS:

 (1) THE CONTRACTING OFFICER HAS GIVEN PRIOR WRITTEN APPROVAL; OR

 (2) THE INFORMATION IS OTHERWISE IN THE PUBLIC DOMAIN BEFORE THE DATE OF RELEASE.
- B. REQUESTS FOR APPROVAL SHALL IDENTIFY THE SPECIFIC INFORMATION TO BE RELEASED, THE MEDIUM TO BE USED, AND THE PURPOSE FOR THE RELEASE. THE CONTRACTOR SHALL SUBMIT ITS REQUEST TO THE CONTRACTING OFFICER AT LEAST 45 DAYS BEFORE THE PROPOSED DATE FOR RELEASE.
- C. THE CONTRACTOR AGREES TO INCLUDE A SIMILAR REQUIREMENT IN EACH SUBCONTRACT UNDER THIS CONTRACT. SUBCONTRACTORS SHALL SUBMIT REQUESTS FOR AUTHORIZATION TO RELEASE THROUGH THE PRIME CONTRACTOR TO THE CONTRACTING OFFICER.

FIN		G-0	01		
DEPARTMENT OF THE NAVY NAVAL FACILITIES ENCORING THE NAVAL FACILITIES ENCORI				S BAS	E
DES. M. HUNTER	BUILDING AS:			2818	
DR. M.HUNTER					
CHK. K. ROOT, R.A.			EAD REPA	VIK2	
SUBMITTED BY: M. HUNTER	J ,	TITLE QUEET	GENERAL NO	TEC ADEA	MADS
DESIGN DIR. J. FRANKLIN ORR, P.E.		IIILE SHEET,	GENERAL NO	ies, area	MAPS
APPROVED: PWO OR OICC: DATE:	SIZE	CODE IDENT. NO	NAVFA	C DRAWING NO.	
PWO or OICC 11/16/2023	E1 80091		60	039605	
SATISFACTORY TO: DATE:			CONST. CONTR.	ND.	22-0005
	SCAL	E: NOTED	SPEC. NA	SHEET: 1	of 22

GENERAL NOTES/ENVIRONMENTAL NOTES:

- 1. TO ACCESS SITE CONTACT MCBCL CONSTRUCTION MANAGER.
- 2. CLEAN ALL ITEMS AS NECESSARY TO RECEIVE NEW FINISHES. FILL ALL HOLES TO MATCH EXISTING CONDITIONS.
- 3. CONTRACTOR SHALL INSURE THAT THE BUILDING REMAINS WATERTIGHT THROUGH OUT THE CONSTRUCTION OPERATIONS AND AT THE END OF EACH DAY.
- I. SUBMITTALS SHALL BE SUBMITTED TO CONTRACTING OFFICER CONTRACTING REPRESENTATIVE FOR APPROVAL.
- 5. ALL STEEL ANGLES, PLATES AND BOLTS SHALL BE PRIMED PAINTED AS TEMPORARY PROTECTION AGAINST ORDINARY ATMOSPHERIC CONDITIONS. SUBSEQUENT FINISH PAINTING SHALL BE PROVIDED BY CONTRACTOR.
- 6. COORDINATE STAGING AREA, SITE ACCESS, TOILET USE WITH THE COR (CONTRACTING OFFICER REPRESENTATIVE).
- BURNING WILL NOT BE ALLOWED ON THE PROJECT SITE UNLESS AUTHORIZED IN WRITING BY THE CONTRACTING OFFICER.
- 8. CONTRACTOR IS RESPONSIBLE FOR PLACING BARRICADES USING FLAG MEN, FENCE, ETC AS NECESSARY TO INSURE SAFETY TO PUBLIC AND BUILDING OCCUPANTS.
- 9. CONTRACTOR'S PERSONNEL MUST WEAR IDENTIFICATION AT ALL TIMES.
- 10. IF CONTAMINANTS ARE SUSPECTED THROUGH ODORS OR VISUAL ACTIVITIES, IMMEDIATELY STOP WORK. CALL 911 AND CONTACT EQB AT (910) 451-9017 FOR INSTRUCTIONS.
- 11. CONTRACTOR SHALL REVIEW ASBESTOS INSPECTION SURVEY BEFORE COMMENCING WORK.

GENERAL NOTES - ROOFING:

- 1. ITEM LOCATION SUCH AS VENTS, GOOSENECKS, EQUIPMENT, TIE ANCHORS, ETC. IS APPROXIMATE. FIELD VERIFY
- 2. FIELD VERIFY VENT QUANTITIES
- 3. ALL FLASHING, COUNTER FLASHING, WOOD BLOCKING, WOOD NAILERS, AND RELATED ROOF ITEMS MUST BE REPLACED WITH NEW PER CONSTRUCTION DOCUMENTS
- 4. UNLESS OTHERWISE NOTED, ALL ROOF PENETRATIONS AND PLUMBING VENTS CURRENTLY LOCATED ON THE ROOF ARE TO REMAIN IN PLACE SUBSEQUENT TO NEW ROOF
- INSTALLATION. REMOVE AND REPLACE ALL EXISTING FLASHING ELEMENTS AT ALL PENETRATIONS PRIOR TO NEW ROOFING SYSTEM INSTALLATION.

 5. THE CONTRACTOR SHALL COORDINATE ALL UTILITY CONNECTIONS (PLUMBING, ELECTRICAL, HVAC, ETC.) WITH DEMOLITION AND RENOVATION PHASING. COORDINATE ALL
- SHUTDOWNS AND/OR MODIFICATIONS OF EXISTING SYSTEMS WITH THE CONSTRUCTION MANAGER.
 6. THE CONTRACTOR SHALL DE-ENERGIZE ALL ELECTRIC CIRCUITS PRIOR TO DEMOLITION OF AFFECTED EQUIPMENT, RE-CONNECT, AND RE-ENERGIZE ALL AFFECTED
- EQUIPMENT AND ELECTRICAL DEVICES AS NECESSARY TO RETURN THEM TO WORKING CONDITIONS.

 7. THE CONTRACTORS MAY ONLY USE THE CAMP LEJEUNE LANDFILL FOR THE DISPOSAL OF ASBESTOS CONTAINING MATERIALS, BUILDING PRODUCTS WITH TIGHTLY ADHERED LEAD CONTAINING PAINT, NON-CONTAMINATED CLEAN DIRT AND CLEAN GRAVEL. THE HOURS OF OPERATION ARE 0730-1530. DELIVERY OF ACCEPTABLE MATERIALS (LEAD AND
- ASBESTOS) SHALL BE BY APPOINTMENT ONLY. APPOINTMENTS MADE BY PHONE AT 910-451-5011 OR 910-451-2946.

 NON-CONTAMINATED MATERIALS (IDENTIFIED ABOVE): ALL OTHER CONTRACTOR GENERATED MATERIAL SHALL BE WEIGHED THROUGH THE BASE LANDFILL SCALES BEFORE BEING REMOVED FROM THE BASE. CONTRACTORS UTILIZING THE BASE SCALES WILL REQUIRE CONTRACTING OFFICER ASSISTED PRE-REGISTRATION WITH THE LANDFILL MANAGER. THE CONTRACTING OFFICER WILL REGISTER THE CONTRACT VIA E-MAIL, WITH THE BASE LANDFILL. ALL HAUL VEHICLES WILL MAINTAIN A SECURE VEHICLE PLACARD AS A CONDITION TO UTILIZE THE SCALE. E-MAIL THE CONTRACT INFORMATION TO THE LANDFILL CLERK, INCLUDING THE NAME ON THE PRIME CONTRACTOR, CONTRACT NUMBER, JOB NAME/DESCRIPTION, COMPLETION DATE AND WHETHER OR NOT ANY OF THE ABOVE MATERIALS WILL BE DELIVERED TO THE LANDFILL. HAULING AND OFF-BASE LANDFILL COSTS SHALL BE INCLUDED IN THE CONTRACT.

HAZARDOUS WASTE:

- 1. IF HAZARDOUS MATERIALS ARE FOUND ENSURE THAT SUBJECT BUILDING(S)/STRUCTURE(S) ARE EVALUATED FOR ASBESTOS/ASBESTOS CONTAINING MATERIALS/LEAD BY A CERTIFIED PROFESSIONAL PRIOR TO THE DEMOLITION/RENOVATION.
- 2. ALL HAZARDOUS WASTE GENERATED BY THIS PROJECT (FOR EXAMPLE: SAA MANAGEMENT; CONTAINER MANAGEMENT; MANIFEST REQUIREMENTS; STORAGE; AND SHIPMENT) SHALL MEET RCRA STANDARDS.
- 3. COORDINATE WITH FELICIA PADILLA, SUPERVISOR RESOURCE CONSERVATION & SECTION ENVIRONMENT PROTECTION SPECIALIST ENVIRONMENTAL MANAGEMENT DIVISION MARINE CORPS BASE CAMP LEJEUNE. TELEPHONE:910-451-5256. E-MAIL: felicia.padilla@usmc.mil

MISCELLANEOUS EXTERIOR ELEVATIONS:

- 1. REMOVE ALL DAMAGED MORTAR JOINTS (DOES NOT INCLUDE DEMOLISHED CONDITIONS SHOWN IN THE HATCHED AREAS). INFILL WITH NEW MORTAR TO MATCH EXISTING CONDITIONS. FOR BIDDING PURPOSES ASSUME THAT 30 LF OR CMU JOINT MORTARS WILL NEED TO BE REPOINTED.
- 2. POWER WASH ALL CMU PRIOR TO PAINTING. SCRAPE/REMOVE LOOSE PAINT PRIOR TO PAINTING.
- 3. ACTUAL SAMPLES OF ALL THE EXTERIOR MATERIALS MUST BE SUBMITTED TO THE BEAP FOR REVIEW AND APPROVAL, NO EXCEPTIONS. COLOR CHIPS, PHOTOCOPIES, ELECTRONIC SAMPLES WILL NOT BE ACCEPTABLE

ROUGH CARPENTRY

- 1. ALL WOOD AND PLYWOOD NEEDED TO REPAIR EXISTING CONDITIONS SHALL MEET THE FOLLOWING STANDARDS: ASTM INTERNATIONAL; AMERICAN WOOD COUNCIL (AWC); AMERICAN WOOD PRESERVERS ASSOCIATION (AWPA); THE ENGINEERED WOOD ASSOCIATION (APA); INTERNATIONAL CODE COUNCIL (ICC); NATIONAL FIRE PROTECTION ASSOCIATION (NFPA); AND AMERICAN WOOD PRESERVERS ASSOCIATION (AWPA)
- 2. TREAT WOOD PRODUCTS WITH WATERBORNE WOOD PRESERVATIVES CONFORMING TO AWPA P5. PRESSURE TREATMENT OF WOOD PRODUCTS SHALL CONFORM TO THE REQUIREMENTS OF AWPA BOOK. USE CATEGORY SYSTEM STANDARDS U1 AND T1.
- 3. PRESSURE-TREATED WOOD PRODUCTS SHALL NOT CONTAIN ARSENIC, CHROMIUM, OR OTHER AGENTS CLASSIFIED AS CARCINOGENIC, PROBABLY CARCINOGENIC, OR POSSIBLY CARCINOGENIC TO HUMANS
- (COMPOUNDS IN GROUPS 1, 2A, OR 2B) BY THE INTERNATIONAL AGENCY FOR RESEARCH ON CANCER (IARC), LYON, FRANCE.
 4. PRESSURE-TREATED WOOD PRODUCTS SHALL NOT EXCEED THE LIMITS OF THE U.S. EPA'S TOXIC CHARACTERISTIC LEACHING PROCEDURE (TCLP), AND SHALL NOT BE CLASSIFIED AS HAZARDOUS WASTE. SUBMIT
- . PRESSURE-TREATED WOOD PRODUCTS SHALL NOT EXCEED THE LIMITS OF THE U.S. EPA'S TOXIC CHARACTERISTIC LEACHING PROCEDURE (TCLP), AND SHALL NOT BE CLASSIFIED AS HAZARDOUS WASTE. SUBMI CERTIFICATION FROM TREATING PLANT STATING CHEMICALS AND PROCESS USED AND NET AMOUNT OF PRESERVATIVES RETAINED ARE IN CONFORMANCE WITH SPECIFIED STANDARDS.
- 5. FOR ABOVE GROUND USE: 0.25 POUNDS PER CUBIC METER (PCF).6. FOR GROUND CONTACT AND FRESH WATER USE: 0.40 POUNDS PER CUBIC METER (PCF).
- ALL WOOD SHALL BE AIR OR KILN DRIED AFTER TREATMENT.
- 3. SPECIFIC TREATMENTS SHALL BE VERIFIED BY THE REPORT OF AN APPROVED INDEPENDENT INSPECTION AGENCY, OR THE AWPA QUALITY MARK ON EACH PIECE. PRESERVATIVE-TYPE PRESSURE TREATMENT SHALL
 HAVE A MINIMUM MOISTURE CONTENT OF 19 PERCENT AFTER PRESSURE TREATMENT AND SHALL BE PRESSURE TREATED USING AMMONIACAL COPPER QUATERNARY COMPOUND (ACQ). PRESERVATIVE SHALL
- PENETRATE A MINIMUM OF 3/8-INCH (9.5 MM) DEEP INTO WOOD.
 FASTENERS AND CONNECTORS USED WITH PRESERVATIVE PRESSURE TREATED LUMBER SHALL BE G185 HOT DIP GALVANIZED, TYPE 304 STAINLESS STEEL OR TYPE 316 STAINLESS STEEL.

SHOP DRAWING SUBMITTALS:

- 1. SHOP DRAWINGS MUST BE PROJECT-SPECIFIC
- SHOP DRAWINGS MUST BE WELL COORDINATED AMONG THE VARIOUS VENDORS/TRADES/SUBCONTRACTORS THAT CONSTITUTE A PARTICULAR BUILDING SYSTEM
- 3. THE GOVERNMENT WILL REJECT INCOMPLETE SHOP DRAWINGS. COMPLETE SHOP DRAWINGS MUST SHOW ALL INTERFACING COMPONENTS. FOR EXAMPLE, ON BUILDING ENVELOPE SYSTEMS:
- OPENING PRODUCTS SUCH AS WINDOWS, DOORS, LOUVERS, PENETRATIONS, ETC. WITHOUT FLASHING, VAPOR BARRIER, THREE-PIECE SILL, INSULATION OF AIR SPACE, ETC., AND/OR
- b. COMPONENTS SHOWN IN NON-PROJECT SPECIFIC WAY, AND/OR
- c. COMPONENT LAYOUTS LABELED "ITEM BY OTHERS",


ESTABLISHED GOOD PRACTICES, ETC.

4. GOVERNMENT APPROVAL OF SHOP DRAWINGS DOES NOT RELIEVE THE CONTRACTOR OF THEIR RESPONSIBILITY TO PROVIDE THE CORRECT QUANTITIES, CAPABILITIES, PERFORMANCE, COORDINATION WITH ALL TRADES, TO PERFORM THOROUGH FIELD INVESTIGATIONS, TO PROVIDE COMPLETE SYSTEMS IN PLACE AND READY FOR USE IN ACCORDANCE TO THE CONTRACT DOCUMENTS, REFERENCED CODES, GUIDELINES,

- A. THE CONTRACTOR SHALL NOT RELEASE TO ANYONE OUTSIDE THE CONTRACTOR'S ORGANIZATION ANY UNCLASSIFIED INFORMATION, REGARDLESS OF MEDIUM (E.G., FILM, TAPE, DOCUMENT), PERTAINING TO ANY PART OF THIS CONTRACT OR ANY PROGRAM RELATED TO THIS CONTRACT, UNLESS:

 (1) THE CONTRACTING OFFICER HAS GIVEN PRIOR WRITTEN APPROVAL; OR
 - (2) THE INFORMATION IS OTHERWISE IN THE PUBLIC DOMAIN BEFORE THE DATE OF RELEASE.
- B. REQUESTS FOR APPROVAL SHALL IDENTIFY THE SPECIFIC INFORMATION TO BE RELEASED, THE MEDIUM TO BE USED, AND THE PURPOSE FOR THE RELEASE. THE CONTRACTOR SHALL SUBMIT ITS REQUEST TO THE CONTRACTING OFFICER AT LEAST 45 DAYS BEFORE THE PROPOSED DATE FOR RELEASE.
- C. THE CONTRACTOR AGREES TO INCLUDE A SIMILAR REQUIREMENT IN EACH SUBCONTRACT UNDER THIS CONTRACT. SUBCONTRACTORS SHALL SUBMIT REQUESTS FOR AUTHORIZATION TO RELEASE THROUGH THE PRIME CONTRACTOR TO THE CONTRACTING OFFICER.

FIN	IAL	G-002		
		NAVAL FACILITIES ENGINEERING COMMAND E CORPS BASE LEJEUNE, NORTH CAROLINA		
DES. M. HUNTER	RIII	LDING AS2818		
DR. M.HUNTER				
CHK. K. ROOT, R.A.	HEAD REPAIRS			
SUBMITTED BY: M. HUNTER	GENERAL NOTES			
DESIGN DIR. J. FRANKLIN ORR, P.E.	9	SENERAL NOTES		
APPROVED: PWO OR OICC: DATE:	SIZE CODE IDENT. NO	NAVFAC DRAWING NO.		
PWO or OICC	E1 80091	60039606		
SATISFACTORY TO: DATE:		CONST. CONTR. NO. 22-0005		
	SCALE: NOTED S	SPEC. NA SHEET: 2 OF 22		

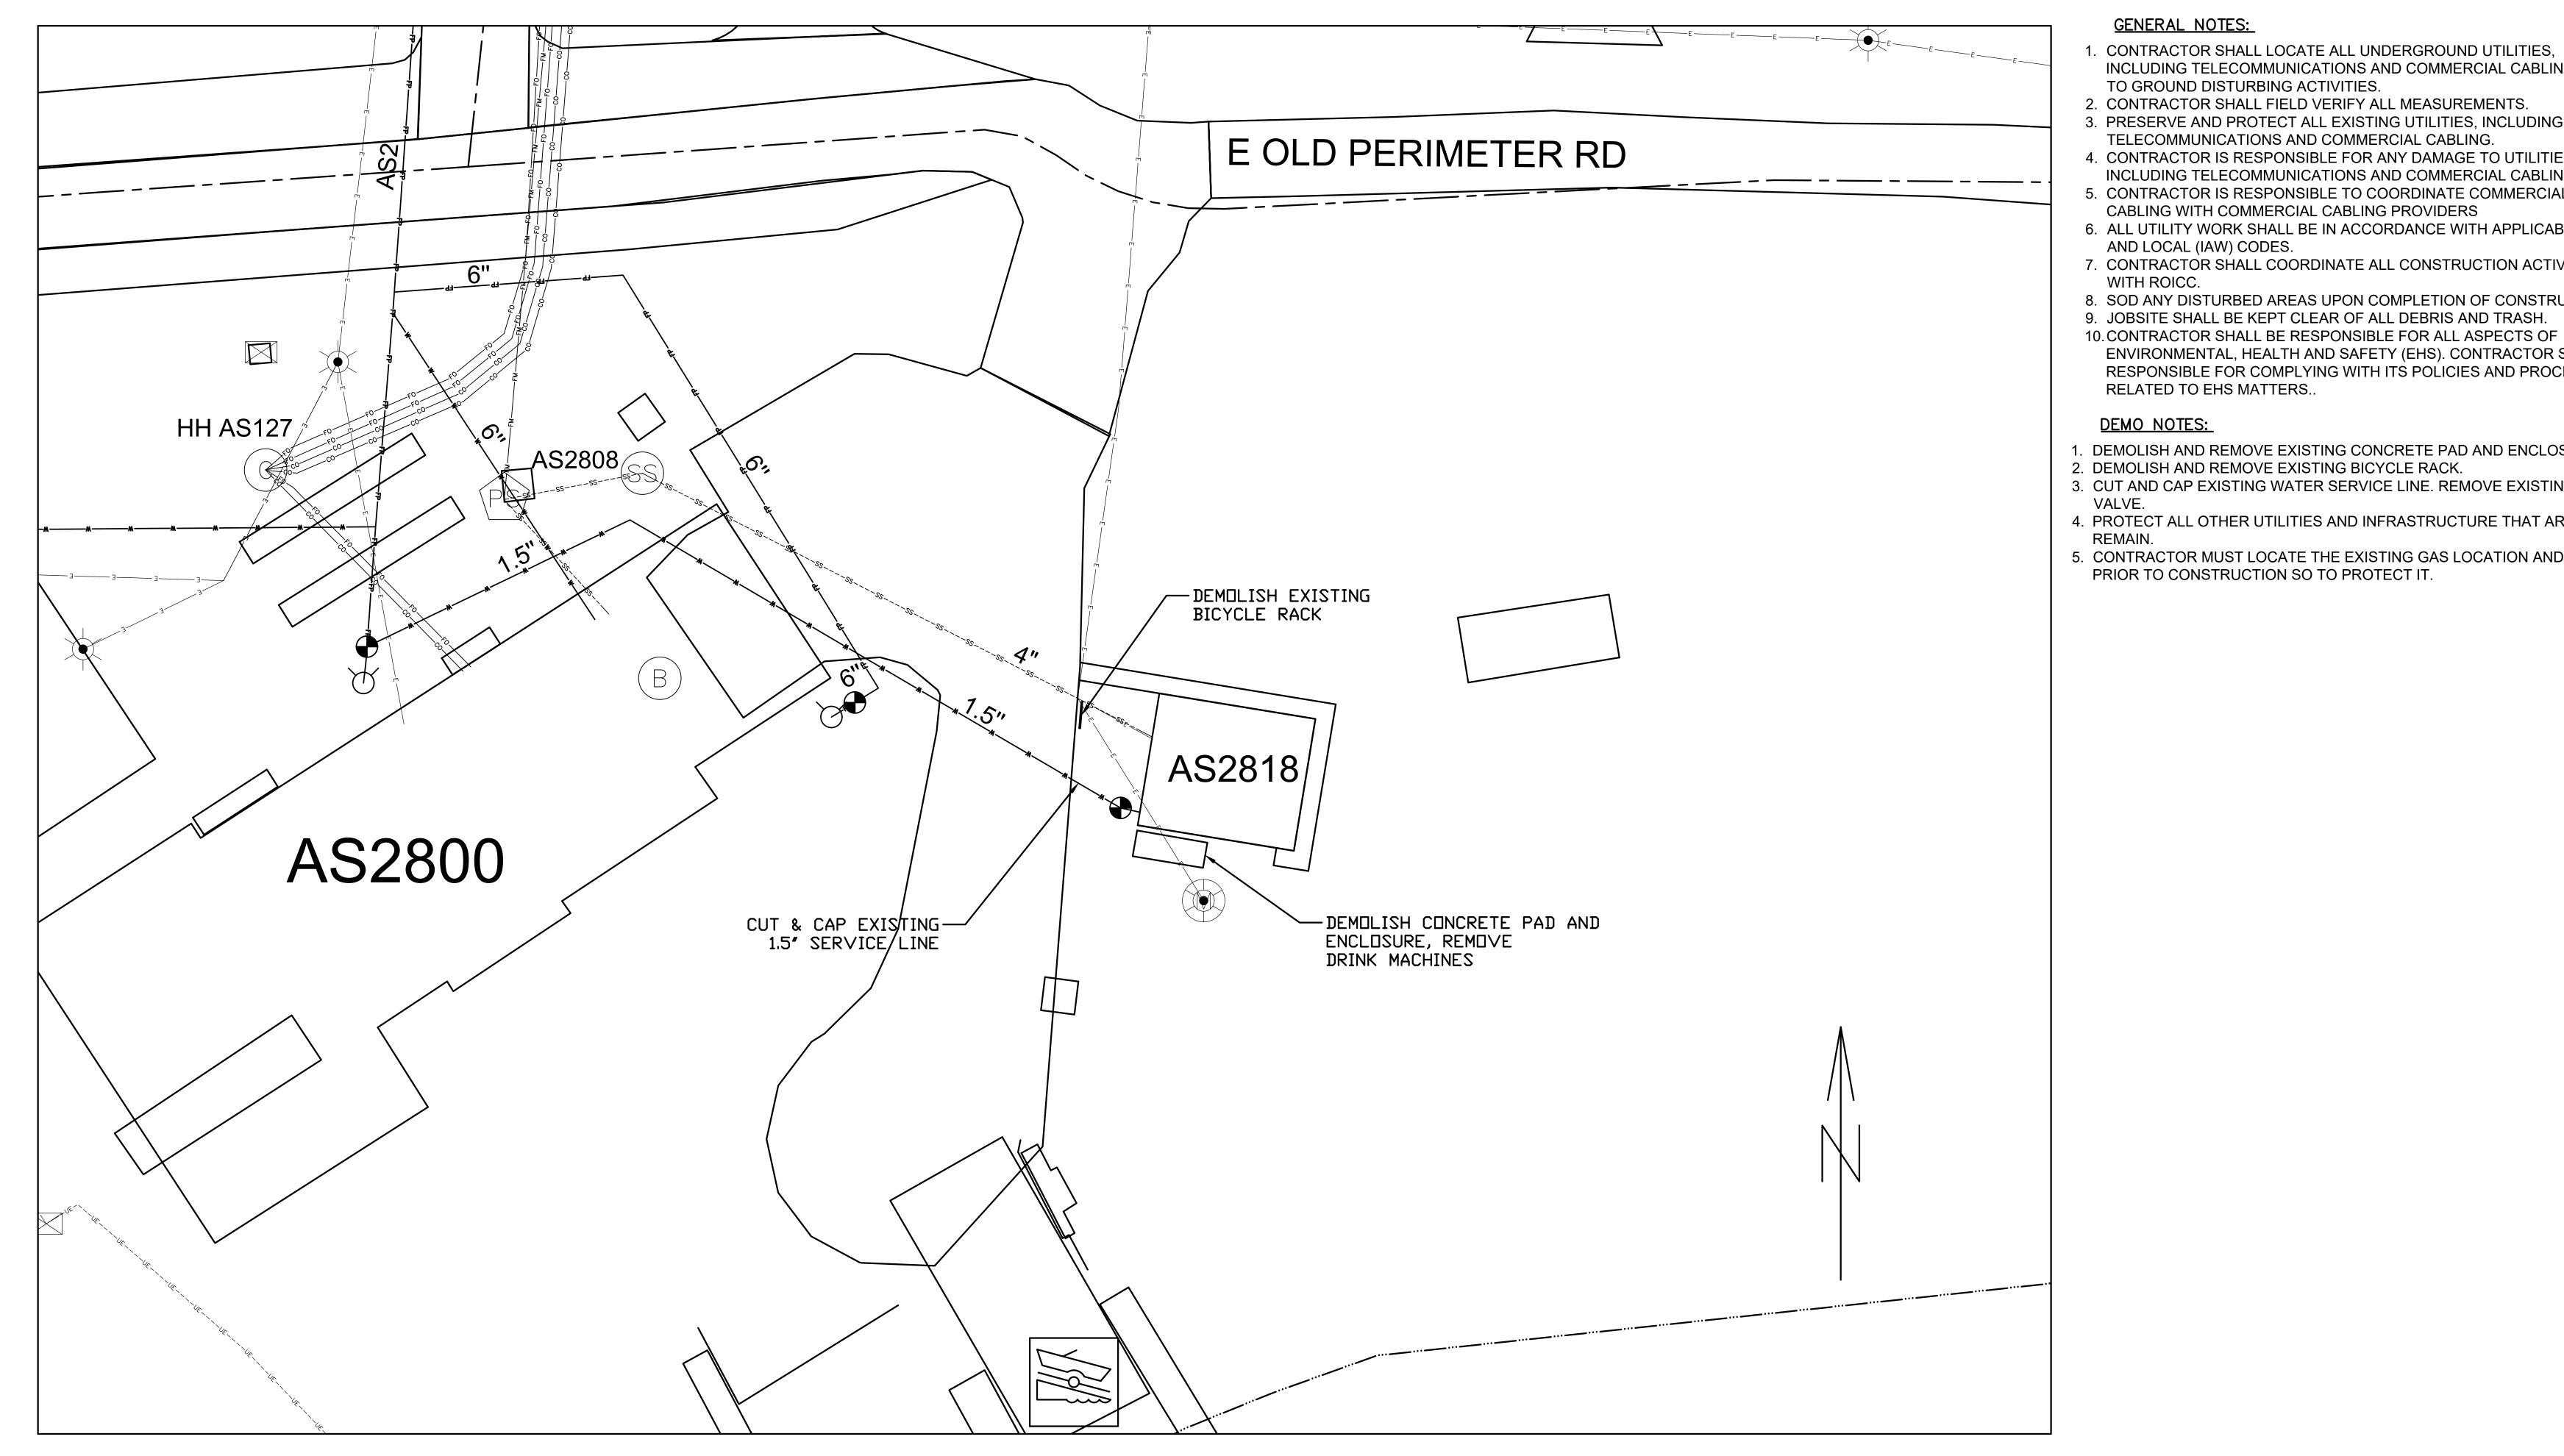

GENERAL NOTES:

- . CONTRACTOR SHALL LOCATE ALL UNDERGROUND UTILITIES, INCLUDING TELECOMMUNICATIONS AND COMMERCIAL CABLING, PRIOR TO GROUND DISTURBING ACTIVITIES.
- 2. CONTRACTOR SHALL FIELD VERIFY ALL MEASUREMENTS.
- 3. PRESERVE AND PROTECT ALL EXISTING UTILITIES, INCLUDING TELECOMMUNICATIONS AND COMMERCIAL CABLING.
- 4. CONTRACTOR IS RESPONSIBLE FOR ANY DAMAGE TO UTILITIES,
- INCLUDING TELECOMMUNICATIONS AND COMMERCIAL CABLING.
- 5. CONTRACTOR IS RESPONSIBLE TO COORDINATE COMMERCIAL CABLING WITH COMMERCIAL CABLING PROVIDERS
- 6. ALL UTILITY WORK SHALL BE IN ACCORDANCE WITH APPLICABLE STATE AND LOCAL (IAW) CODES.
- 7. CONTRACTOR SHALL COORDINATE ALL CONSTRUCTION ACTIVITIES WITH ROICC.
- 8. SOD ANY DISTURBED AREAS UPON COMPLETION OF CONSTRUCTION.
- 9. JOBSITE SHALL BE KEPT CLEAR OF ALL DEBRIS AND TRASH.
- ENVIRONMENTAL, HEALTH AND SAFETY (EHS). CONTRACTOR SHALL BE RESPONSIBLE FOR COMPLYING WITH ITS POLICIES AND PROCEDURES RELATED TO EHS MATTERS..

DEMO NOTES:

- 1. DEMOLISH AND REMOVE EXISTING CONCRETE PAD AND ENCLOSURE.
- 2. DEMOLISH AND REMOVE EXISTING BICYCLE RACK.
- 3. CUT AND CAP EXISTING WATER SERVICE LINE. REMOVE EXISTING GATE
- 4. PROTECT ALL OTHER UTILITIES AND INFRASTRUCTURE THAT ARE TO
- 5. CONTRACTOR MUST LOCATE THE EXISTING GAS LOCATION AND DEPTH PRIOR TO CONSTRUCTION SO TO PROTECT IT.


DISCLOSURE OF INFORMATION CONTRACTOR SHALL COMPLY AS FOLLOWS:

45 DAYS BEFORE THE PROPOSED DATE FOR RELEASE.

- A. THE CONTRACTOR SHALL NOT RELEASE TO ANYONE OUTSIDE THE CONTRACTOR'S ORGANIZATION ANY UNCLASSIFIED INFORMATION, REGARDLESS OF MEDIUM (E.G., FILM, TAPE, DOCUMENT), PERTAINING TO ANY PART OF THIS CONTRACT OR ANY PROGRAM RELATED TO THIS CON- TRACT OR ANY PROGRAM RELATED TO THIS CONTRACT, UNLESS:
 - (1) THE CONTRACTING OFFICER HAS GIVEN PRIOR WRITTEN APPROVAL; OR (2) THE INFORMATION IS OTHERWISE IN THE PUBLIC DOMAIN BEFORE THE DATE OF RELEASE.
- B. REQUESTS FOR APPROVAL SHALL IDENTIFY THE SPECIFIC INFORMATION TO BE RELEASED, THE MEDIUM TO BE USED, AND THE PURPOSE FOR THE RELEASE. THE CONTRACTOR SHALL SUBMIT ITS REQUEST TO THE CONTRACTING OFFICER AT LEAST
- C. THE CONTRACTOR AGREES TO INCLUDE A SIMILAR REQUIREMENT IN EACH SUBCONTRACT UNDER THIS CONTRACT. SUBCONTRACTORS SHALL SUBMIT REQUESTS FOR AUTHORIZATION TO RELEASE THROUGH THE PRIME CONTRACTOR TO THE CONTRACTING OFFICER.

C-101 FINAL DEPARTMENT OF THE NAVY NAVAL FACILITIES ENGINEERING COMMAND MARINE CORPS BASE CAMP LEJEUNE, NORTH CAROLINA DES. MORGAN HUNTER BUILDING AS2818 MATT HORNE HEAD REPAIRS CHK. **KELLY ROOT** SUBMITTED BY: MORGAN HUNTER SITE DEMOLITION PLAN DESIGN DIR. J. FRANK ORR DATE: | SIZE | CODE IDENT. NO APPROVED: PWO OR OICC: NAVFAC DRAWING NO. 60039607 PWO or OICC CONST. CONTR. NO. 22-0005 SATISFACTORY TO: DATE: NA SHEET: 3 OF 22 SCALE: NOTED

SCALE: 1/16"=1'-0"

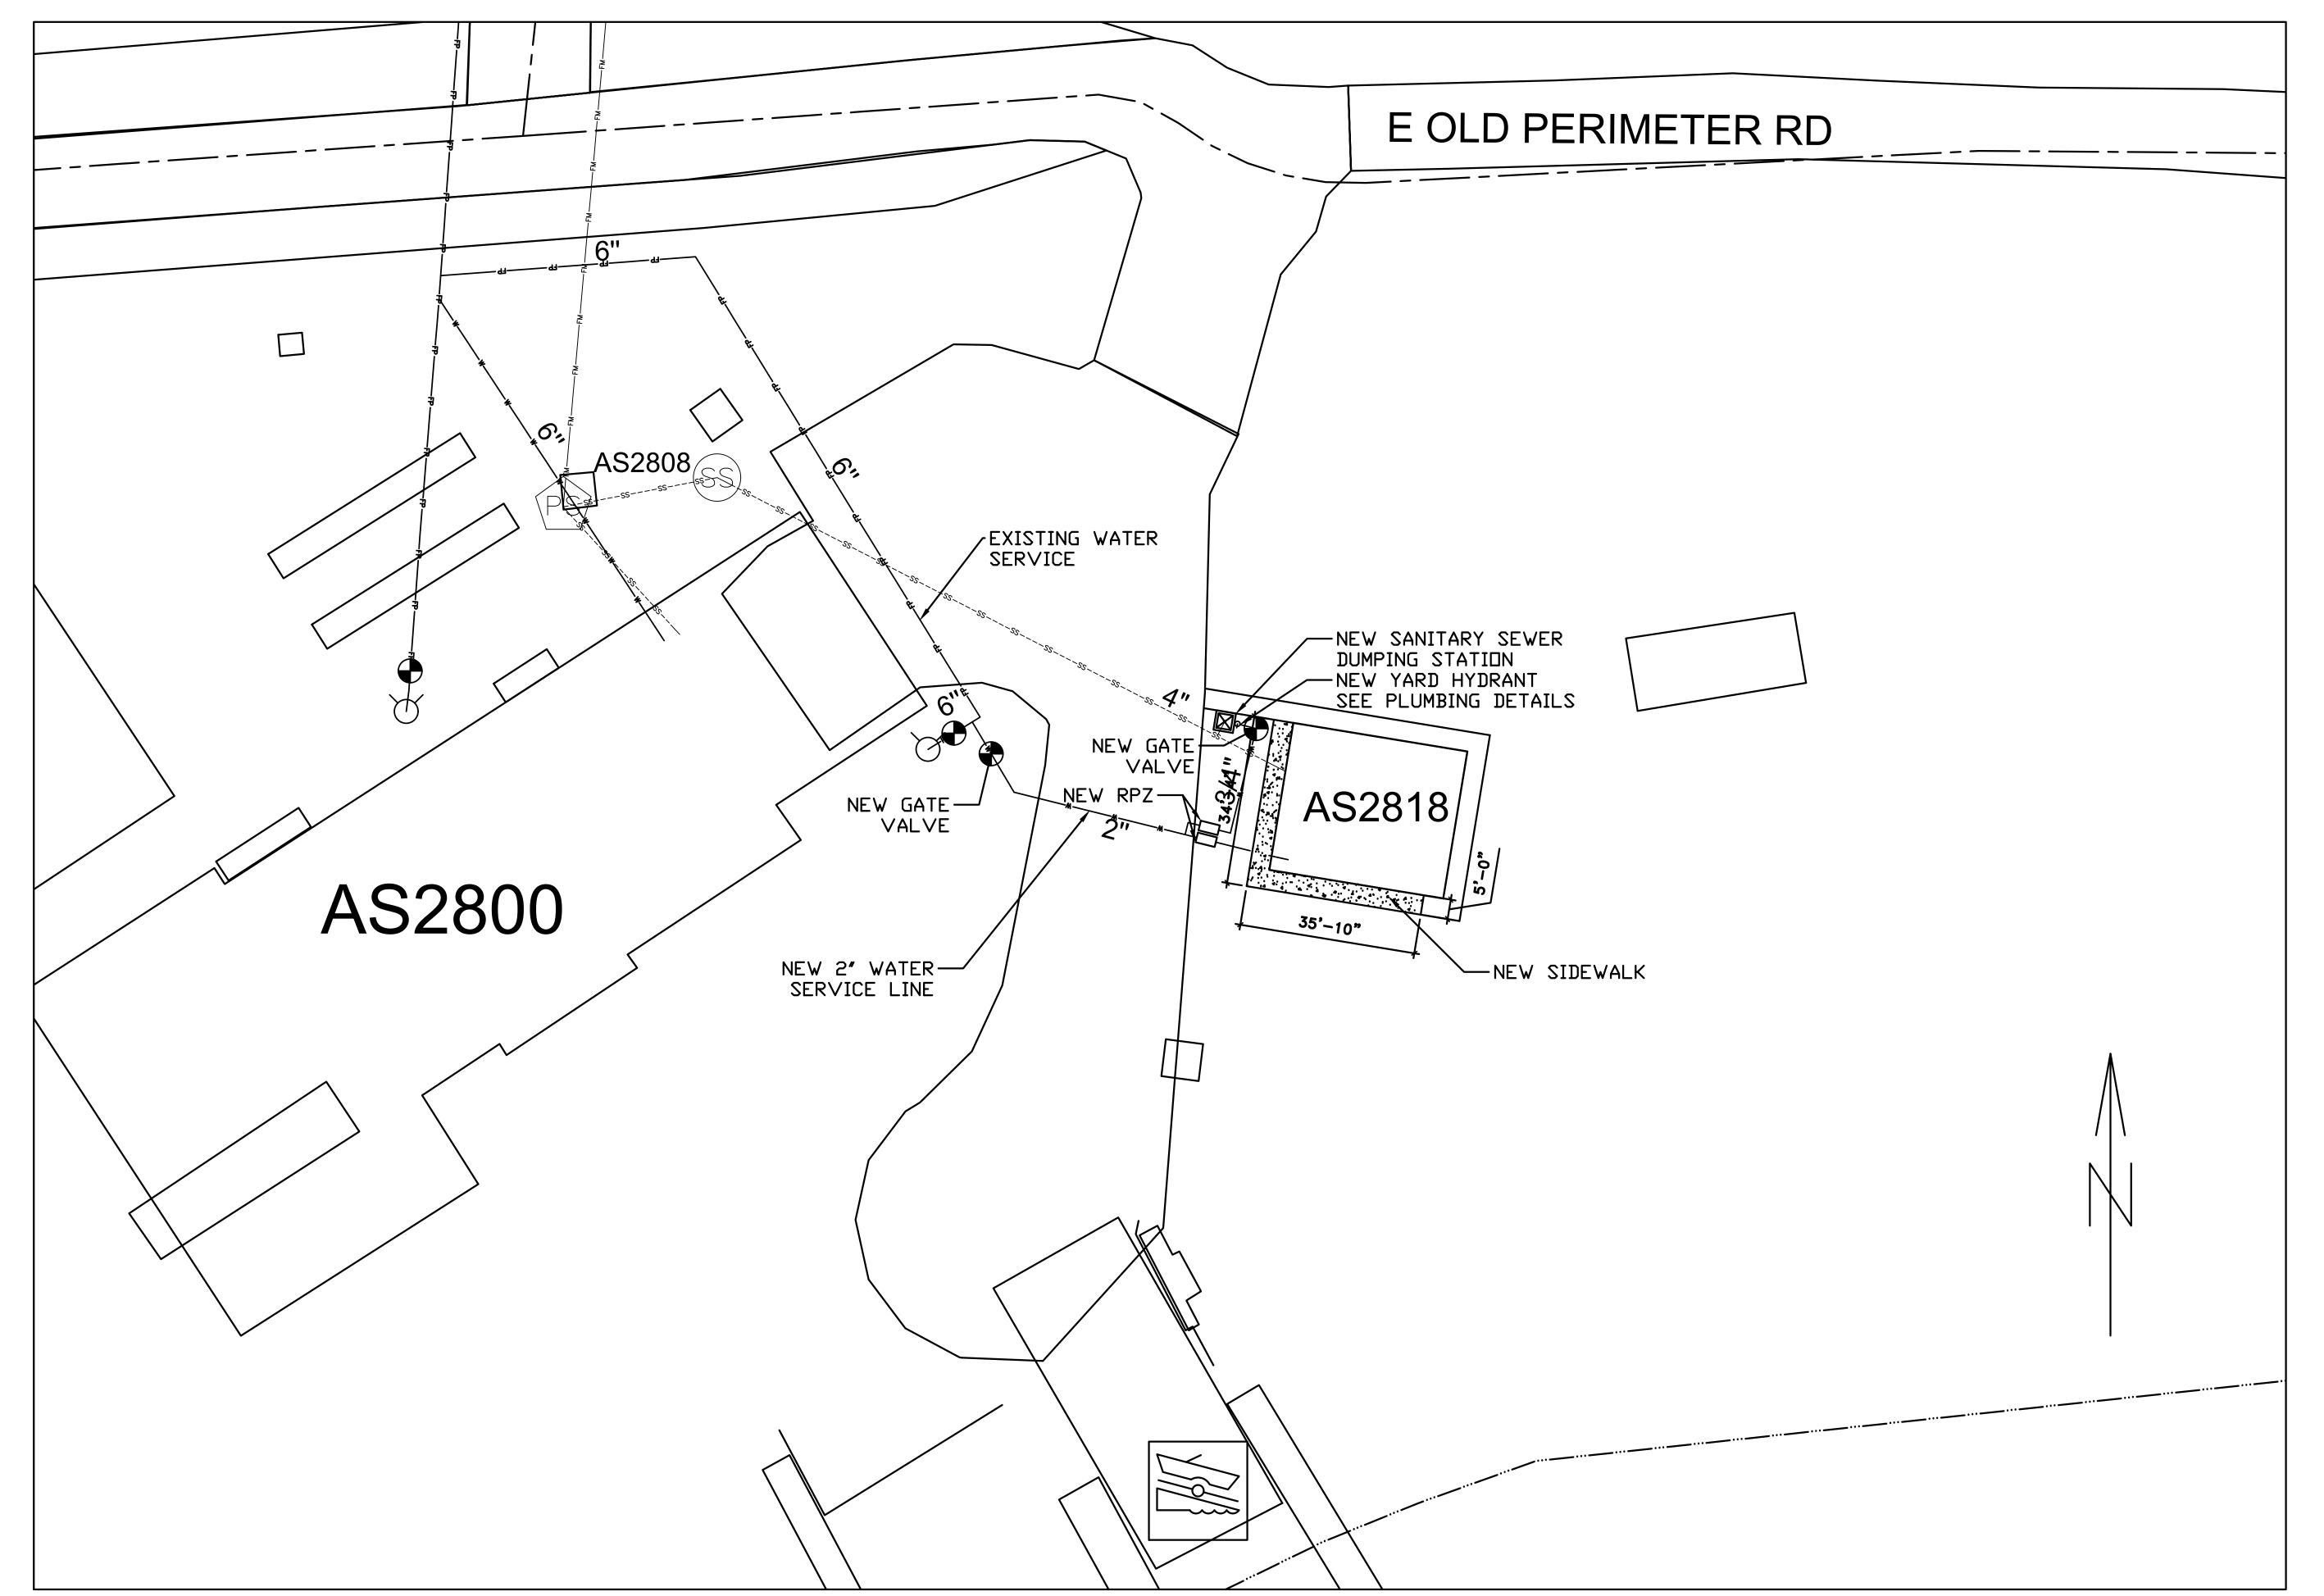

GENERAL NOTES:

- 1. CONTRACTOR SHALL LOCATE ALL UNDERGROUND UTILITIES, INCLUDING TELECOMMUNICATIONS AND COMMERCIAL CABLING, PRIOR TO GROUND DISTURBING ACTIVITIES.
- 2. CONTRACTOR SHALL FIELD VERIFY ALL MEASUREMENTS.
- 3. PRESERVE AND PROTECT ALL EXISTING UTILITIES, INCLUDING TELECOMMUNICATIONS AND COMMERCIAL CABLING.
- 4. CONTRACTOR IS RESPONSIBLE FOR ANY DAMAGE TO UTILITIES,
- INCLUDING TELECOMMUNICATIONS AND COMMERCIAL CABLING.
- 5. CONTRACTOR IS RESPONSIBLE TO COORDINATE COMMERCIAL CABLING WITH COMMERCIAL CABLING PROVIDERS
- 6. ALL UTILITY WORK SHALL BE IN ACCORDANCE WITH APPLICABLE STATE AND LOCAL (IAW) CODES.
- 7. CONTRACTOR SHALL COORDINATE ALL CONSTRUCTION ACTIVITIES
- WITH ROICC.
- 8. SOD ANY DISTURBED AREAS UPON COMPLETION OF CONSTRUCTION.
- 9. JOBSITE SHALL BE KEPT CLEAR OF ALL DEBRIS AND TRASH. 10. CONTRACTOR SHALL BE RESPONSIBLE FOR ALL ASPECTS OF
- ENVIRONMENTAL, HEALTH AND SAFETY (EHS). CONTRACTOR SHALL BE RESPONSIBLE FOR COMPLYING WITH ITS POLICIES AND PROCEDURES RELATED TO EHS MATTERS..

NEW WORK NOTES:


- 1. INSTALL NEW 4" CONCRETE SIDEWALK. PREPARE SUBGRADE PRIOR TO
- PLACING CONCRETE. SEE C102 DETAIL "A".
- 2. INSTALL NEW 2" WATER SERVICE LINE. PROVIDE NEW RPZ AND NEW
- 3. INSTALL NEW SANITARY SEWER DUMPING STATION. SEE C102 DETAIL
- 5. CONTRACTOR MUST LOCATE THE EXISTING GAS LOCATION AND DEPTH PRIOR TO CONSTRUCTION SO TO PROTECT IT.

DISCLOSURE OF INFORMATION CONTRACTOR SHALL COMPLY AS FOLLOWS:


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C-102 FINAL DEPARTMENT OF THE NAVY NAVAL FACILITIES ENGINEERING COMMAND MARINE CORPS BASE CAMP LEJEUNE, NORTH CAROLINA MORGAN HUNTER DES. BUILDING AS2818 MATT HORNE HEAD REPAIRS CHK. **KELLY ROOT** SUBMITTED BY: MORGAN HUNTER NEW WORK SITE PLAN DESIGN DIR. J. FRANKLIN ORR APPROVED: PWO OR OICC: NAVFAC DRAWING NO. DATE: | SIZE | CODE IDENT. NO 60039608 PWO or OICC CONST. CONTR. NO. 22-0005 SATISFACTORY TO: DATE: NA SHEET: 4 OF 22 SCALE: NOTED

SCALE: 1/16"=1'-0" **32**

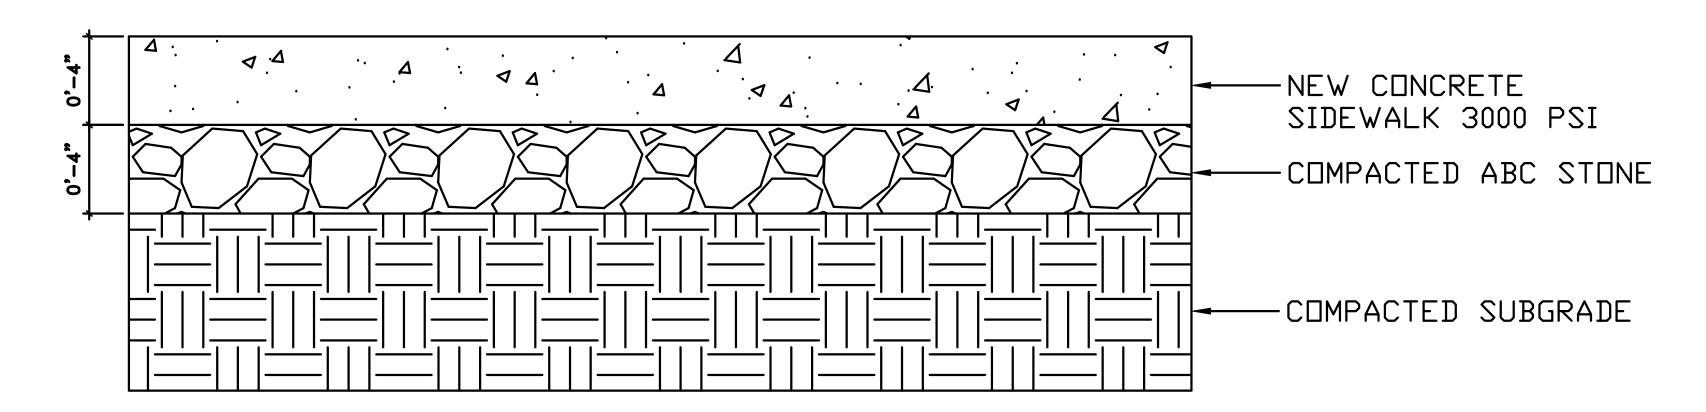

A CONCRETE SIDEWALK SECTION VIEW C102 NOT TO SCALE

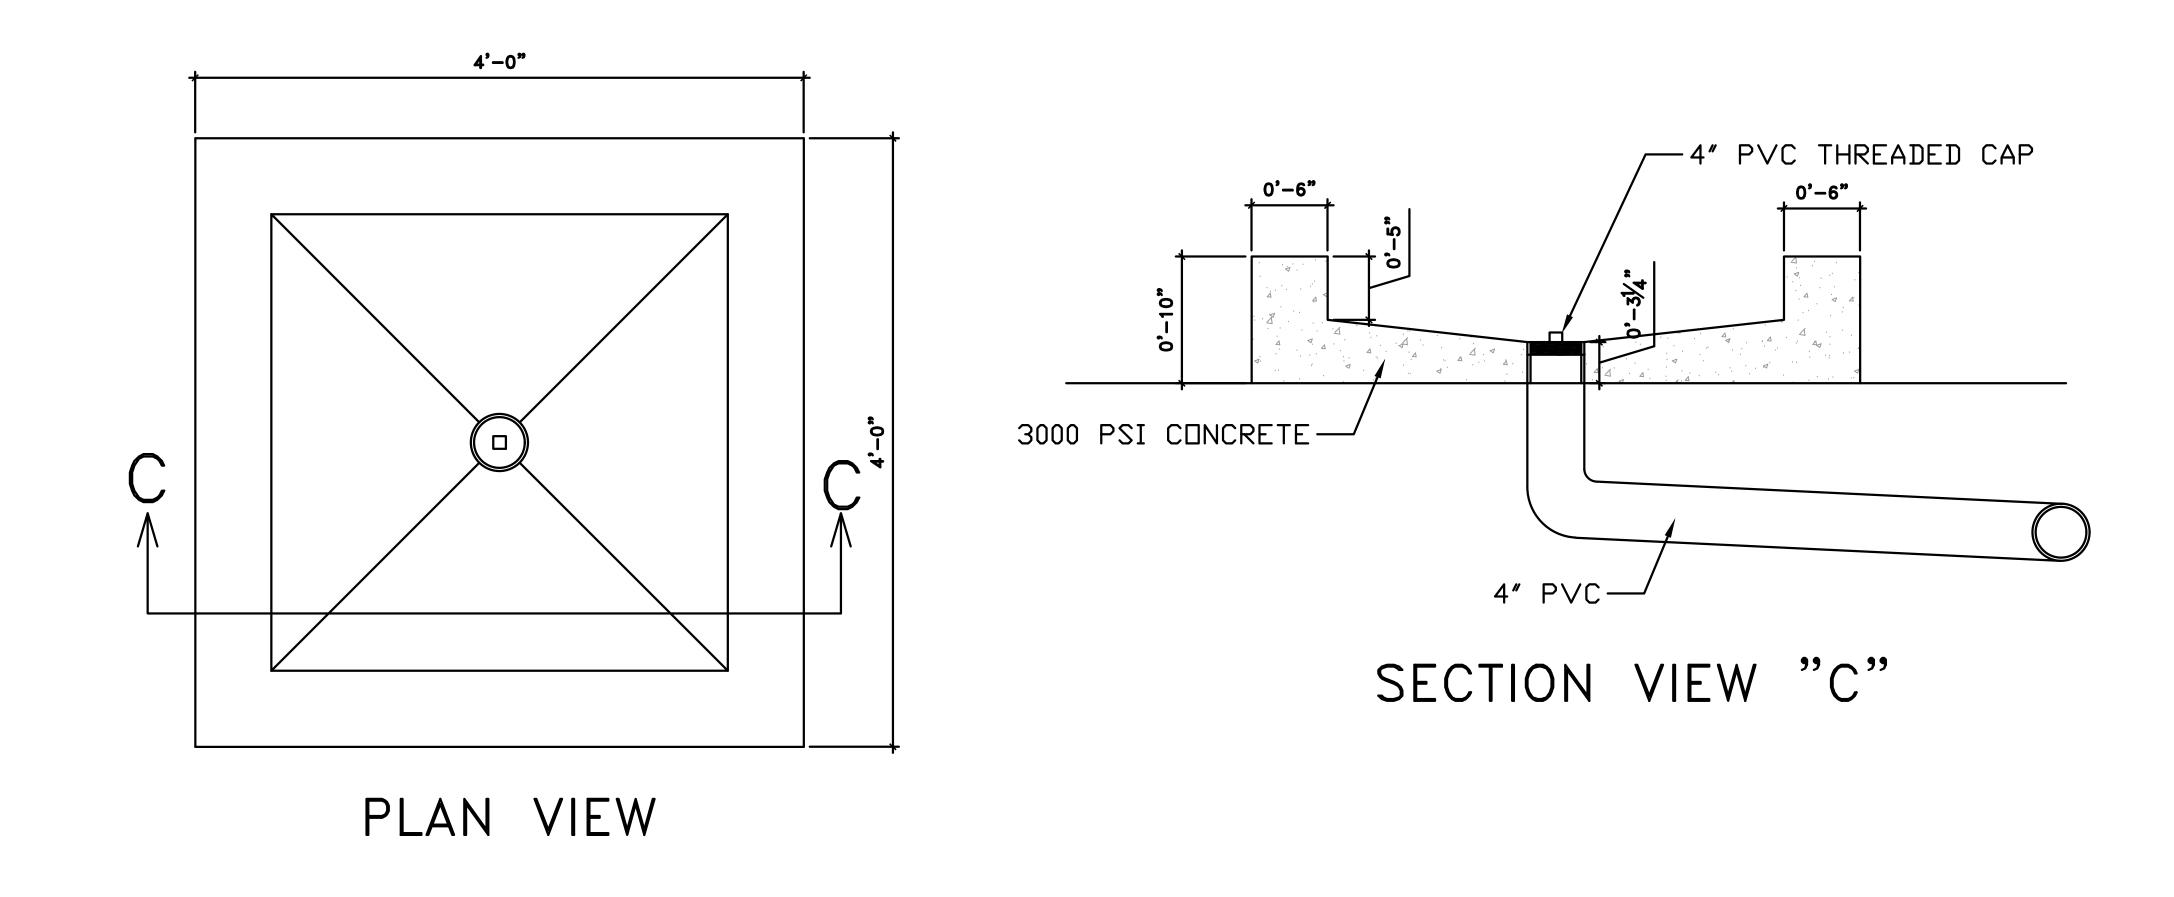


B SANITARY SEWER DUMPING STATION C102 NOT TO SCALE

GENERAL NOTES:

RELATED TO EHS MATTERS..

- CONTRACTOR SHALL LOCATE ALL UNDERGROUND UTILITIES, INCLUDING TELECOMMUNICATIONS AND COMMERCIAL CABLING, PRIOR TO GROUND DISTURBING ACTIVITIES.
- 2. CONTRACTOR SHALL FIELD VERIFY ALL MEASUREMENTS.
- 3. PRESERVE AND PROTECT ALL EXISTING UTILITIES, INCLUDING TELECOMMUNICATIONS AND COMMERCIAL CABLING.
- 4. CONTRACTOR IS RESPONSIBLE FOR ANY DAMAGE TO UTILITIES,
- INCLUDING TELECOMMUNICATIONS AND COMMERCIAL CABLING.
 5. CONTRACTOR IS RESPONSIBLE TO COORDINATE COMMERCIAL
- CABLING WITH COMMERCIAL CABLING PROVIDERS
- 6. ALL UTILITY WORK SHALL BE IN ACCORDANCE WITH APPLICABLE STATE
- AND LOCAL (IAW) CODES.
 7. CONTRACTOR SHALL COORDINATE ALL CONSTRUCTION ACTIVITIES
- WITH ROICC.
- 8. SOD ANY DISTURBED AREAS UPON COMPLETION OF CONSTRUCTION.
- 9. JOBSITE SHALL BE KEPT CLEAR OF ALL DEBRIS AND TRASH.
 10. CONTRACTOR SHALL BE RESPONSIBLE FOR ALL ASPECTS OF
- ENVIRONMENTAL, HEALTH AND SAFETY (EHS). CONTRACTOR SHALL BE RESPONSIBLE FOR COMPLYING WITH ITS POLICIES AND PROCEDURES

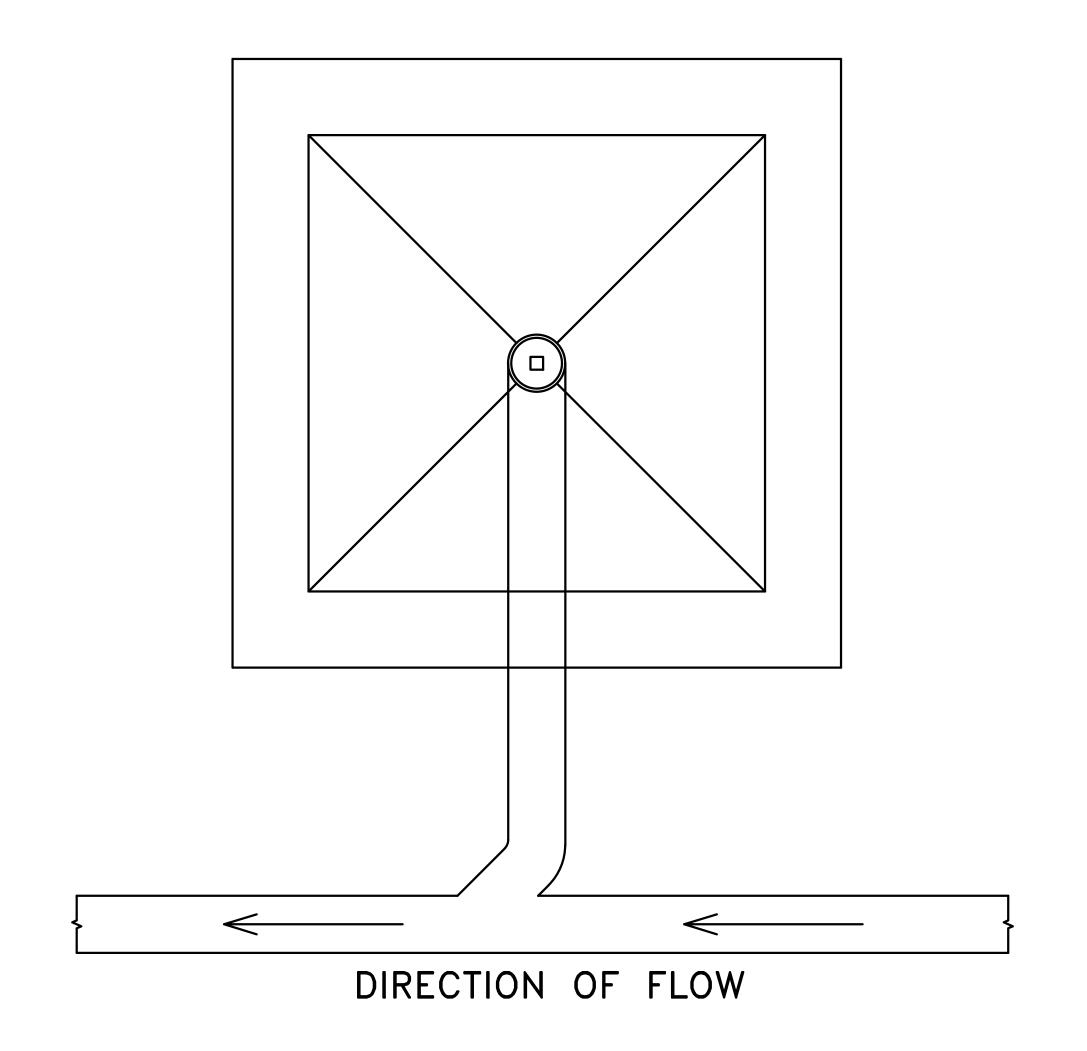


- A. THE CONTRACTOR SHALL NOT RELEASE TO ANYONE OUTSIDE THE CONTRACTOR'S ORGANIZATION ANY UNCLASSIFIED INFORMATION, REGARDLESS OF MEDIUM (E.G., FILM, TAPE, DOCUMENT), PERTAINING TO ANY PART OF THIS CONTRACT OR ANY PROGRAM RELATED TO THIS
- CONTRACT, UNLESS:

 (1) THE CONTRACTING OFFICER HAS GIVEN PRIOR WRITTEN APPROVAL; OR

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- B. REQUESTS FOR APPROVAL SHALL IDENTIFY THE SPECIFIC INFORMATION TO BE RELEASED, THE MEDIUM TO BE USED, AND THE PURPOSE FOR THE RELEASE. THE CONTRACTOR SHALL SUBMIT ITS REQUEST TO THE CONTRACTING OFFICER AT LEAST 45 DAYS BEFORE THE PROPOSED DATE FOR RELEASE.
- C. THE CONTRACTOR AGREES TO INCLUDE A SIMILAR REQUIREMENT IN EACH SUBCONTRACT UNDER THIS CONTRACT. SUBCONTRACTORS SHALL SUBMIT REQUESTS FOR AUTHORIZATION TO RELEASE THROUGH THE PRIME CONTRACTOR TO THE CONTRACTING OFFICER.

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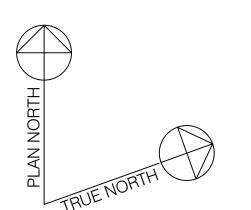
REMOVAL, APPROXIMATELY 740 S.F. SEE PLUMBING FOR ADDITIONAL NOTES. REMOVE EXISTING CMU WALL AS INDICATED. REMOVE EXTERIOR CMU WALL (3'-4") TO RECEIVE NEW DOOR. REMOVE DOOR, FRAME, ANCHORS AND OTHER RELATED ITEMS. REMOVE WINDOW, FRAME, ANCHORS, CAULKING, AND OTHER RELATED ITEMS. REMOVE EXISTING CEILING, INSULATION, AND LIGHTING. EXHAUST FANS AND ALL ASSOCIATED SWITCHES/WIRING/CIRCUITS. SEE ELECTRICAL DEMOLITION FOR ADDITIONAL DETAILS. REMOVE ALL SHOWER ITEMS INCLUDING FLOOR DRAIN. SEE PLUMBING DEMOLITION FOR ADDITIONAL DETAILS. REMOVE TOILET PARTITIONS, SUPPORTS, HARDWARE, ACCESSORIES, ANCHORS, AND OTHER RELATED ITEMS.		DEMOLITION NOTES 📈
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PAPER HOLDER, ETC. REMOVE BENCHES AND ASSOCIATED HARDWARE. REPAIR CMU WALL WHERE NOT BEING DEMOLISHED. REMOVE ALL FIXTURES (SINKS, TOILETS, URINALS). REMOVE ALL ASSOCIATED PIPING COMPLETE. REMOVE EXISTING CHANGING TABLES. REMOVE EXISTING WATER COOLERS. PRESERVE AND PROTECT SIDEWALK. SEE CIVIL FOR ADDITIONAL NOTES.	8	REMOVE TOILET PARTITIONS, SUPPORTS, HARDWARE, ACCESSORIES, ANCHORS, AND OTHER RELATED ITEMS.
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	13	REMOVE EXISTING WATER COOLERS.
15 PREPARE EXISTING CMU WALL FOR NEW PAINT.	14	PRESERVE AND PROTECT SIDEWALK. SEE CIVIL FOR ADDITIONAL NOTES.
	15	PREPARE EXISTING CMU WALL FOR NEW PAINT.

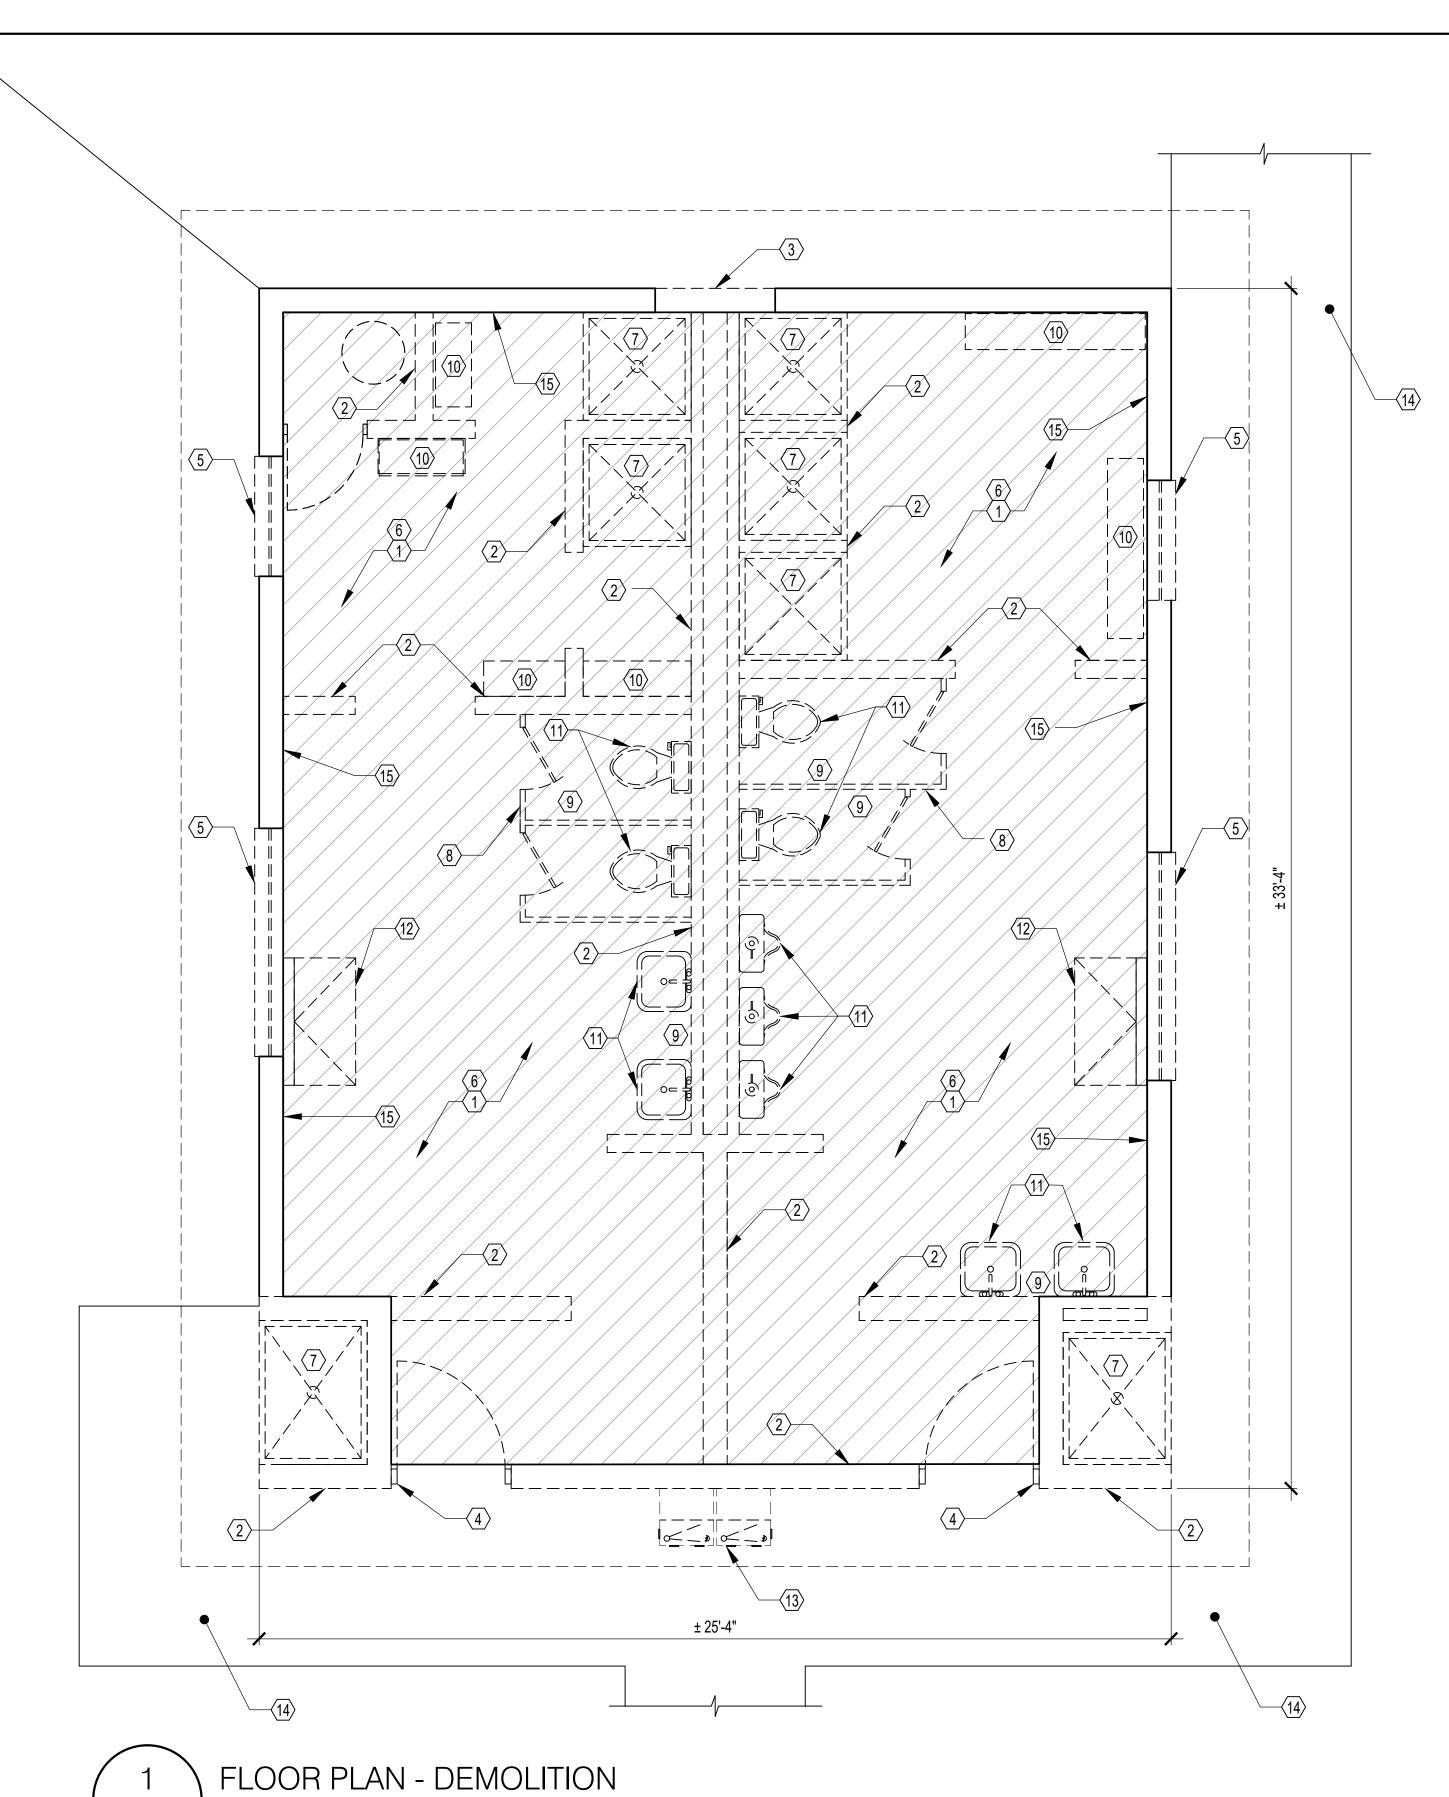DEMOLITION LEGEND - PLANS

EXISTING CMU WALLS TO REMAIN


CMU WALLS, DOORS, FRAMES, WINDOWS, FIXTURES AND EQUIPMENT TO BE REMOVED

LIMITS OF FLOOR SLAB DEMOLITION



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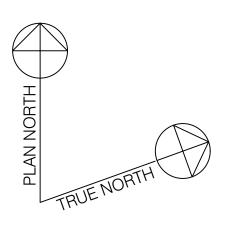
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1 FLOOR PLAN - RENOVATION
A-102 3/8"= 1'-0"


	RENOVATION NOTES 💉
NO.	NOTE
1	PROVIDE NEW 4" CONCRETE SLAB AFTER NEW PLUMBING PIPING IS IN PLACE. SLOPE TO NEW FLOOR DRAINS ($\frac{1}{4}$ " PERFOOT OF LENGTH). MATCH EXISTING SIDEWALK ELEVATIONS AT ENTRY POINTS. SEE PLUMBING FOR ADDITIONAL NOTES. SEE FINISH SCHEDULE FOR FLOOR FINISH, SHEET A-102.
2	PROVIDE CMU WALL TO 8'-8" A.F.F. PAINT. TYPICAL OF 8" CMU, 6" CMU, AND 4" CMU. LOCATIONS NOTED IN NOTES 2A, 2B, AND 2C.
2A	PROVIDE 8" CMU WALL.
2B	PROVIDE 6" CMU WALL.
2C	PROVIDE 4" CMU WALL.
3	INSTALL NEW EXTERIOR STEEL DOOR, FRAME, AND HARDWARE. PAINT. PROVIDE STEEL LINTEL AT NEW MASONRY OPENING. SEE DOOR SCHEDULE, SHEET A-601.
4	INSTALL NEW STEEL DOOR, FRAME, AND HARDWARE. PAINT. PROVIDE STEEL LINTEL AT NEW MASONRY OPENING. SEE DOOR SCHEDULE, SHEET A-601.
5	INSTALL NEW WINDOW. SEE WINDOW SCHEDULE, SHEET A-601.
6	PROVIDE MOISTURE RESISTANT GWB-PTD CEILING 8'-8" A.F.F. AND INSULATION. SEE ELECTRICAL DRAWINGS.
7	PROVIDE CONCRETE SHOWER PAN. SLOPE TO FLOOR DRAINS 1/4" PER FOOT OF LENGTH.
8	PROVIDE THROUGH-BODY COLOR PHENOLIC TOILET PARTITIONS, SUPPORTS, HARDWARE, ACCESSORIES, ANCHORS, AND OTHER RELATED ITEMS. TOILET COMPARTMENTS (5) TOTAL. URINAL SCREENS (2) TOTAL.
9	PROVIDE NEW PLUMBING FIXTURE. SEE PLUMBING FOR ADDITIONAL NOTES.
10	PROVIDE NEW WATER COOLERS. SEE PLUMBING FOR ADDITIONAL NOTES.
11	PROVIDE NEW SIDEWALK. PRESSURE WASH EXISTING SIDEWALK. SEE CIVIL FOR ADDITIONAL NOTES.
12	PATCH AND REPAIR EXISTING CMU WALL. PREPARE EXISTING CMU WALLS (INTERIOR AND EXTERIOR) FOR NEW FINISHES PER MANUFACTURER'S RECOMMENDATIONS. PAINT NEW AND EXISTING CMU WALL. SEAL CMU PER MANUFACTURER'S RECOMMENDATIONS. SEE FINISH SCHEDULE, SHEET A-102.
13	PROVIDE TOILET ACCESSORIES INCLUDING PAPER TOWEL DISPENSER, SOAP DISPENSER, GRAB BARS, TOILET PAPER HOLDER, CHANGING TABLES, ETC. SEE TOILET ACCESSORIES SCHEDULE, SHEET A-401.
14	PROVIDE STAINLESS STEEL UTILITY SINK, 24"X24"

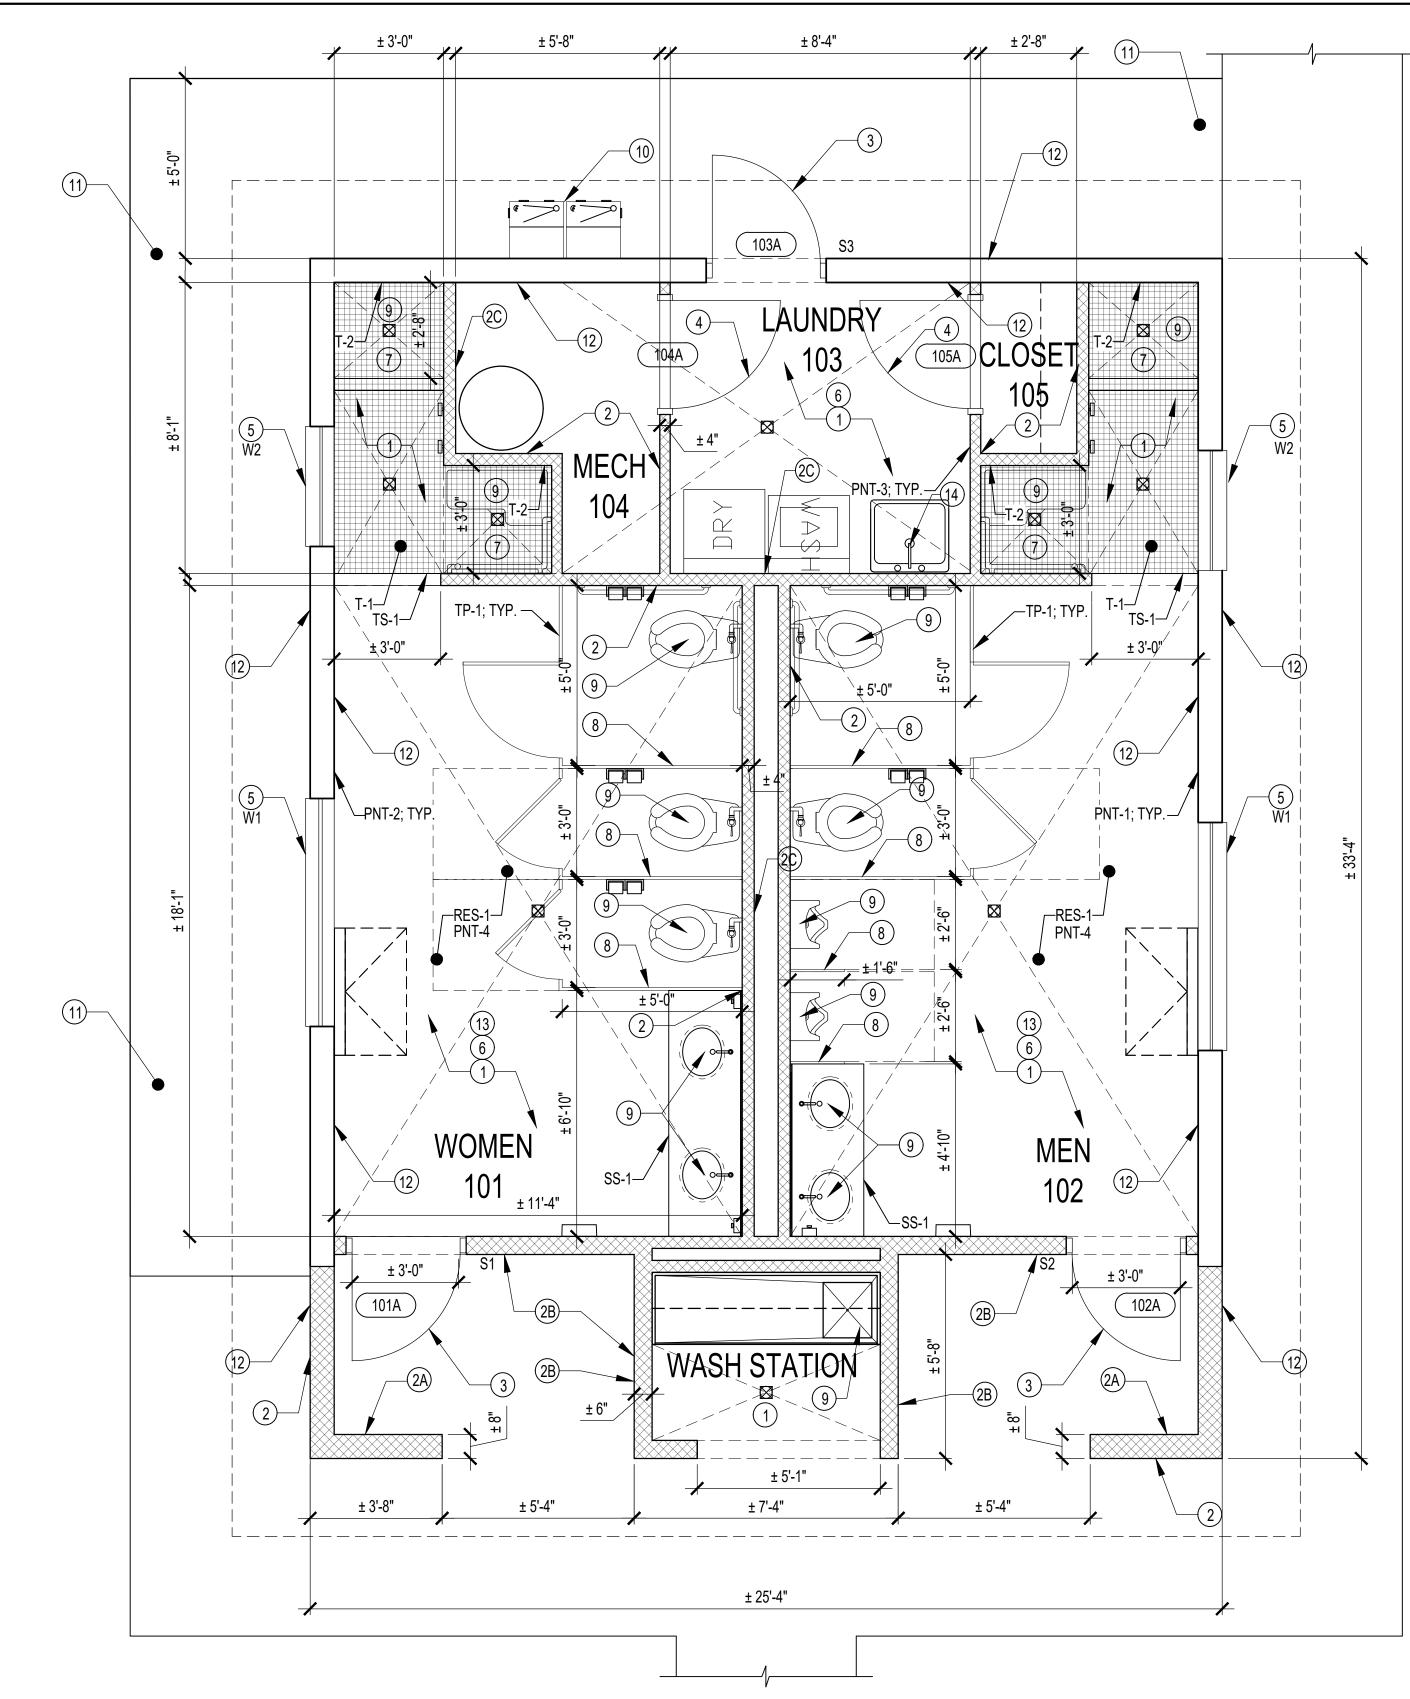	FINISH SCHEDULE							
CODE	DESCRIPTION	BASIS OF DESIGN	NOTES					
T-1	PORCELAIN TILE	MANUFACTURER: DALTILE PRODUCT: HAUT MONDE; STONE ATTACHE COLLECTION; COLORBODY PORCELAIN TILE COLOR: TBD; PROVIDE SAMPLES FOR GOVERNMENT REVIEW. SIZE: 2"X2" MOSAIC	TO BE USED ON FLOORS IN SHOWER AREA. PROVIDE 4" COVE BASE IN SHOWER AREA.					
T-2	PORCELAIN TILE	MANUFACTURER: DALTILE PRODUCT: HAUT MONDE; STONE ATTACHE COLLECTION; COLORBODY PORCELAIN TILE COLOR: TBD; PROVIDE SAMPLES FOR GOVERNMENT REVIEW. SIZE: 12"X24"; VERTICAL INSTALL.	TO BE USED ON SHOWER WALLS.					
GR-1	GROUT	MANUFACTURER: CUSTOM COLOR: TBD; PROVIDE SAMPLES FOR GOVERNMENT REVIEW.	TO BE USED ON FLOORS AND WALLS.					
RES-1		MANUFACTURER: STONHARD COLOR: TBD; PROVIDE SAMPLES FOR GOVERNMENT REVIEW.	TO BE USED ON FLOORS IN RESTROOM AREA. PROVIDE 4" EPOXY COVE BASE.					
PNT-1	ACRYLIC PAINT FINISH	MANUFACTURER: SHERWIN WILLIAMS COLOR: TBD. PROVIDE SAMPLES FOR GOVERNMENT REVIEW.	MEN'S HEAD. EGGSHELL FINISH. PAINTED CMU.					
PNT-2	ACRYLIC PAINT FINISH	MANUFACTURER: SHERWIN WILLIAMS COLOR: TBD. PROVIDE SAMPLES FOR GOVERNMENT REVIEW.	WOMEN'S HEAD. EGGSHELL FINISH. PAINTED CMU.					
PNT-3	ACRYLIC PAINT FINISH	MANUFACTURER: SHERWIN WILLIAMS COLOR: TBD. PROVIDE SAMPLES FOR GOVERNMENT REVIEW.	LAUNDRY ROOM. EGGSHELL FINISH. PAINTED CMU.					
PNT-4	ACRYLIC PAINT FINISH	MANUFACTURER: SHERWIN WILLIAMS COLOR: HIGH REFLECTIVE WHITE.	EGGSHELL FINISH. PAINTED MOISTURE RESISTANT GYPSUM BOARD. CEILING.					
TS-1	TRANSITION STRIP	MANUFACTURER: SCHLUTER MATERIAL: STAINLESS STEEL 304	TRANSITION FROM STANDARD RESINOUS FLOORING TO 2"x2" MOSAIC TILE. MODEL OPTIONS: DECO - IF NO TRANSITION BETWEEN HEIGHTS REQUIRED RENO-TK - IF TRANSITION BETWEEN DIFFERING HEIGHTS IS REQUIRED					
TP-1	TOILET PARTITIONS	MANUFACTURER: ASI GLOBAL PARTITIONS MATERIAL: COLOR THRU PHENOLIC COLOR: TBD; PROVIDE SAMPLES FOR GOVERNMENT REVIEW.	OVERHEAD-BRACED COMPARTMENTS					
SS-1	SOLID SURFACE COUNTERTOP	MANUFACTURER: CORIAN COLOR: TBD; PROVIDE SAMPLES FOR GOVERNMENT REVIEW.	SEE DETAIL SHEET 4/A-401.					




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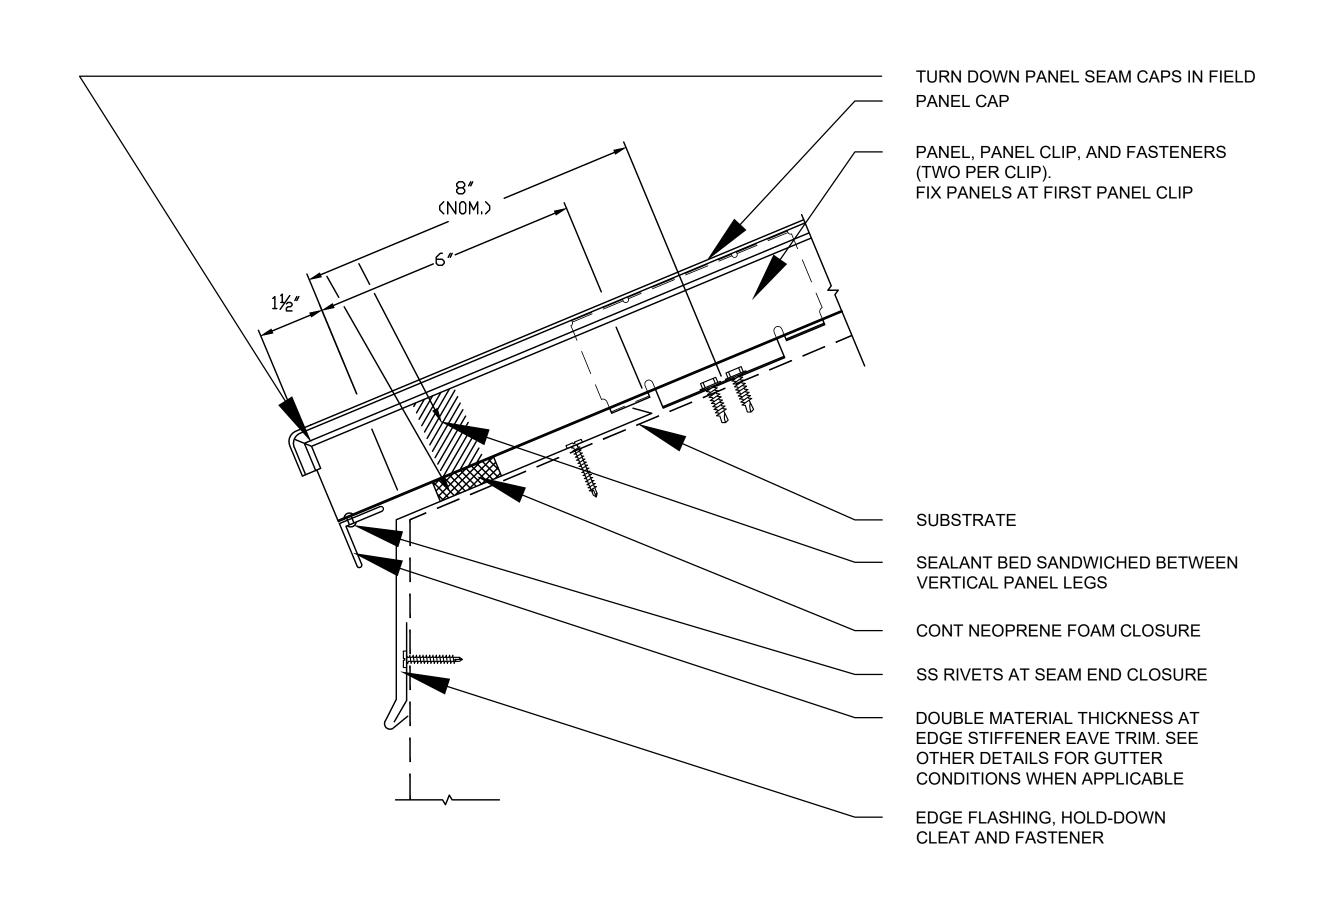
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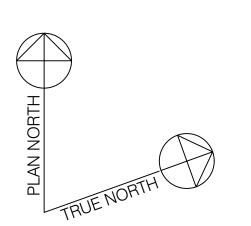
	ROOF PLAN NOTES							
NO.	DESCRIPTION	DEMOLITION NOTE	RENOVATION NOTE					
1	ROOFING SYSTEM	DEMOLISH ASPHALT SHINGLES, FLASHING, TRIM ITEMS, VAPOR BARRIER, AND OTHER RELATED ITEMS	STANDING SEAM METAL ROOFING (TYPICAL) PER SPECS AND DETAILS.					
2	SUBSTRATE AND WOOD BLOCKING	REMOVE ALL UNSUITABLE MATERIALS AS INDICATED IN THE CONSTRUCTION DOCUMENTS. BRING TO THE ATTENTION OF THE GOVERNMENT SCOPE OF WORK DEEMED TO NOT BE INCLUDED.	REPLACE AS NECESSARY (ASSUME 10% FOR BIDDING PURPOSES)					
3	RIDGE	DEMO RIDGE ITEMS AND OTHER RELATED ITEMS.	PROVIDE RIDGE. SEE DETAIL1/A-501.					
4	LOUVERS	DEMOLISH LOUVERS, FLASHING, TRIM, AND OTHER RELATED ITEMS.	PROVIDE LOUVERS. SEE DETAIL 3/A-501.					
5	VENTS	PROTECT VENT AS NECESSARY. DEMOLISH BOOT VENT, FLASHING, AND OTHER RELATED ITEMS.	PROVIDE VENTS. SEE DETAIL 7/A-501. SEE MECHANICAL FOR ADDITIONAL NOTES.					
6	FASCIA BOARDS AND TRIM	DEMOLISH ALL ITEMS.	PROVIDE FASCIA AND TRIM. SEE DETAIL 2/A-103.					
7	EXTERIOR SOFFIT	DEMOLISH ALL ITEMS.	PROVIDE EXTERIOR SOFFIT. SEE DETAIL 2/A-103.					

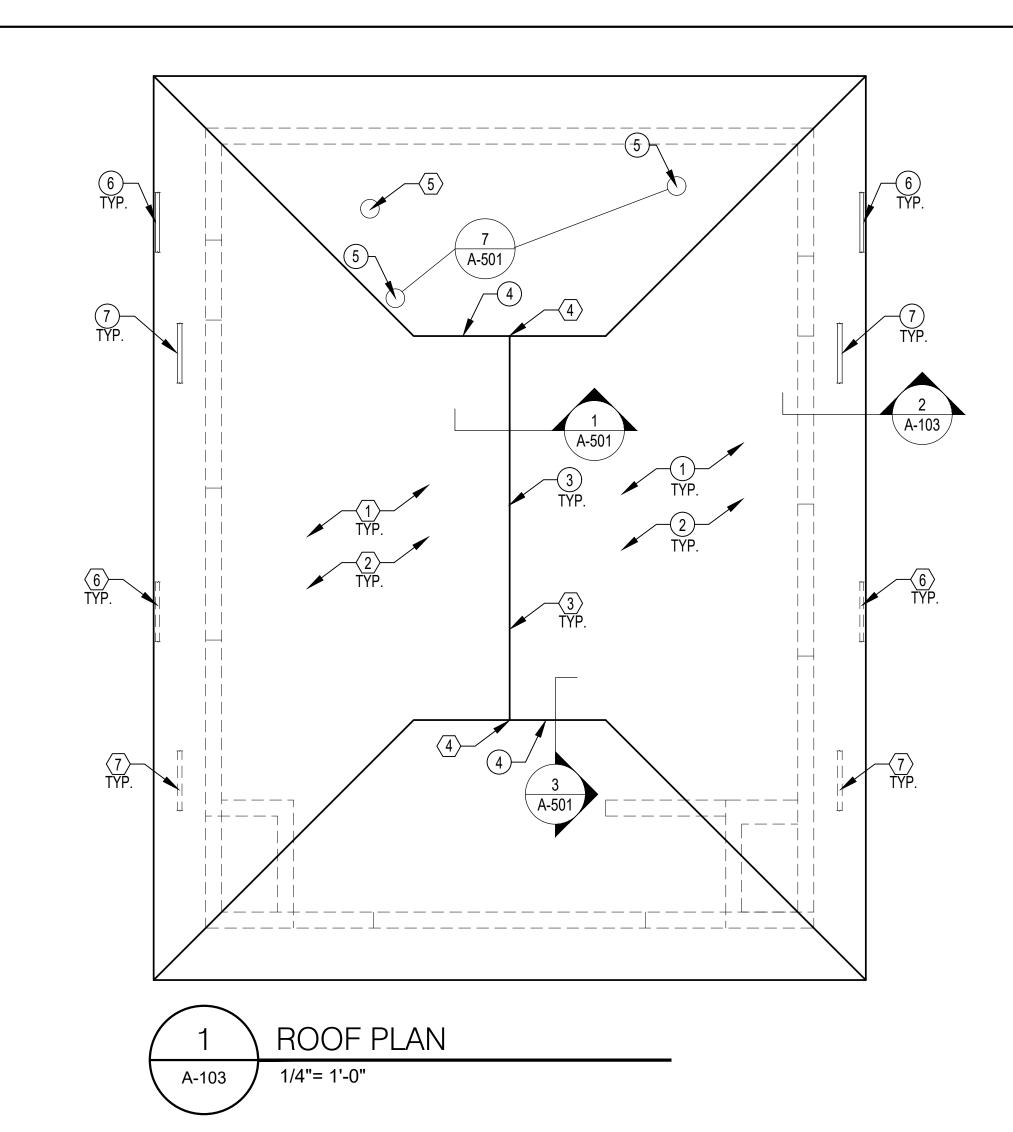

ROOF EDGE DETAIL




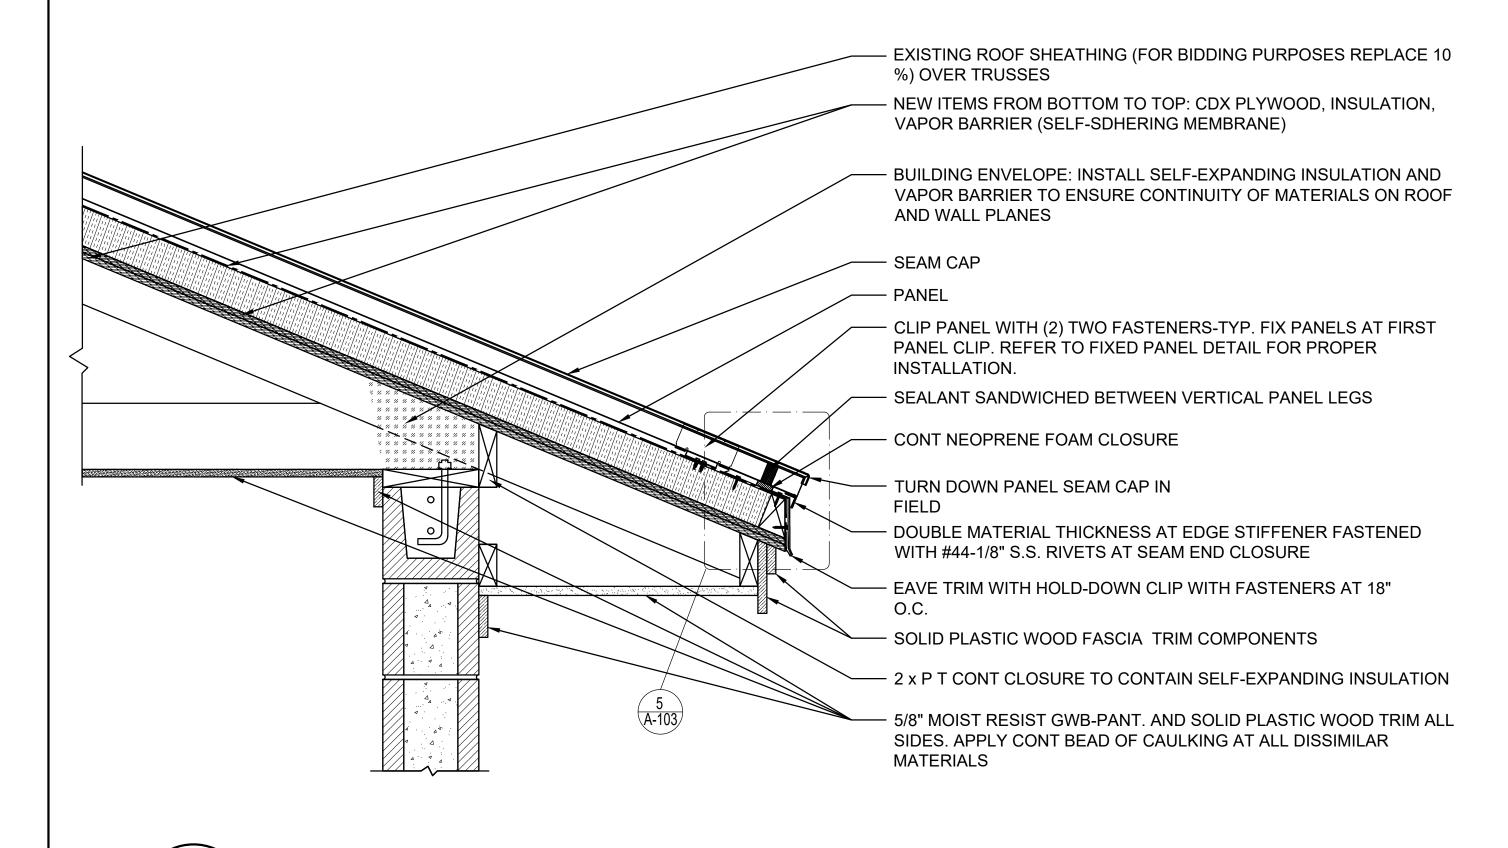




- A. THE CONTRACTOR SHALL NOT RELEASE TO ANYONE OUTSIDE THE CONTRACTOR'S ORGANIZATION ANY UNCLASSIFIED INFORMATION, REGARDLESS OF MEDIUM (E.G., FILM, TAPE, DOCUMENT), PERTAINING TO ANY PART OF THIS CONTRACT OR ANY PROGRAM RELATED TO THIS CONTRACT, UNLESS:
 - (1) THE CONTRACTING OFFICER HAS GIVEN PRIOR WRITTEN APPROVAL; OR
 (2) THE INFORMATION IS OTHERWISE IN THE PUBLIC DOMAIN BEFORE THE DATE OF RELEASE.
- B. REQUESTS FOR APPROVAL SHALL IDENTIFY THE SPECIFIC INFORMATION TO BE RELEASED, THE MEDIUM TO BE USED, AND THE PURPOSE FOR THE RELEASE. THE CONTRACTOR SHALL SUBMIT ITS REQUEST TO THE CONTRACTING OFFICER AT LEAST 45 DAYS BEFORE THE PROPOSED DATE FOR RELEASE.
- C. THE CONTRACTOR AGREES TO INCLUDE A SIMILAR REQUIREMENT IN EACH SUBCONTRACT UNDER THIS CONTRACT. SUBCONTRACTORS SHALL SUBMIT REQUESTS FOR AUTHORIZATION TO RELEASE THROUGH THE PRIME CONTRACTOR TO THE CONTRACTING OFFICER.

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			NE CORI	PS BAS	E
DES. M. HUNTER		RH	ILDING AS	52818	
DR. M. HUNTER					
CHK. K. ROOT, R.A.		Н	EAD REP	AIRS	
SUBMITTED BY: M. HUNTER		POC	F PLAN AND	DETAILS	
DESIGN DIR. J. FRANKLIN ORR, P.E.]	ROU	F PLAN AND	DETAILS	
APPROVED: PWO OR OICC: DATE:	SIZE	CODE IDENT. NO	NAVI	AC DRAWING NO.	
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IVIARK	DESCRIPTION	MOUNTING INSTRUCTIONS
TA-1	TOILET TISSUE DISPENSER	MINIMUM 19" A.F.F. MAXIMUM 36" FROM REAR WALL OF STALL.
TA-2	24" X 42" MIRROR WITH STAINLESS STEEL FRAME	MOUNT WITH BOTTOM OF MIRROR AT 40" A.F.F.
TA-3	52" X 42" MIRROR WITH STAINLESS STEEL FRAME	MOUNT WITH BOTTOM OF MIRROR AT 40" A.F.F.
TA-4	WALL MOUNTED SOAP DISPENSER	MOUNT DISPENSER SPOUT AT 42" A.F.F. MINIMUM, 48" A.F.F. MAXIMUM
TA-5	ELECTRIC HAND DRYER	MOUNT 48"-54" A.F.F.
TA-6	TOILET/URINAL PARTITION	THROUGH-BODY COLOR PHENOLIC PANELS. OVERHEAD-BRACED COMPARTMENTS.
TA-7	STAINLESS STEEL GRAB BAR 1 ½" DIA. X 42" L	MOUNT 36" A.F.F. TO CENTERLINE
TA-8	STAINLESS STEEL GRAB BAR 1 ½" DIA. X 36" L	MOUNT 36" A.F.F TO CENTERLINE
TA-9	L-SHAPED STAINLESS STEEL GRAB BAR 1 ½" DIA. X 30" L X 18" D	MOUNT 33"-36" A.F.F. TO CENTERLINE.
TA-10	VERTICAL STAINLESS STEEL GRAB BAR 1 ½" DIA. X 18" L	MOUNT 42" A.F.F.
TA-11	SHOWER CURTAIN ROD 1 $\frac{1}{4}$ " DIA. X 36" L, PROVIDE CURTAIN	MOUNT 84" A.F.F. TO CENTERLINE
TA-12	BABY CHANGING STATION	MOUNT 28" TO 34" A.F.F.

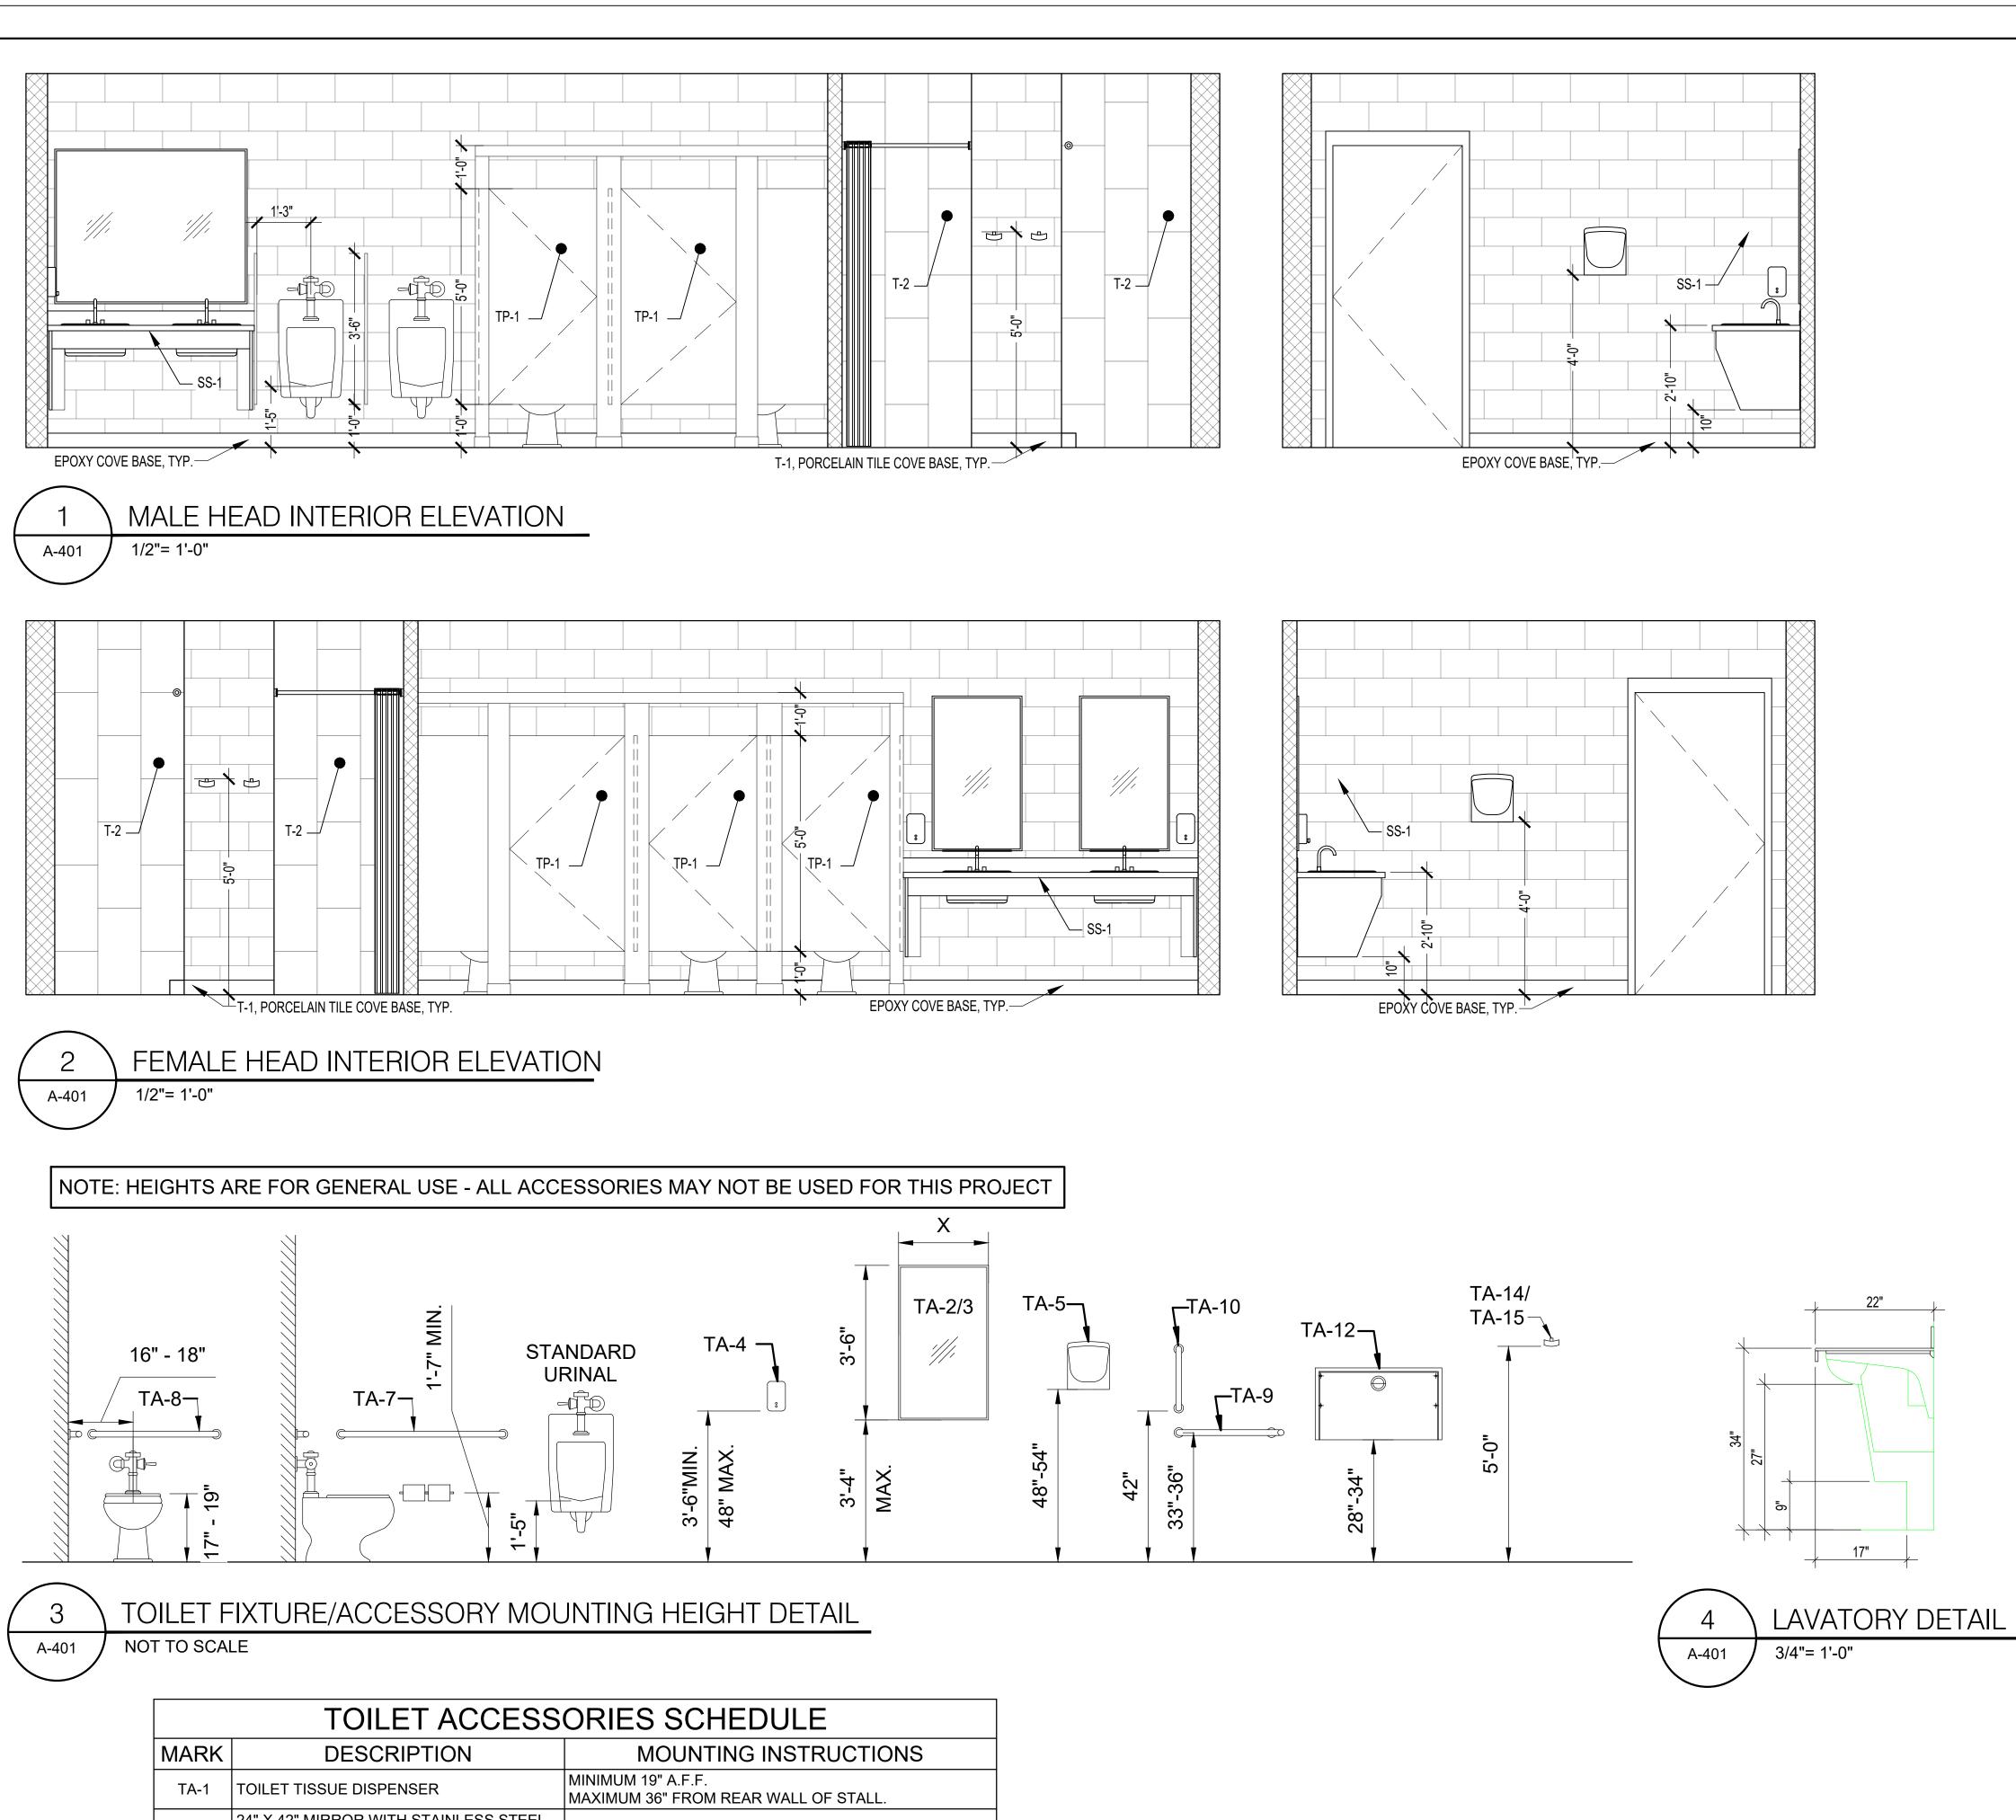MOUNT 17"-19" A.F.F.

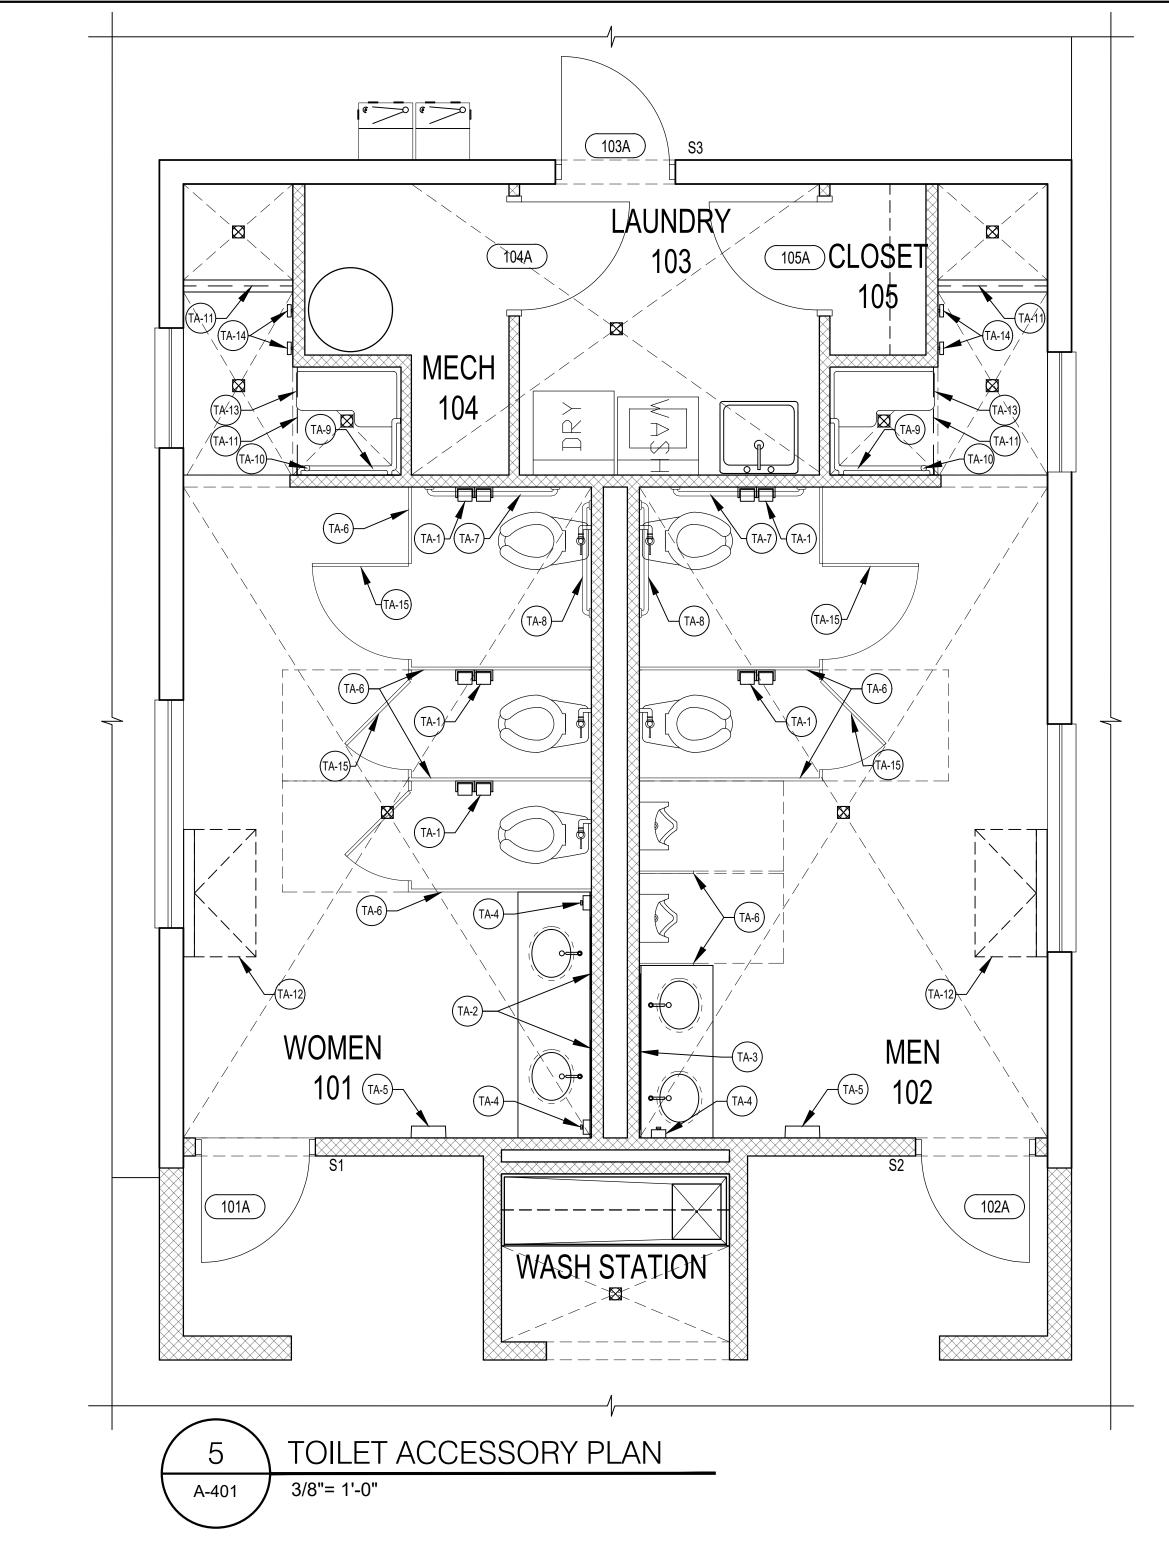MOUNT 60" A.F.F. ON TOILET PARTITION.

MOUNT 60" A.F.F.

TA-13 FOLDING SHOWER SEAT

TA-14 TOWEL HOOK

TA-15 BAG HOOK

DISCLOSURE OF INFORMATION CONTRACTOR SHALL COMPLY AS FOLLOWS:


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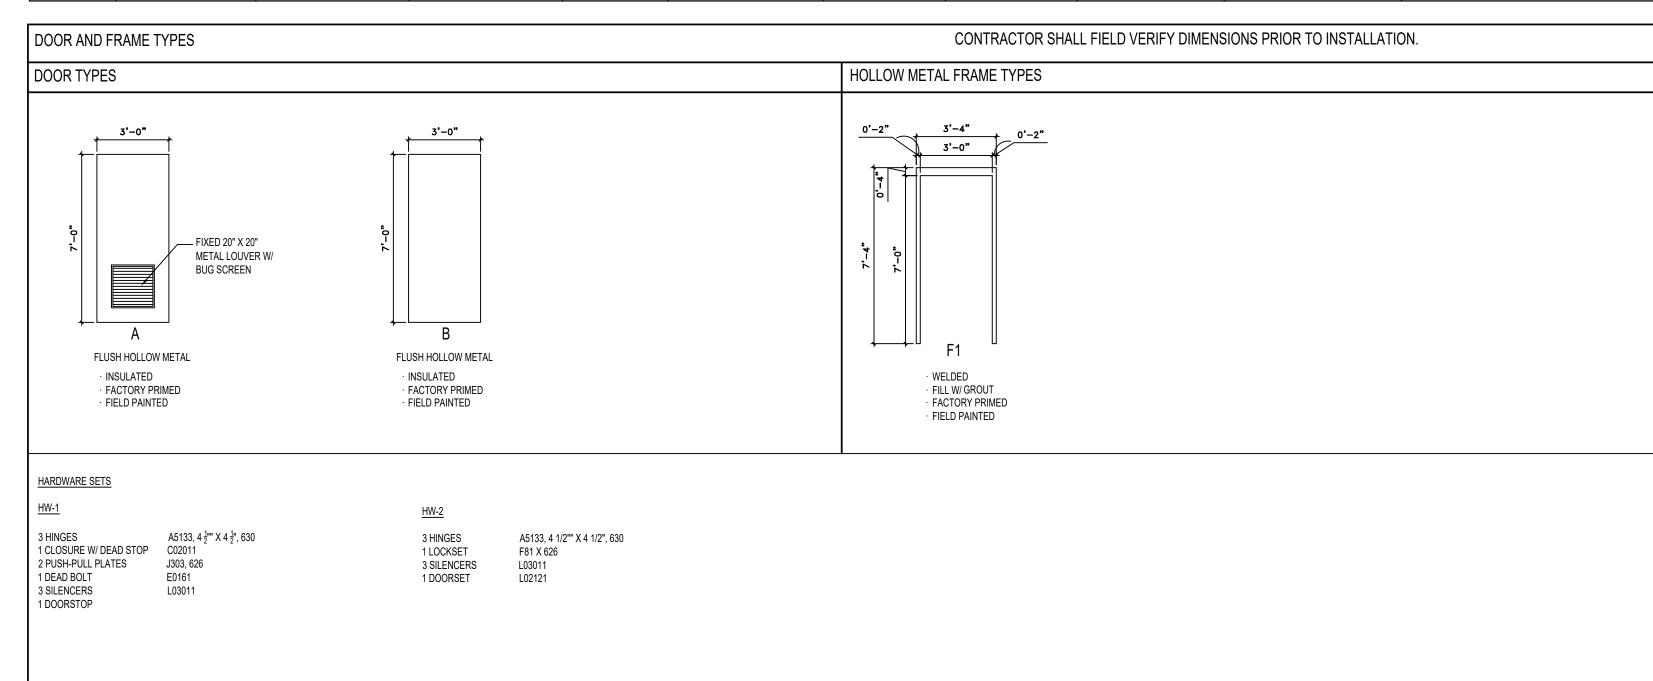
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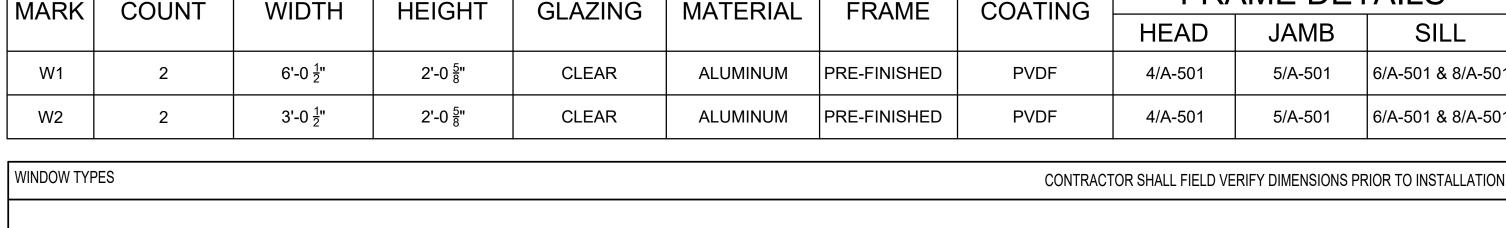
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FIN	A-4	401						
	MARINE CORPS BASE CAMP LEJEUNE, NORTH CAROLINA							
DES. M. HUNTER	H BUILDING ASZOIO							
DR. M. HUNTER CHK. K. ROOT, R.A.	-	Н	EAD REPA	AIRS				
SUBMITTED BY: M. HUNTER		NITERIOR FLE	VATIONS SOLI		TAILC			
DESIGN DIR. J. FRANKLIN ORR, P.E.] '	NIERIOR ELE	VATIONS, SCH	EDULES, DI	LIAILS			
APPROVED: PWO OR OICC: DATE:	SIZE	CODE IDENT. NO	NAVE	AC DRAWING NO				
PWO or OICC	F1	F1 80091 60		039613				
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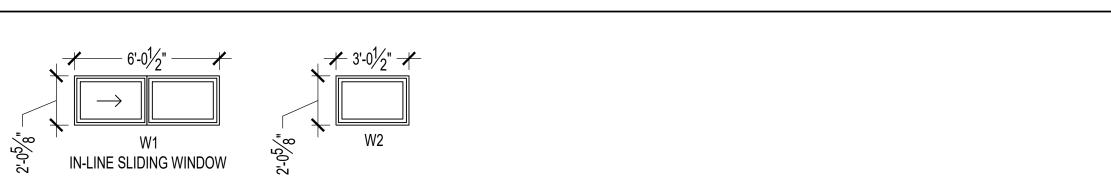



	DOOR SCHEDULE NOTE: CONTRACTOR SHALL FIELD VERIFY ALL DOOR AND FRAME DIMENSIONS IN FIELD PRIOR TO ORDERING UNITS. SEE PLAN LOCATIONS FOR SPECIFIC HANDING AND ORIENTATION.											
	DO	OR DATA		FRAN	IE DATA	DETAILS						
MARK	TYPE	THICKNESS	MATERIAL	TYPE	MATERIAL	HEAD	JAMB	SILL	HARDWARE	REMARKS		
101A	А	0'-1 3/4"	H.M.	F1	H.M.	1/A-601	1/A-601	2/A-601	HW-1	20" X 20" LOUVER		
102A	А	0'-1 3/4"	H.M.	F1	H.M.	1/A-601	1/A-601	2/A-601	HW-1	20" X 20" LOUVER		
103A	А	0'-1 3/4"	H.M.	F1	H.M.	1/A-601	1/A-601	2/A-601	HW-1	20" X 20" LOUVER		
104A	В	0'-1 3/4"	H.M.	F1	H.M.	1/A-601	1/A-601	2/A-601	HW-2			
105A	В	0'-1 3/4"	H.M.	F1	H.M.	1/A-601	1/A-601	2/A-601	HW-2			



				EDULE	NOTE: CONTRACTOR			FRAME DIMENSIONS IN DETAILS.		
MARK	COUNT	WIDTH	HEIGHT	GLAZING	MATERIAL	FRAME	COATING	FRAME DETA		ΓAILS
IVIZALAL	000111	VVIDITI	TILIOITI	OLAZINO	IVIATEIXIAE	FRAIVIE	COATING	HEAD	JAMB	SILL
W1	2	6'-0 ½"	2'-0 ⁵ / ₈ "	CLEAR	ALUMINUM	PRE-FINISHED	PVDF	4/A-501	5/A-501	6/A-501 & 8/A-501
W2	2	3'-0 ½"	2'-0 ⁵ / ₈ "	CLEAR	ALUMINUM	PRE-FINISHED	PVDF	4/A-501	5/A-501	6/A-501 & 8/A-501




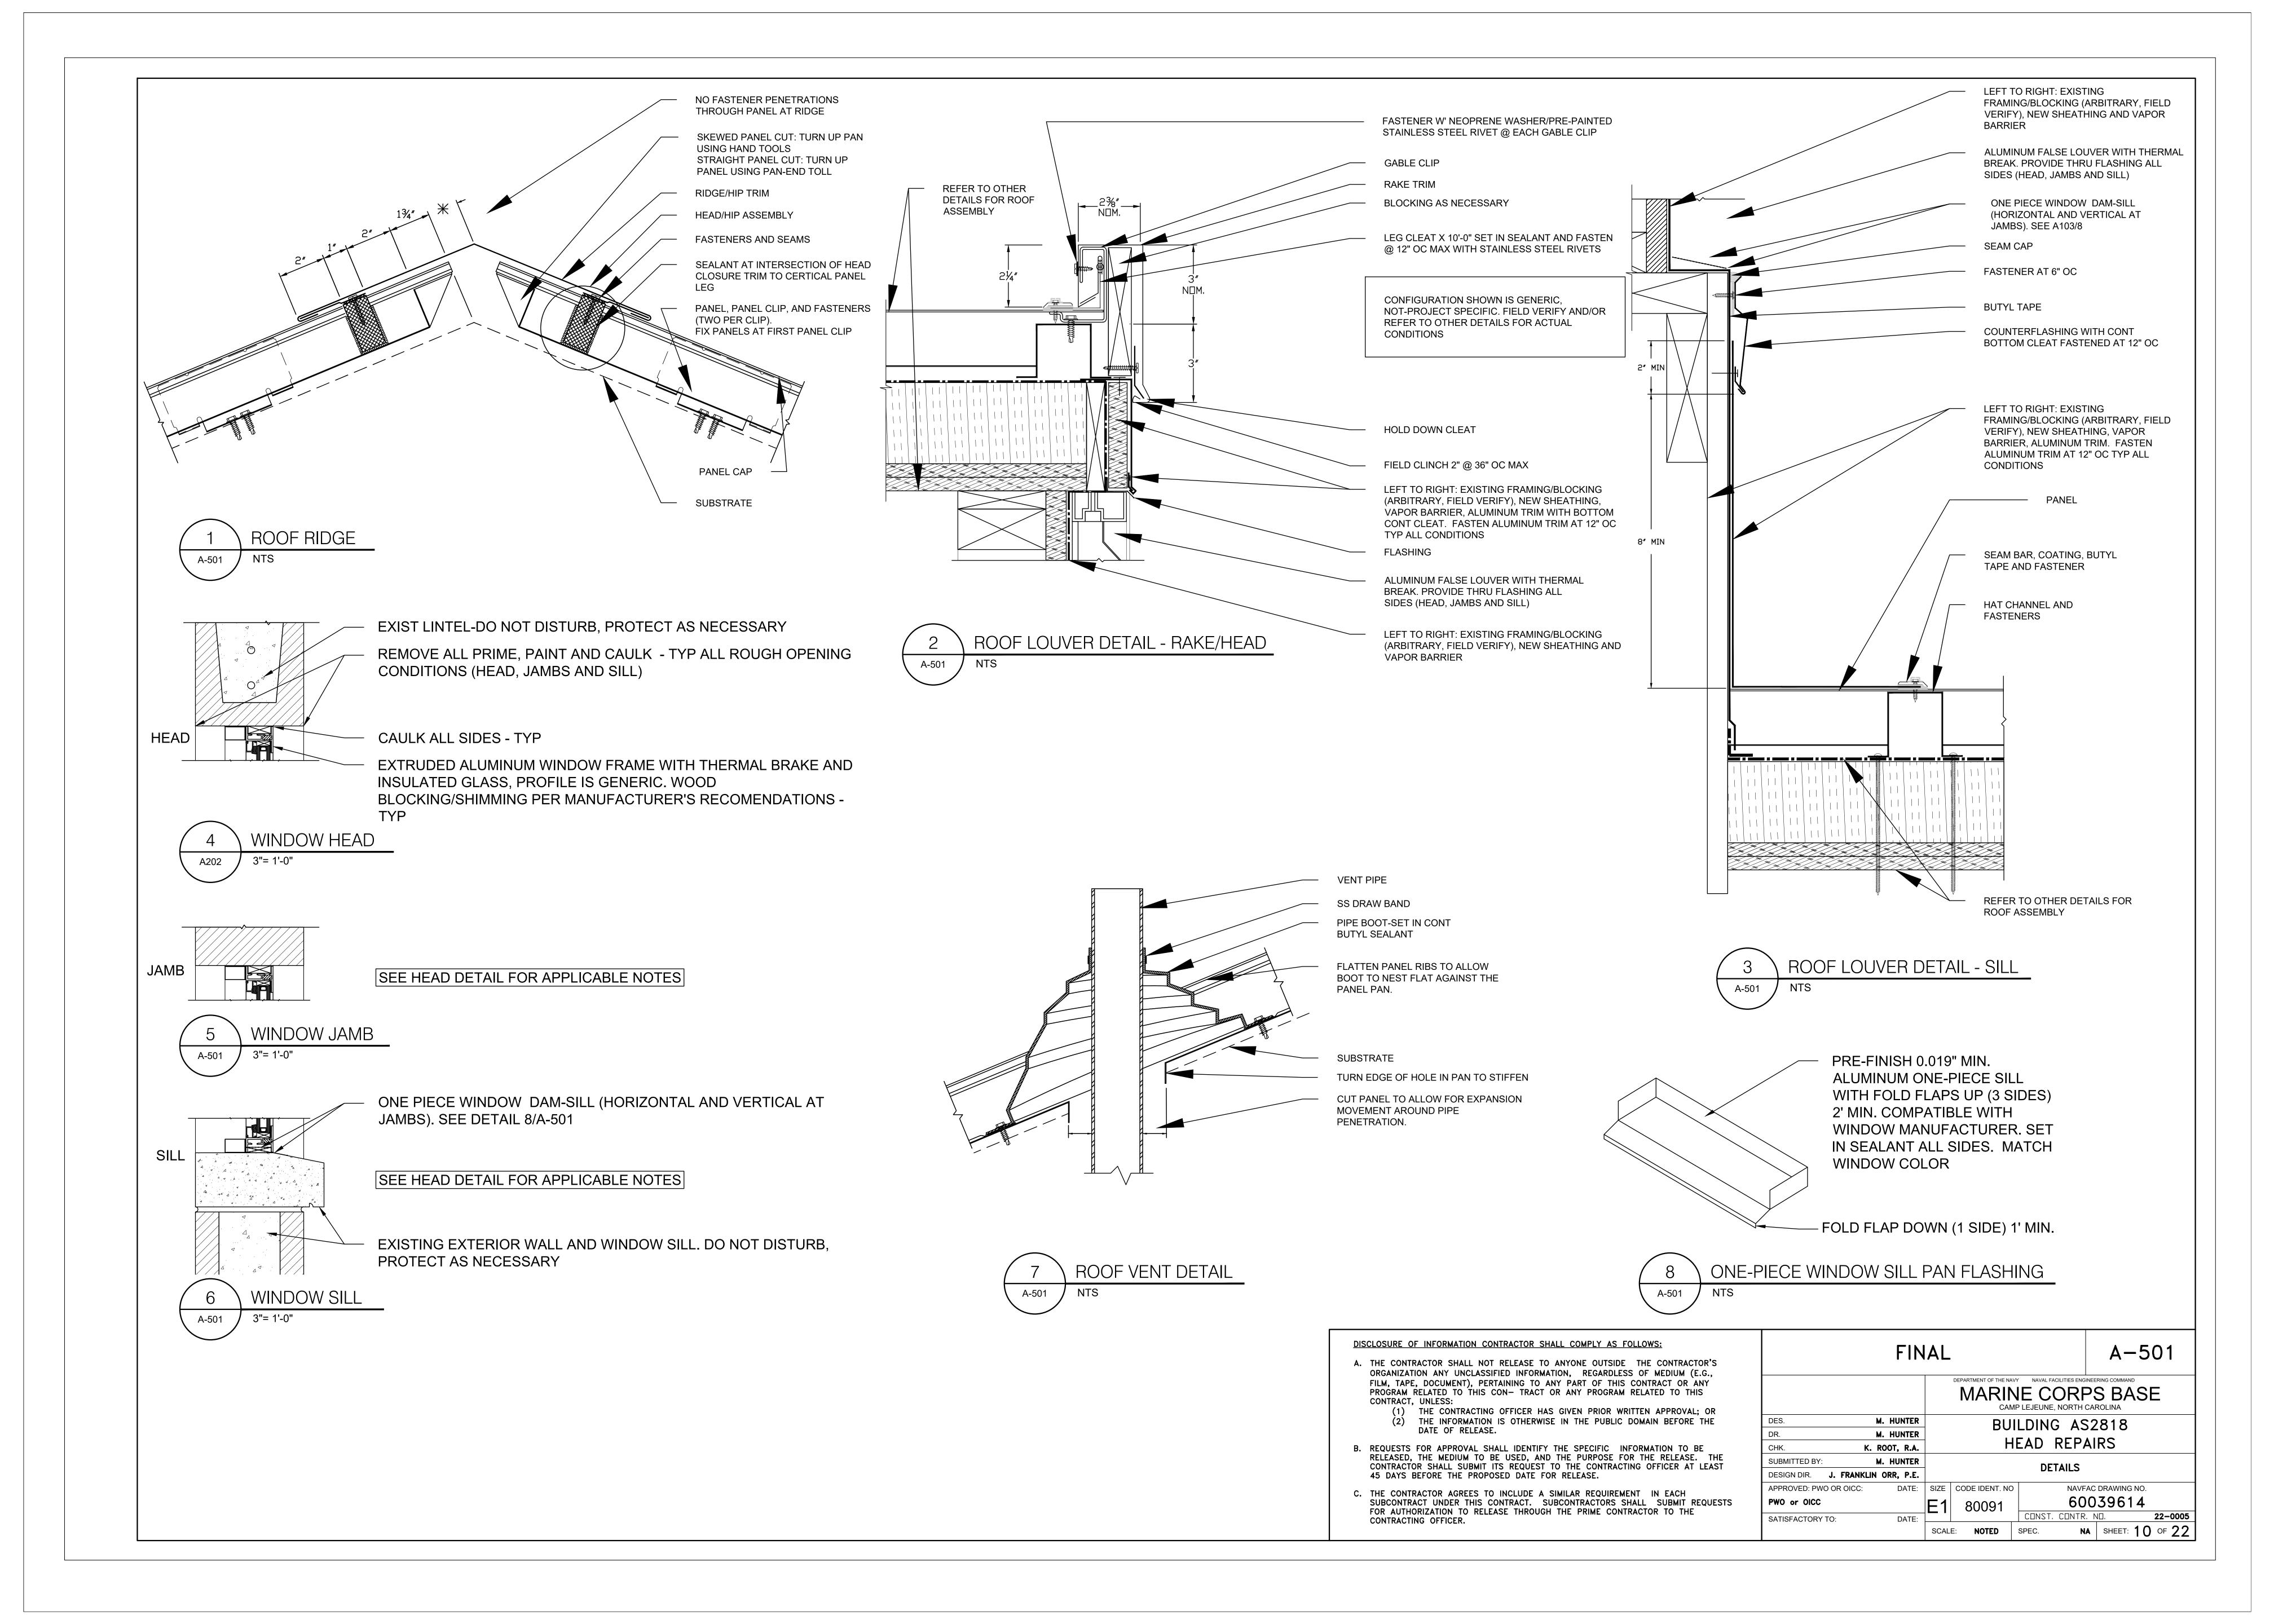

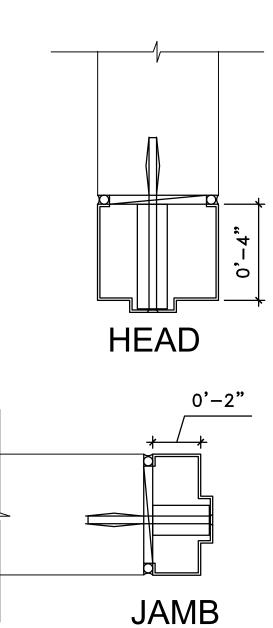


- PREPARED MASONRY (WELDED-ON ANCHOR).
- COUNTERSUNK 3/8' FLAT HEAD BOLT WITH 3/8" EXPANSION SHIELDS.
- JAMB SHOULD BE 4" FROM ADJACENT WALL UNLESS OTHERWISE NOTED.




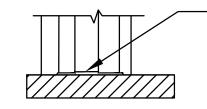


- STAINLESS STEEL THRESHOLD (PROFILE ARBITRARY) ADA ACCESSIBLE CODE COMPLIANT CONDITIONS
- PROVIDE URETHANE PRE-STRIPPING SET THRESHOLD IN CONTINUOUS BED OF
- SEALANT TO EXTEND 8" UP FULL WIDTH OF JAMBS



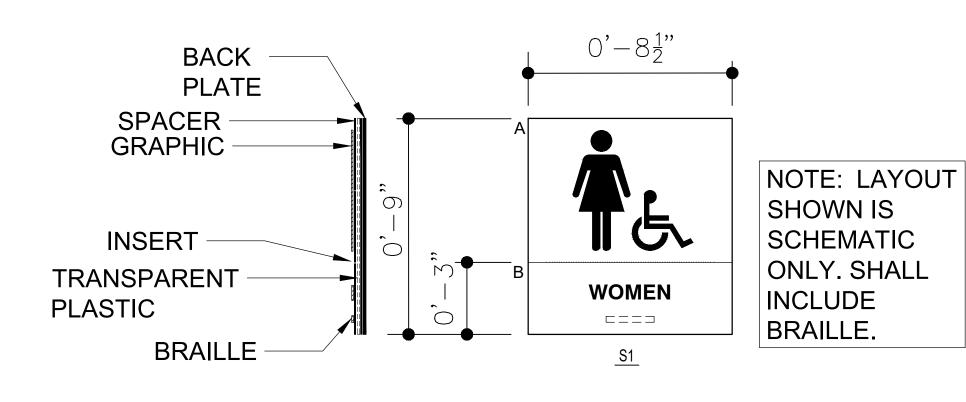

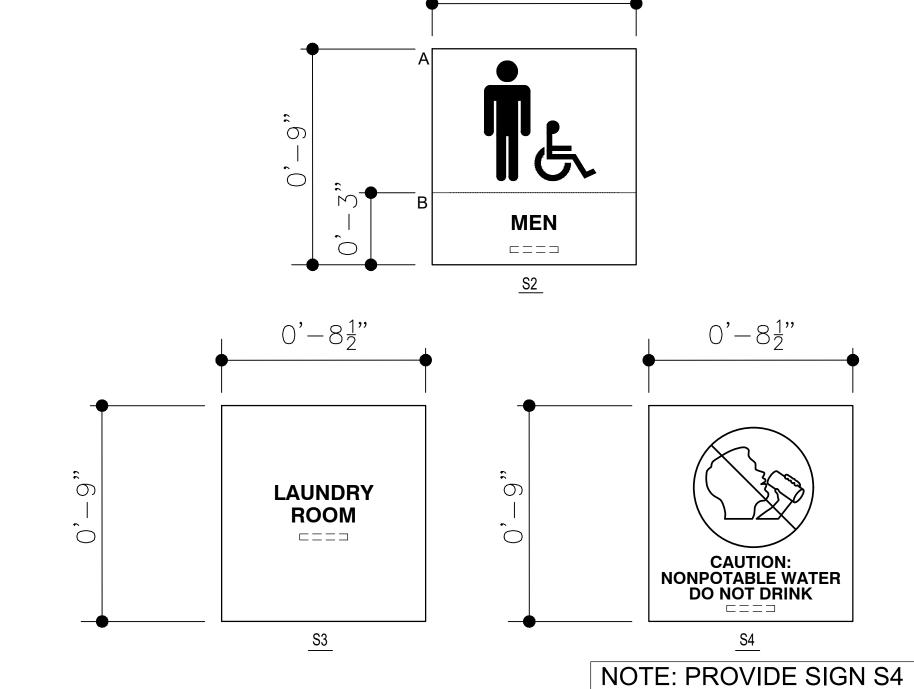



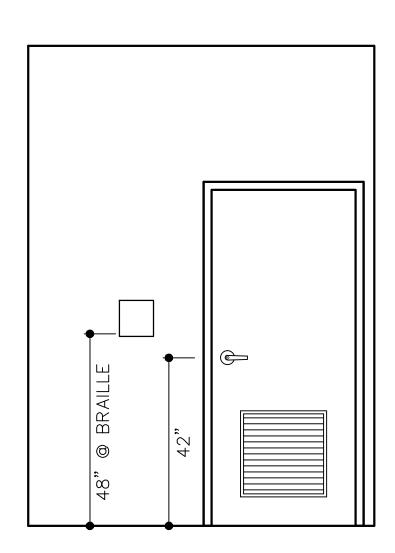

ADJACENT TO YARD

HYDRANT AND SANITARY


SEWER DUMPING STATION



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FIN	AL	A-601			
		NAVAL FACILITIES ENGINEERING COMMAND E CORPS BASE LEJEUNE, NORTH CAROLINA			
DES. M. HUNTER DR. M. HUNTER CHK. K. ROOT, R.A.		DING AS2818 EAD REPAIRS			
SUBMITTED BY: M. HUNTER DESIGN DIR. J. FRANKLIN ORR, P.E.	SCHEDULES AND SIGNAGE				
APPROVED: PWO OR OICC: DATE: PWO or OICC SATISFACTORY TO: DATE:	SIZE CODE IDENT. NO E1 80091	NAVFAC DRAWING NO. 60039615 CONST. CONTR. NO. 22-0005			
SATISFACTORY TO. DATE:	SCALE: NOTED S	SPEC. NA SHEET: 11 OF 22			



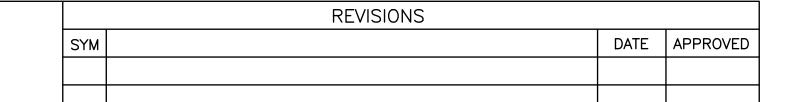

- 1. NOT ALL WORK IS EXPLICITLY SHOWN ON THE DRAWINGS. MAKE ALL NECESSARY MINOR CORRECTIONS AND ADJUSTMENTS TO DELIVER A FULLY FUNCTIONAL AND COMPLETE SYSTEM.

 2. ALL UNDERGROUND WATER PIPING MUST BE TYPE-K COPPER. ALL ABOVEGROUND WATER
- PIPING MUST BE TYPE-L OR TYPE-K COPPER. PRESS FIT OR PUSH FIT CONNECTIONS ARE
- 3. DEMOLISH ALL EXISTING PLUMBING FIXTURES AND PIPING. DO NOT REUSE ANY EXISTING COMPONENTS OR PIPING.
- 4. ALL WASTE AND VENT PIPE MUST BE SCHEDULE 40 PVC.
- 5. SEE CIVIL DRAWINGS FOR BACKFLOW PREVENTER AND YARD HYDRANT LOCATION.



CHECK VALVE

AUTOMATIC AIR VENT


BALL VALVE

PRESSURE GAUGE

TEMPERATURE GAUGE

EXTENT OF DEMOLITION


POINT OF CONNECTION

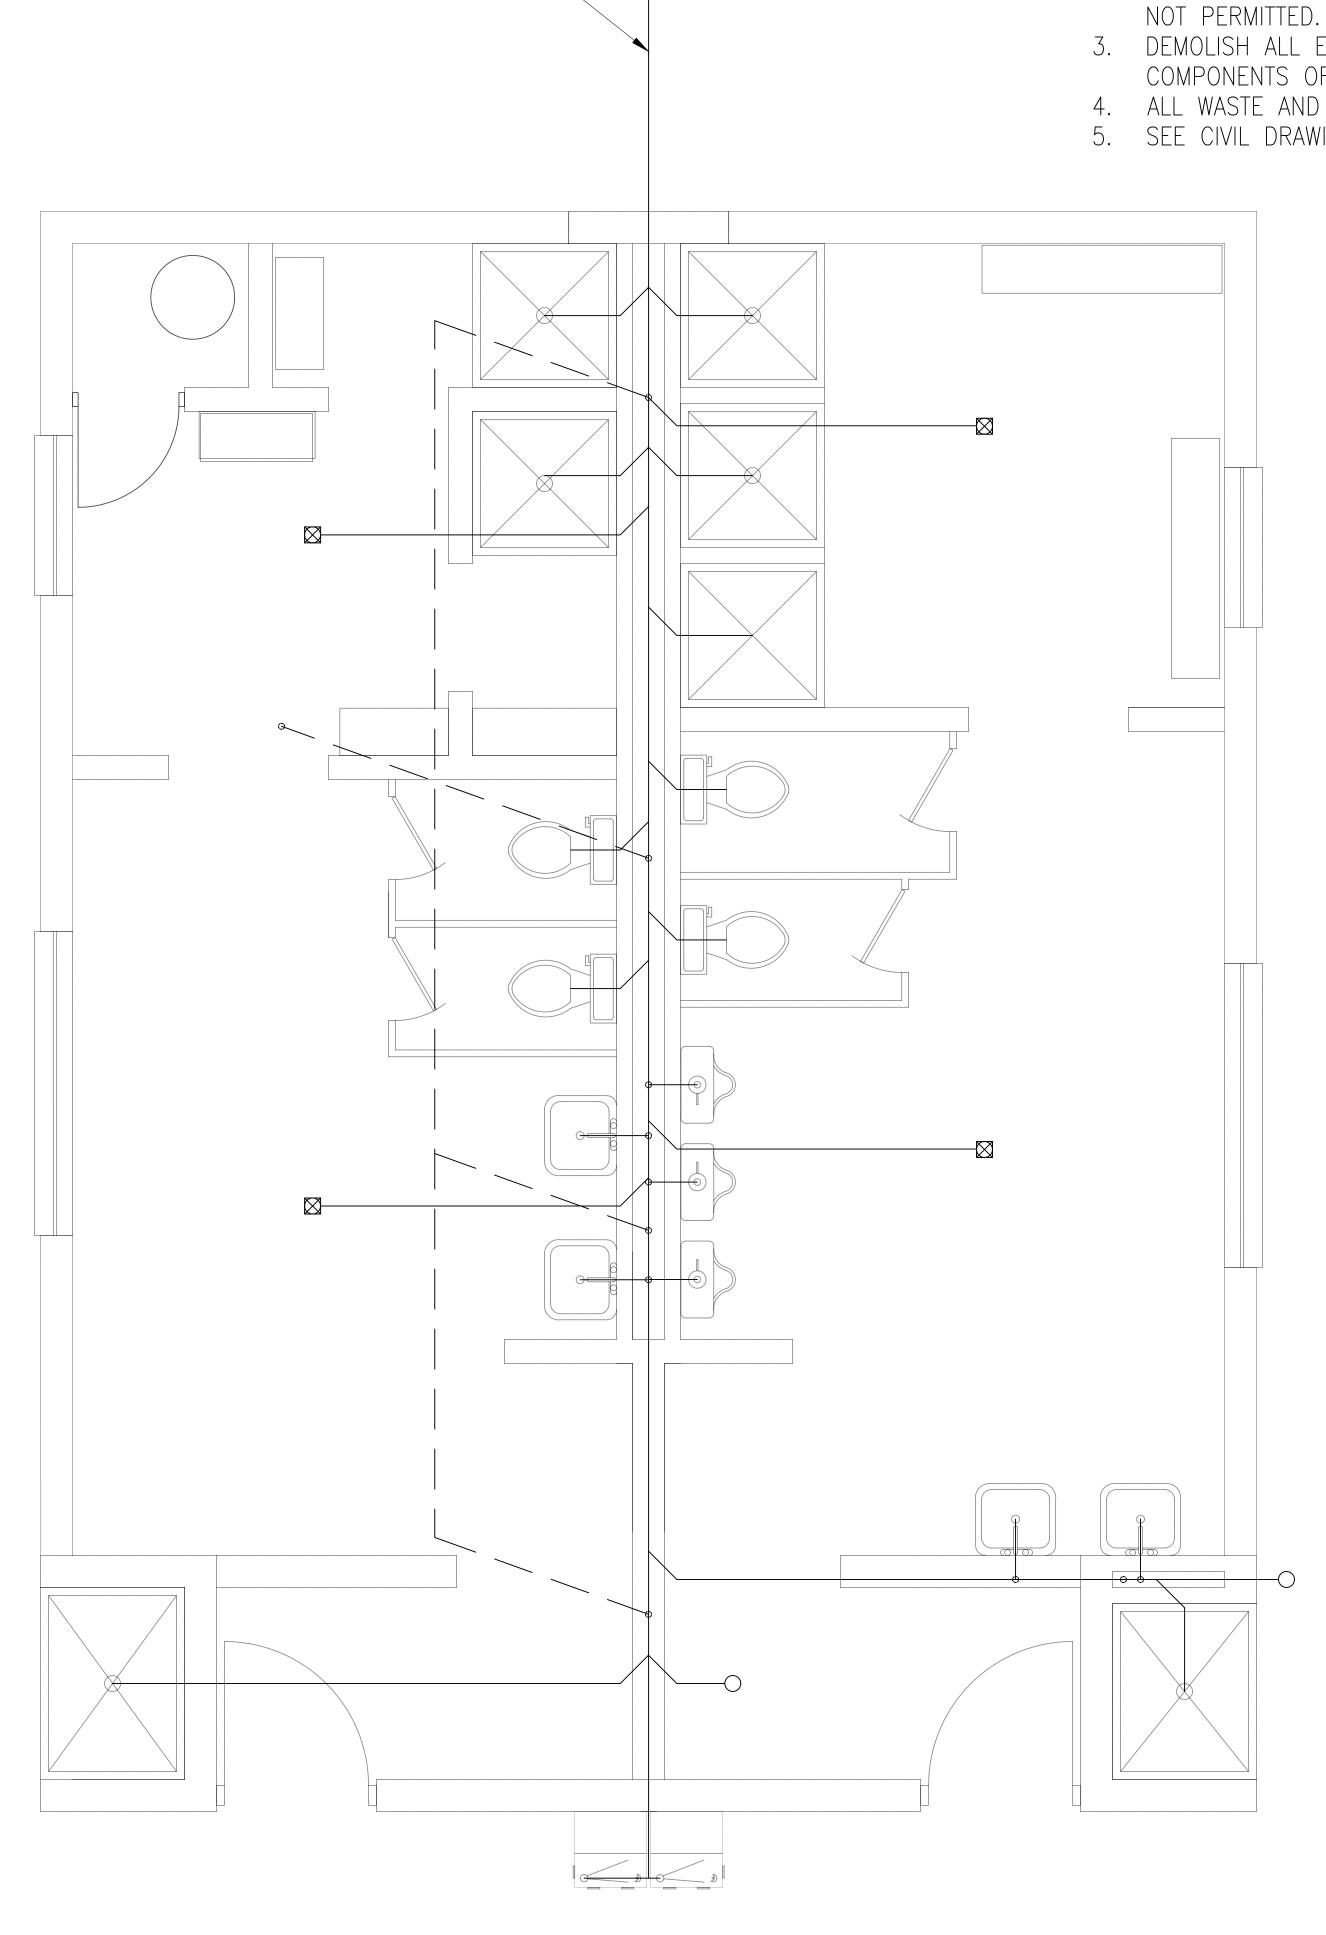

COLD WATER & HOT WATER DEMO

SCALE: 1/2" = 1"


SEE CIVIL DRAWINGS FOR CONTINUATION

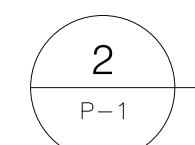


SEE CIVIL DRAWINGS FOR CONTINUATION -


WASTE AND VENT DEMO

SCALE: 1/2" = 1"

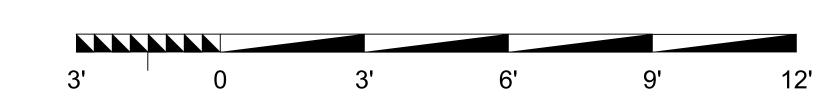

FINAL		P1
		ORPS BASE NORTH CAROLINA
S. C J MAAS C J MAAS K. J A ELLIOTT BMITTED BY: C J MAAS		TAD REPAIRS
PROVED: PWO OR OICC DATE	F1 80001	AC DRAWING NO. 60039616 CONTR. 22-0005
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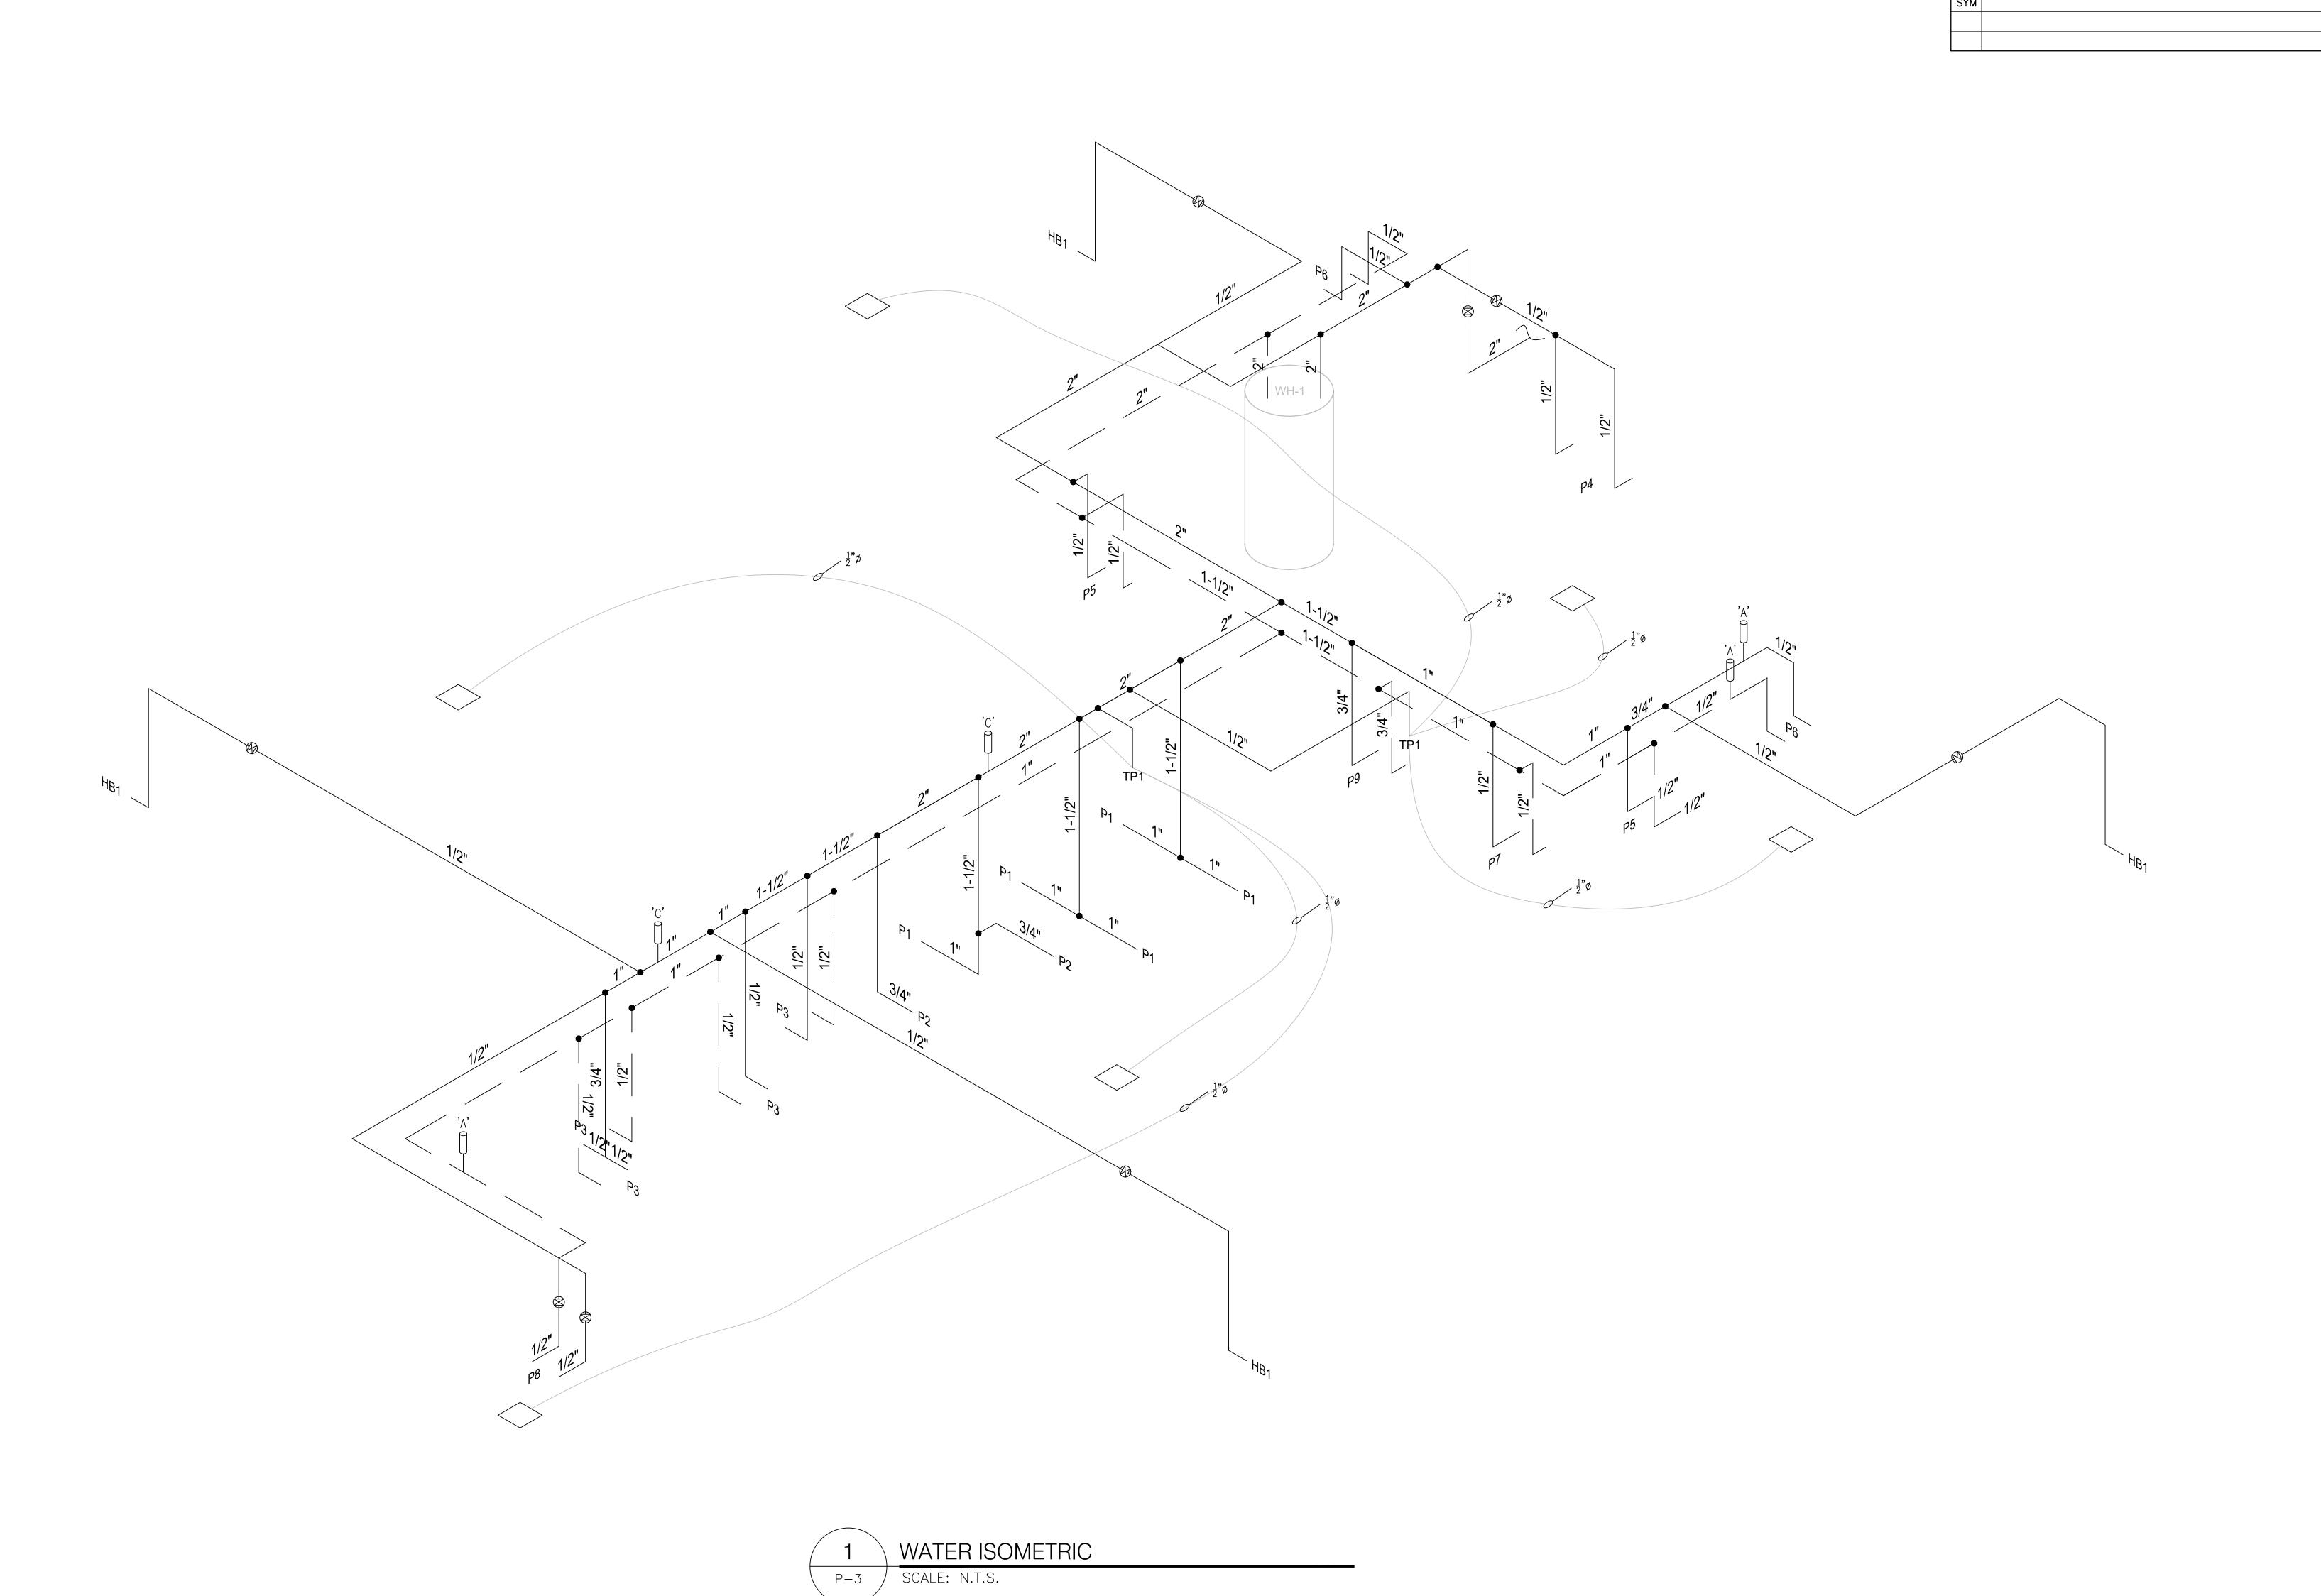


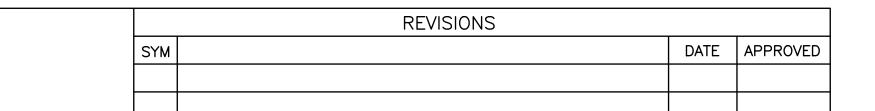COLD WATER & HOT WATER PLAN SCALE: 1/2" = 1'

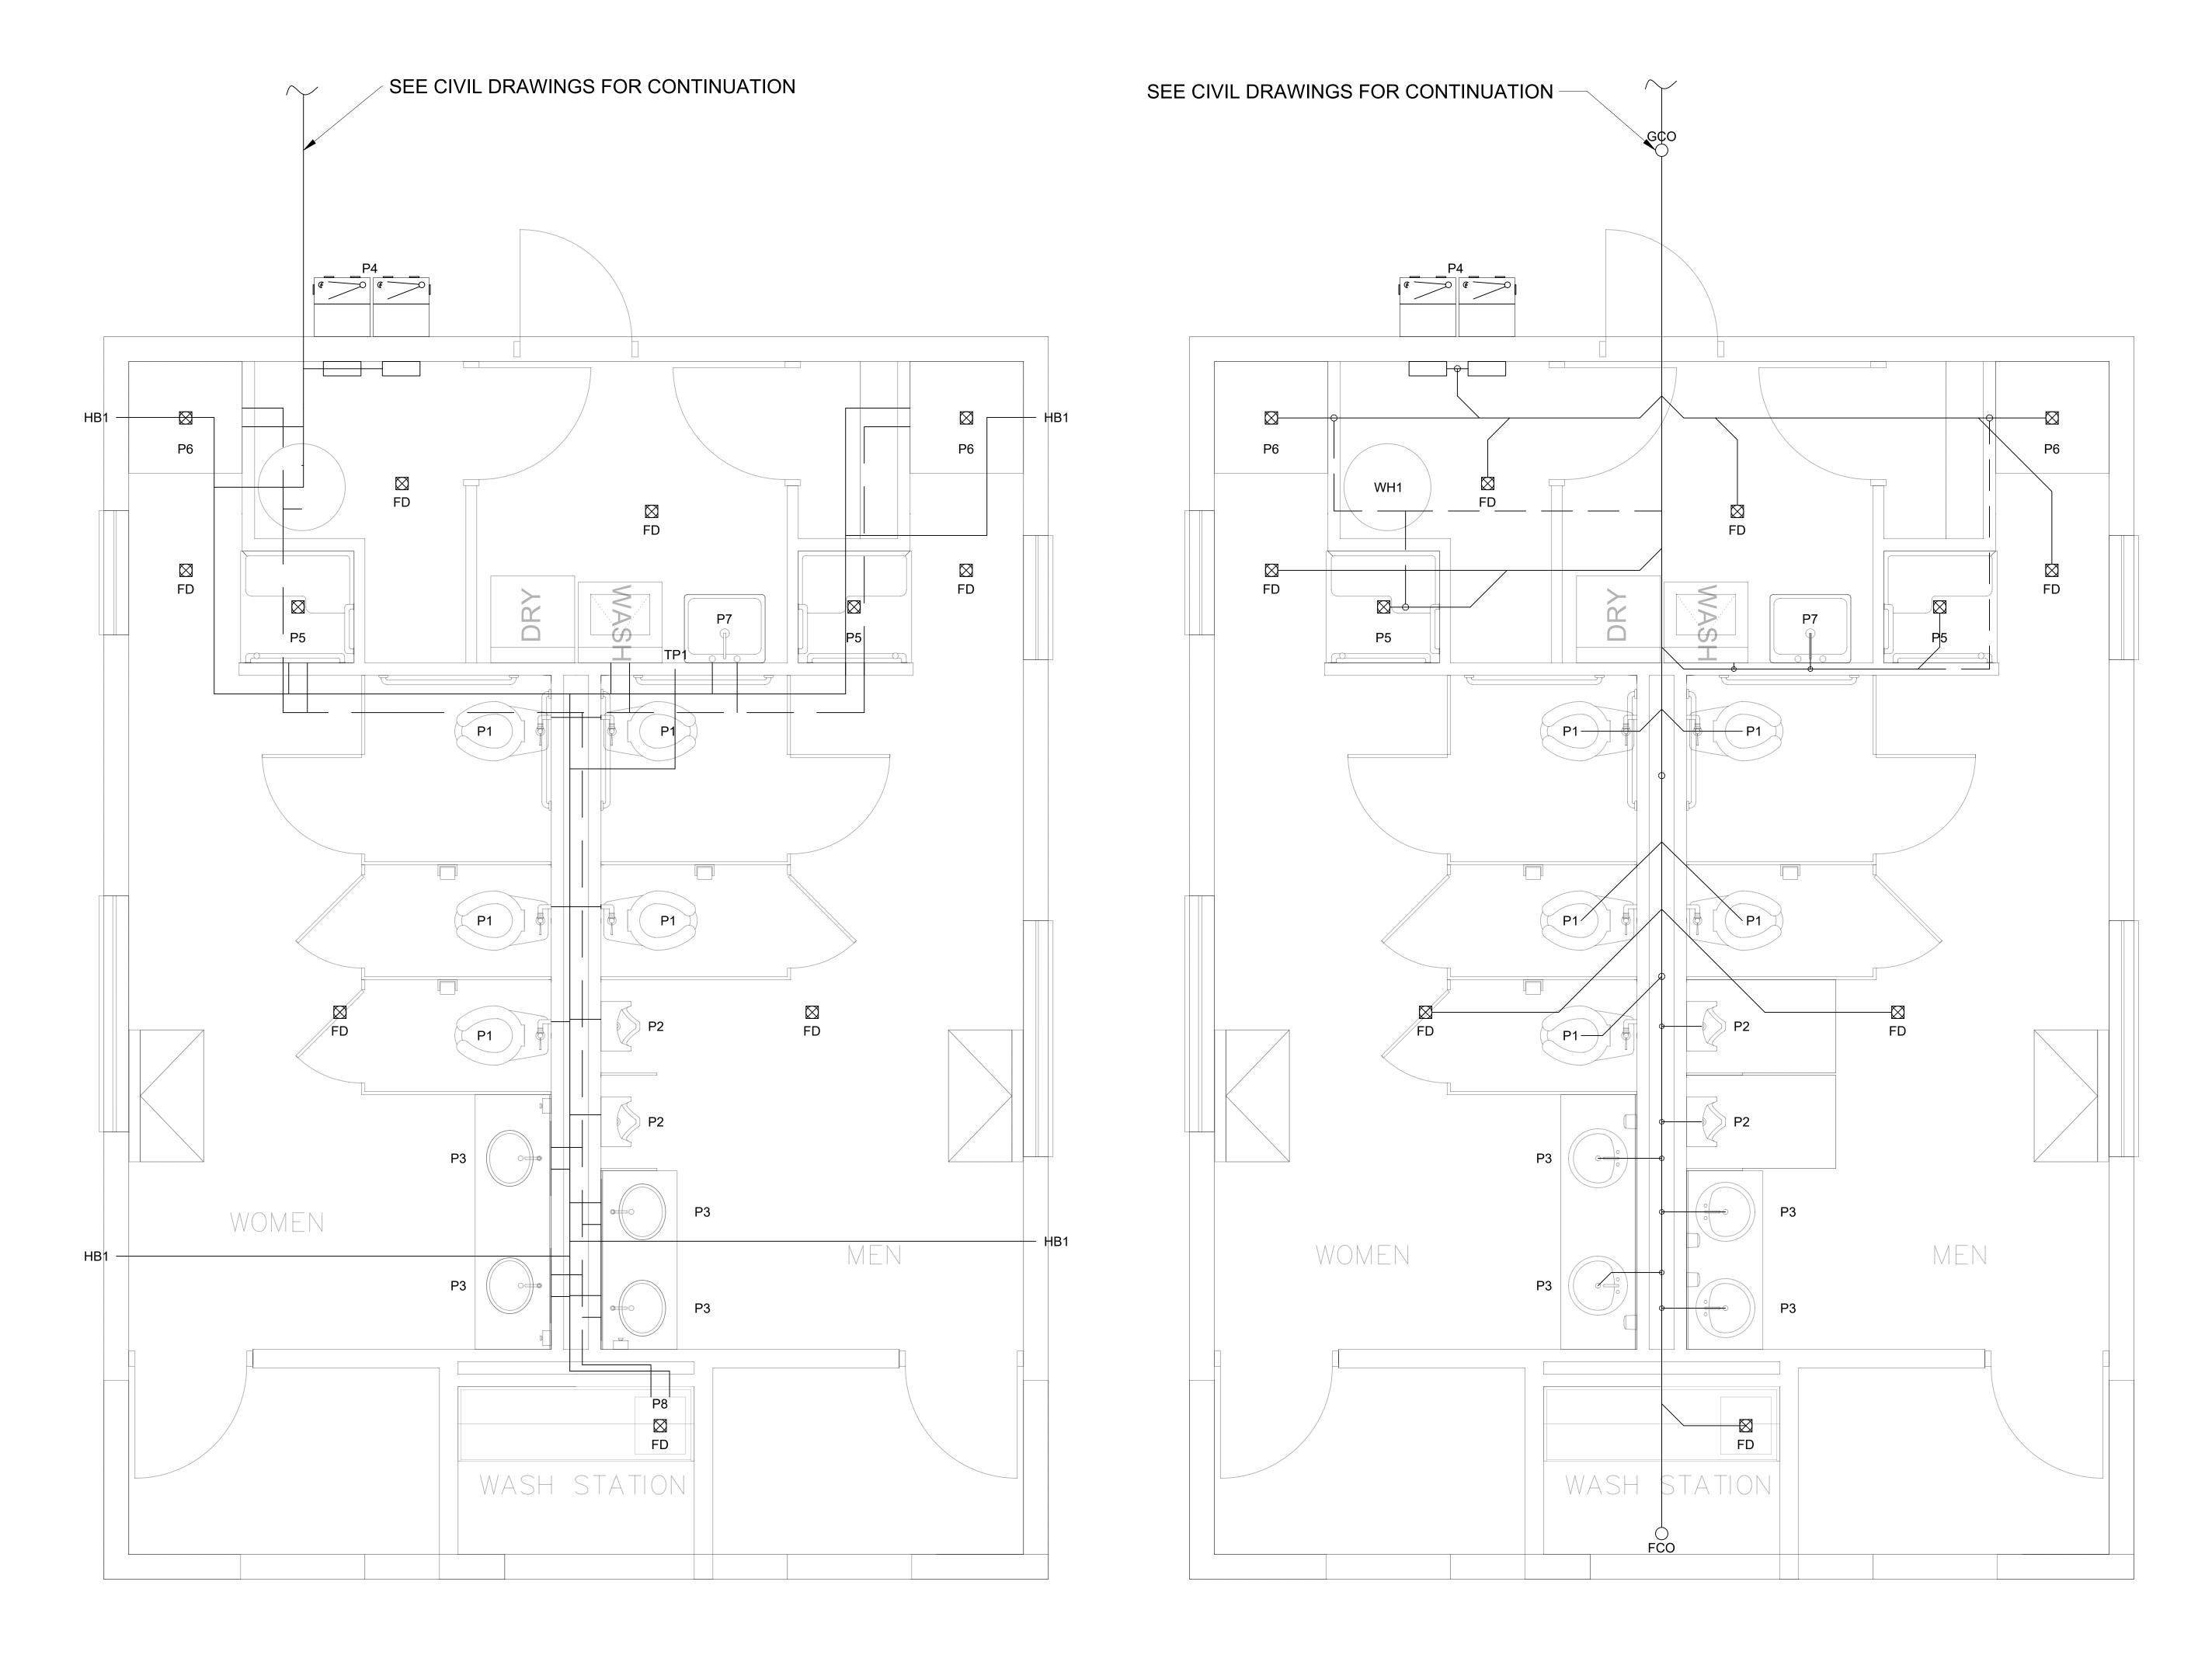



FINAL		
		FACILITIES ENGINEERING COMMAND
	MARINE COF	RPS BASE
	CAMP LEJEUNE, NOR	TH CAROLINA
DES. C J MAAS		
DR. C J MAAS	100010 1151	5 5 5 1 1 5 6
CHK. J A ELLIOTT	AS2818 HEAI) REPAIRS
SUBMITTED BY: C J MAAS		
DESIGN DIR.J F ORR P.E.	PLUMBING NEW WORK	
APPROVED: PWO OR OICC DATE	SIZE CODE IDENT. NO NAVFAC	DRAWING NO.
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DES. C. J. MAAS
DES. C. J. MAAS
DR. C. J. MAAS
CHK. J. A. ELLIOTT
SUBMITTED BY: C. J. MAAS
DESIGN DIR. J. F. ORR. P.E.
APPROVED: PWO OR OICC

SATISFACTORY TO:


DEPARTMENT OF THE NAVY
NAVAL FACILITIES ENGINEERING COMMAND

MARINE CORPS BASE
CAMP LEJEUNE, NORTH CAROLINA

AS 28 18 HEAD REPAIRS
WATER ISOMETRIC
SIZE CODE IDENT. NO NAVFAC DRAWING NO.
60039618
CONST. CONTR. 22-0005
SCALE: NOTED SPEC. 05-22-0005
SHEET 14 0F 22

REVISIONS

DATE APPROVED

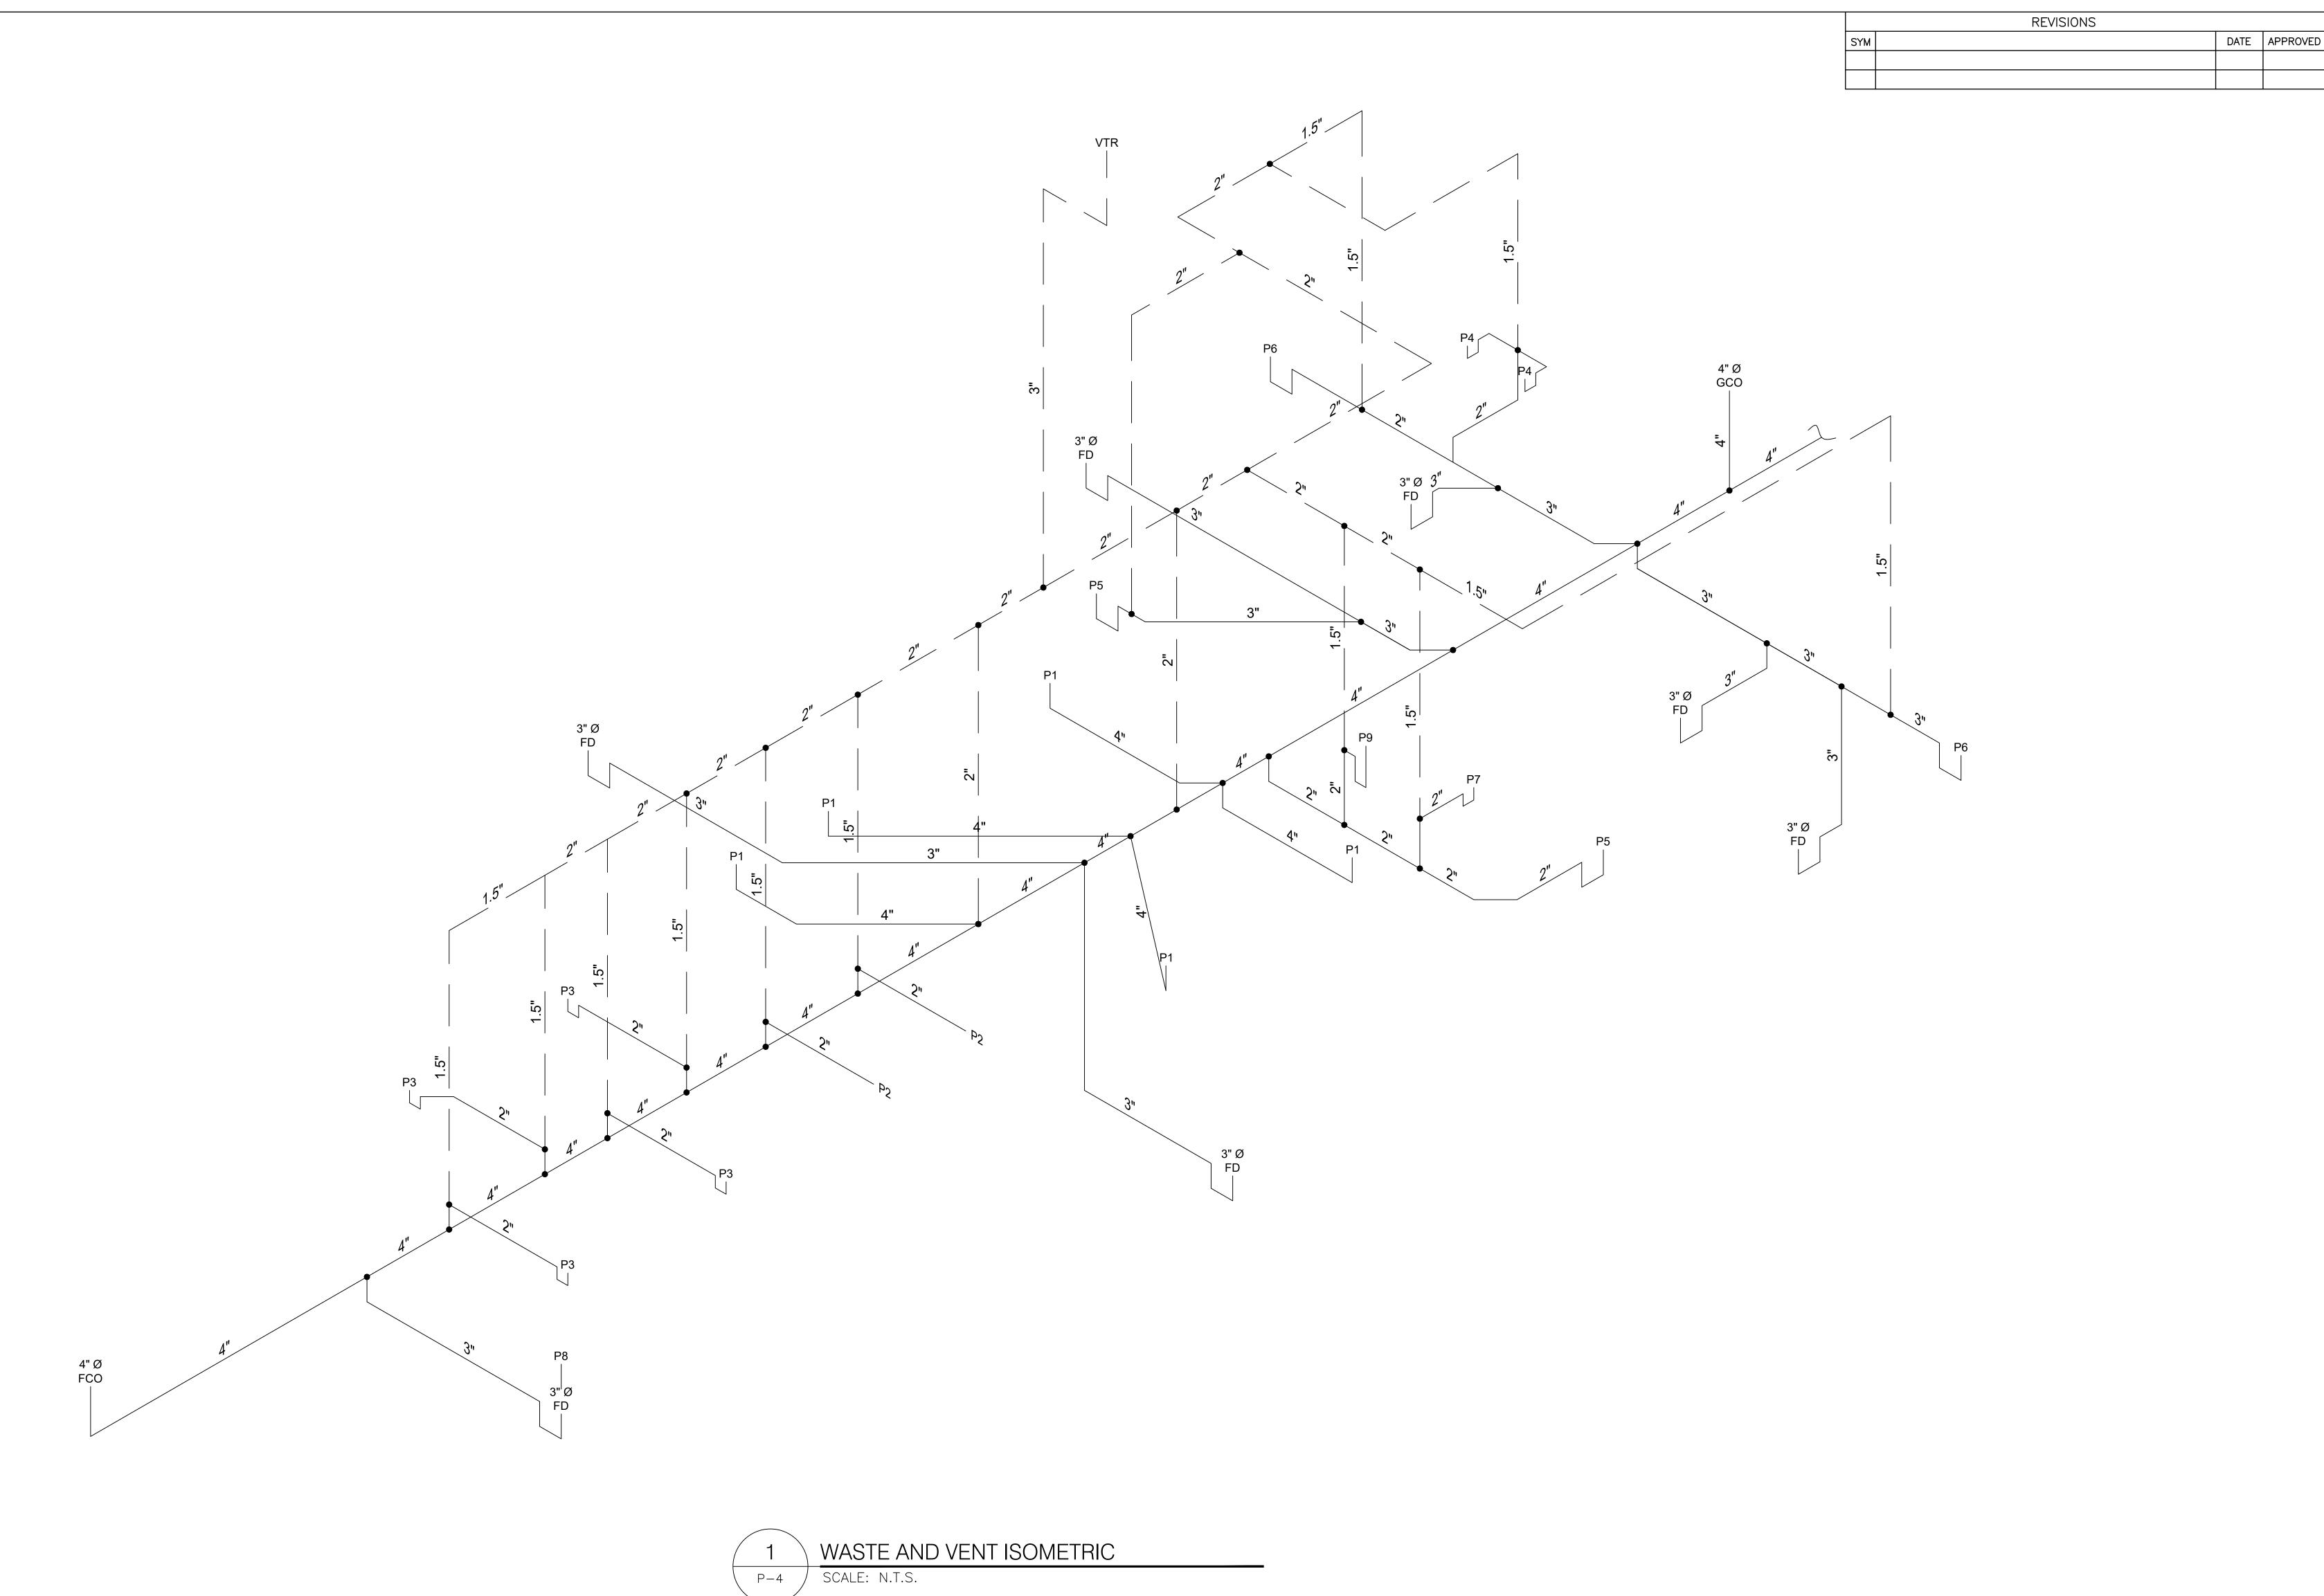

DES. C J MAAS

DES. C J MAAS

DR. C J MAAS

CHK. J A ELLIOTT

SUBMITTED BY: C J MAAS

DESIGN DIR.J F ORR P.E.

APPROVED: PWO OR OICC

SATISFACTORY TO:

DATE

DEPARTMENT OF THE NAVY

NAVAL FACILITIES ENGINEERING COMMAND

MARINE CORPS BASE

CAMP LEJEUNE, NORTH CAROLINA

AS 2818 HEAD REPAIRS


WASTE AND VENT ISOMETRIC


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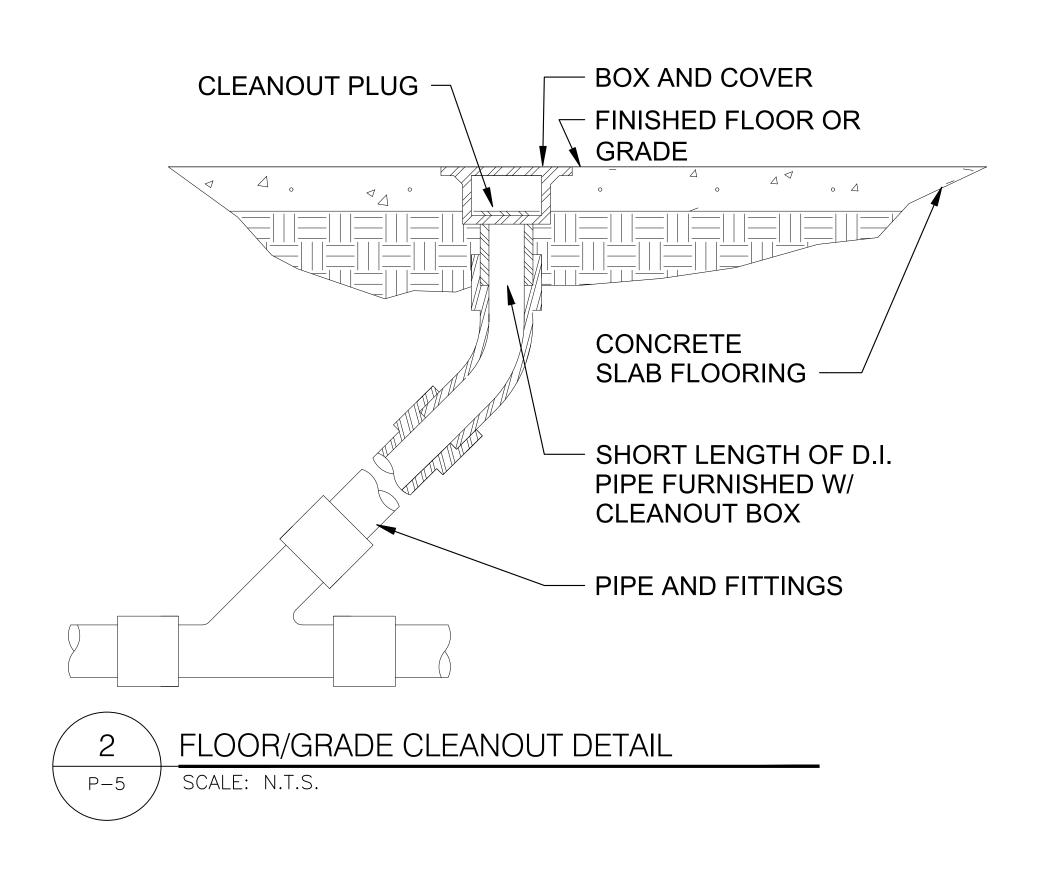
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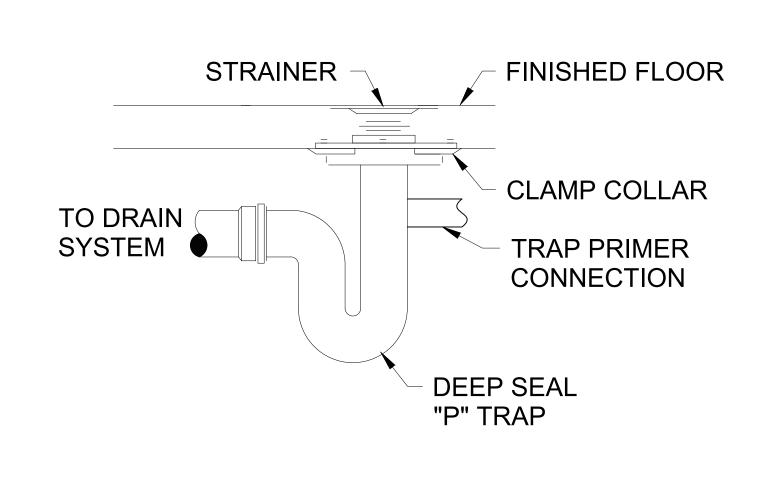
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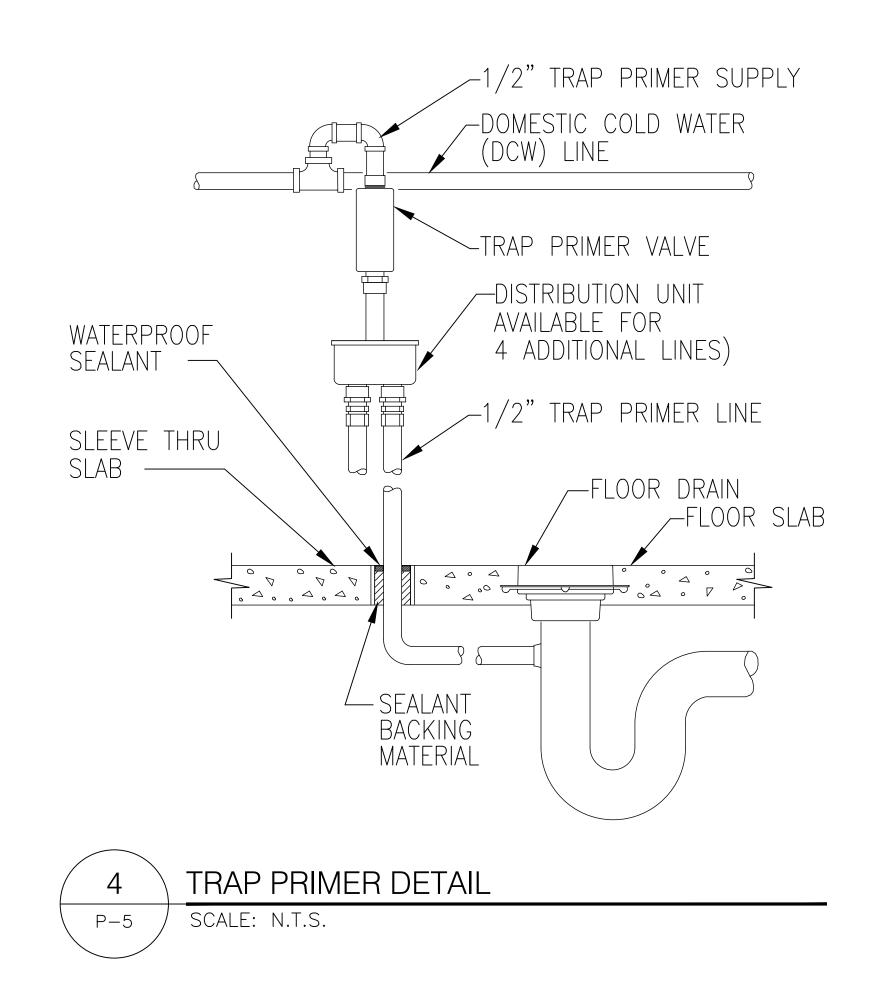









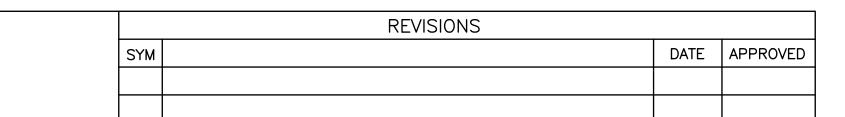


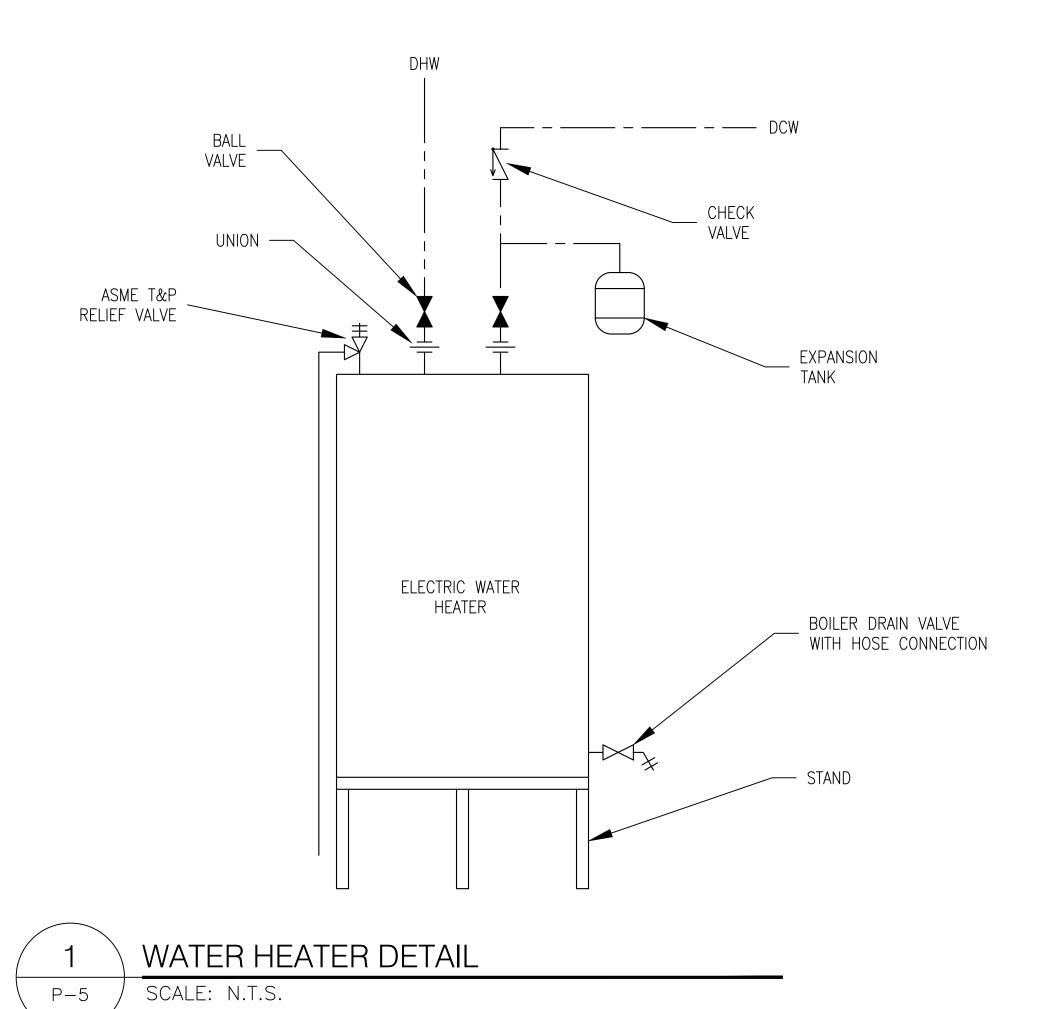

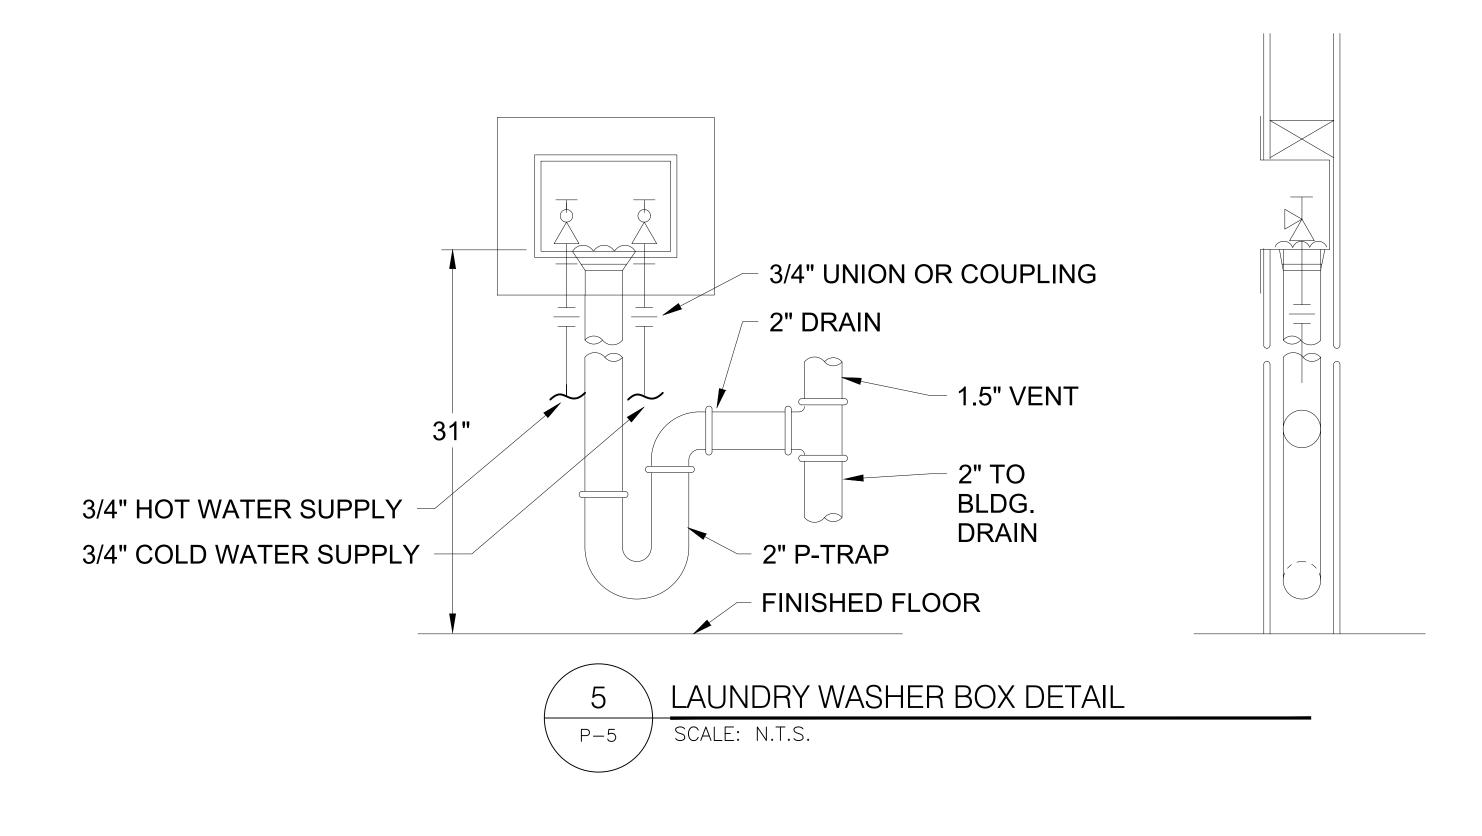


FINAL	P5
	MARINE CORPS BASE CAMP LEJEUNE, NORTH CAROLINA
DES. C J MAAS DR. C J MAAS CHK. J A ELLIOTT SUBMITTED BY: C J MAAS	AS2818 HEAD REPAIRS
DESIGN DIR.J F ORR P.E.	PLUMBING DETAILS
APPROVED: PWO OR OICC DATE SATISFACTORY TO: DATE	E1 80091 60039620
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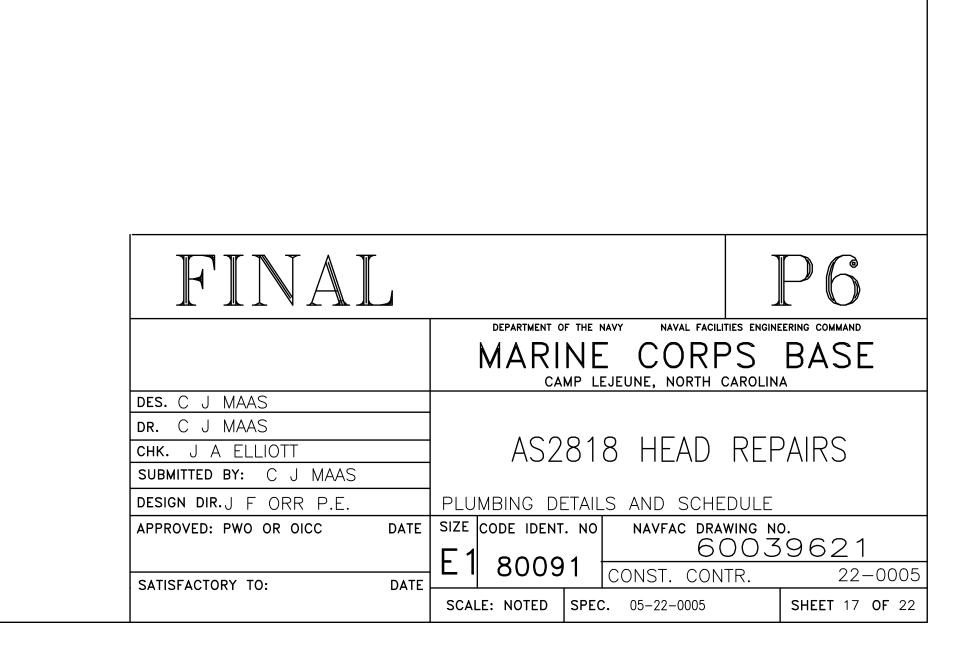
	REVISIONS		
SYM		DATE	APPROVED



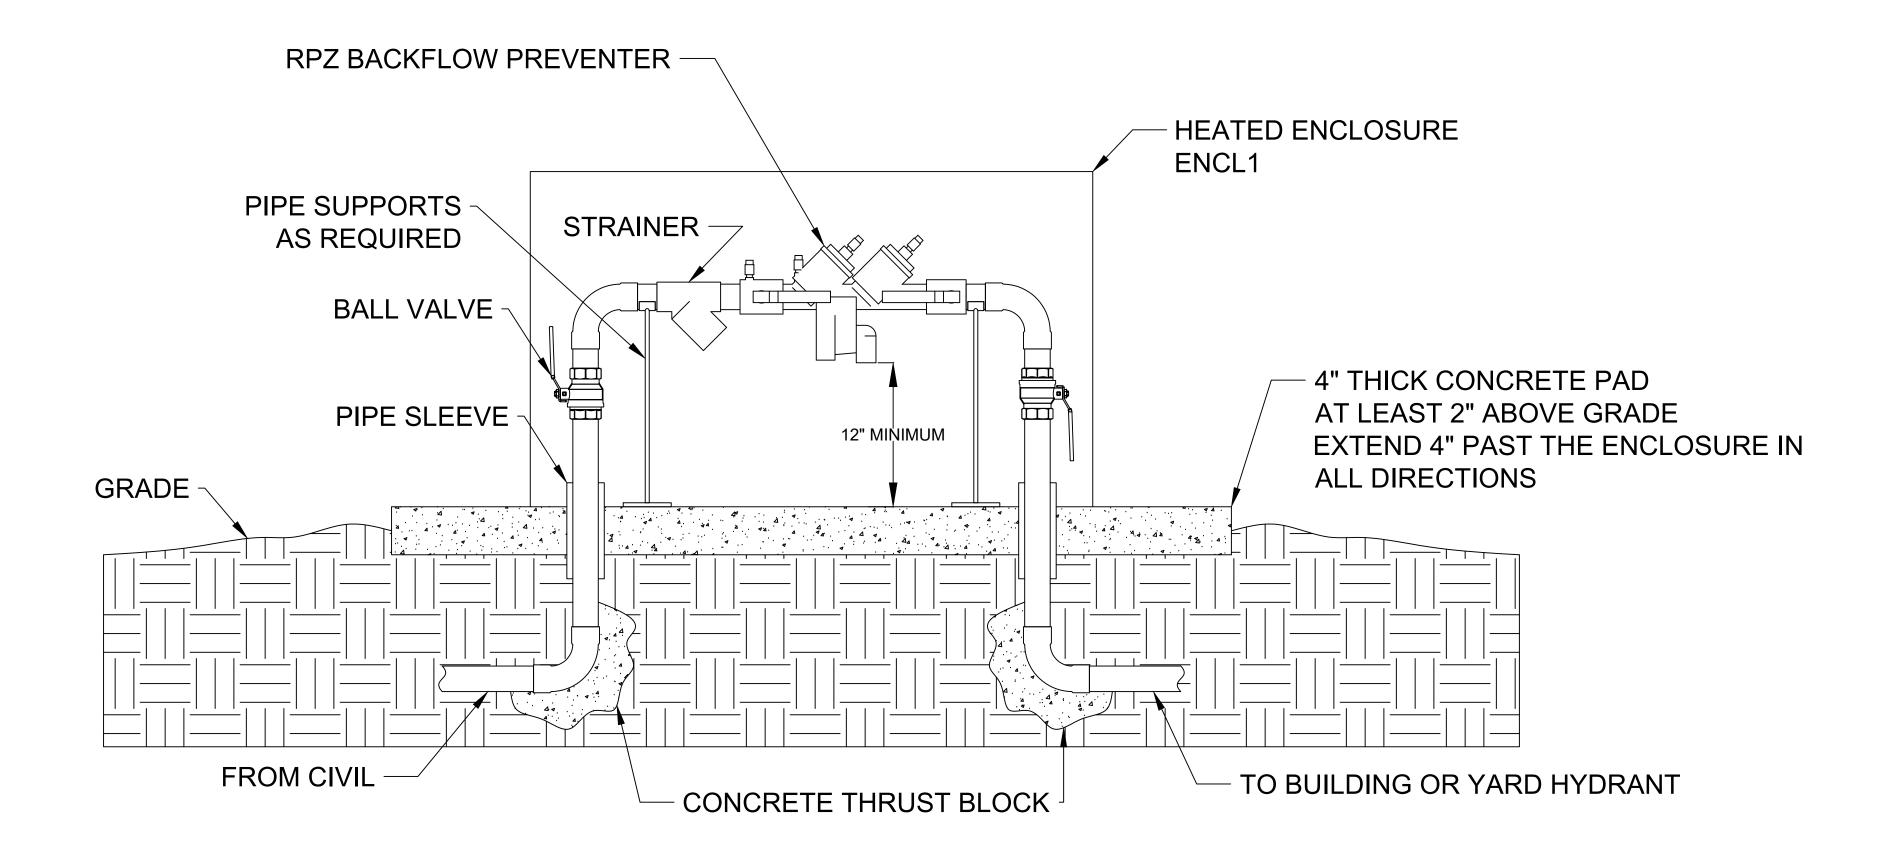

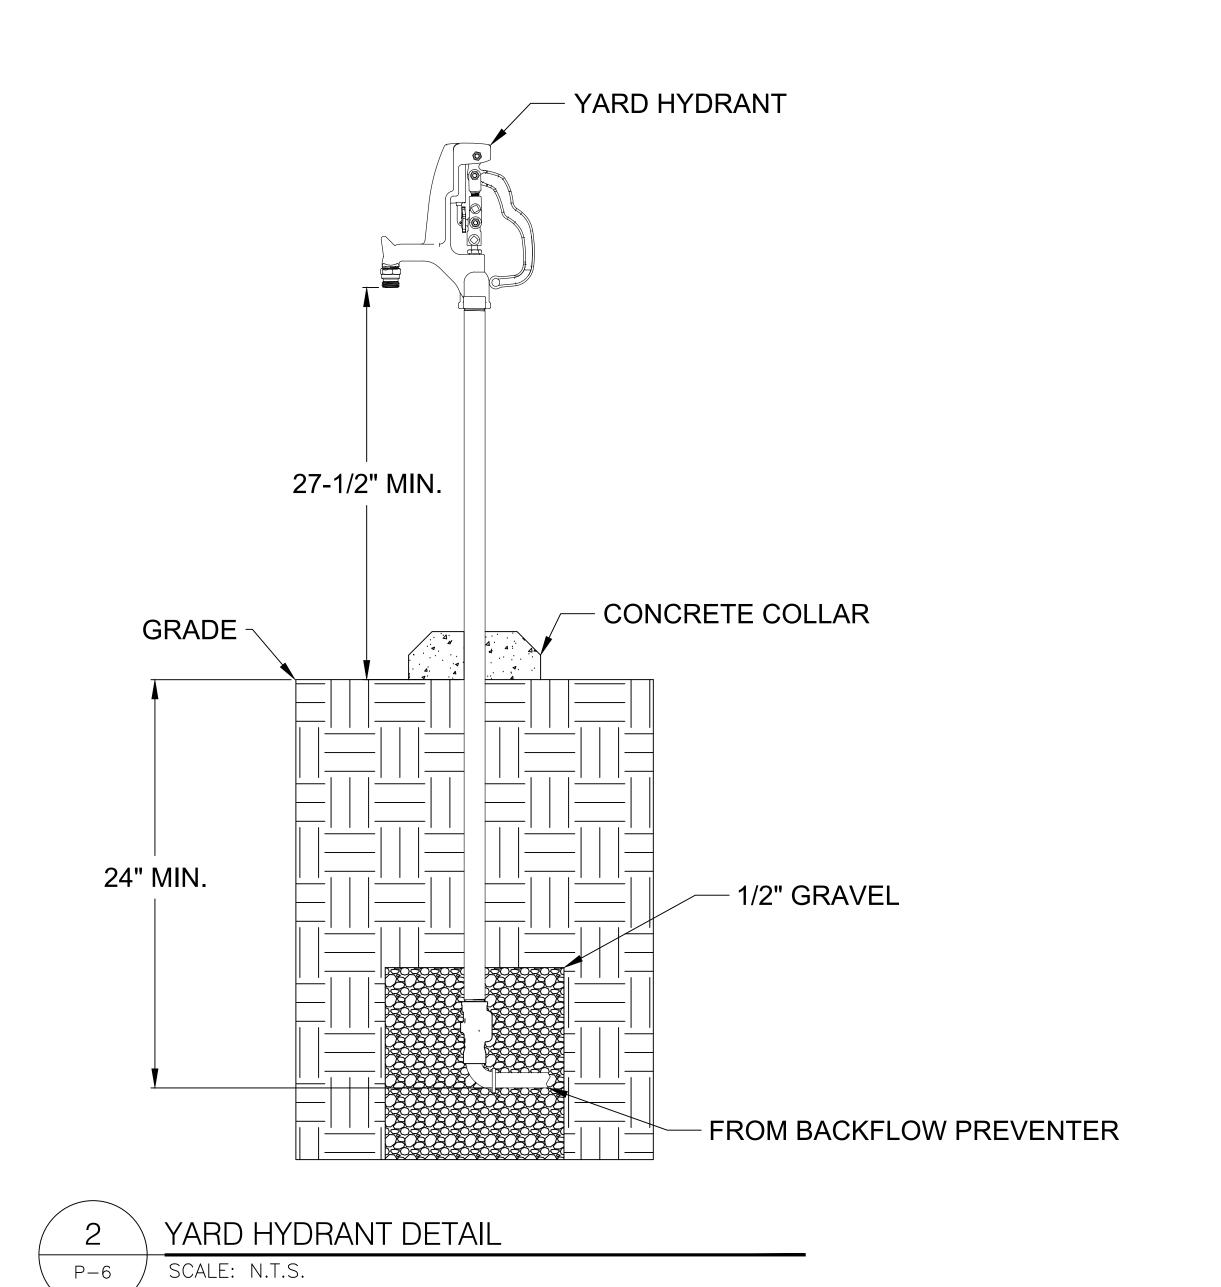


					PLUMBING FIXTURE SCHEDULE
MARK	DESCRIPTION	WV	CW	HW	SPECIFICATION
P1	WATER CLOSET	4" 2"	1"		PROVIDE WHITE VITREOUS CHINA FLUSH VALVE WATER CLOSET, FLOOR MOUNTED & FLOOR OUTLET, WITH SIPHON JET ACTION, INTEGRAL TRAP AND ELONGATED BOWL. THE TOP OF TOILET SEAT HEIGHT SHALL BE 17 TO 19 INCHES ABOVE FLOOR. PROVIDE WAX BOWL RING INCLUDING PLASTIC SLEEVE. PROVIDE WHITE SOLID PLASTIC ELONGATED OPEN—FRONT SEAT. PROVIDE A DUAL—FLUSH WATER CLOSET AND FLUSH VALVE COMBINATION THAT PROVIDES A 1.6 GALLON MAX STANDARD FLUSH WITH A 1.1 GALLON MAX LIGHT FLUSH. THE FLUSH VALVE SHALL BE SOLENOID—ACTIVATED WITH ELECTRICALLY OPERATED LIGHT BEAM SENSOR TO ENERGIZE THE SOLENOID. FLUSH VALVE SHALL BE HARDWIRED AC POWERED WITH UL APPROVED AC TRANSFORMER IN WALL MOUNTED ELECTRICAL BOX WITH COVER. PROVIDE FULLY MECHANICAL MANUAL OVERRIDE BUTTON THAT CAN FLUSH TOILET DURING A POWER OUTAGE. EXPOSED TO VIEW COMPONENTS SHALL BE CHROMIUM PLATED OR POLISHED STAINLESS STEEL.
P2	URINAL	2" 1½"	3/4"		PROVIDE WHITE VITREOUS CHINA FLUSH VALVE URINAL, WALL MOUNTED & WALL OUTLET, WITH SIPHON JET ACTION, INTEGRAL TRAP, AND EXTENDED SIDE SHIELDS. PROVIDE URINAL WITH THE RIM 24 INCHES ABOVE THE FLOOR. WATER FLUSHING VOLUME OF THE URINAL AND FLUSH VALVE COMBINATION SHALL BE 0.5 GALLONS PER FLUSH. THE FLUSH VALVE SHALL BE SOLENOID—ACTIVATED WITH ELECTRICALLY OPERATED LIGHT BEAM SENSOR TO ENERGIZE THE SOLENOID. FLUSH VALVE SHALL BE HARDWIRED AC POWERED WITH UL APPROVED AC TRANSFORMER IN WALL MOUNTED ELECTRICAL BOX WITH COVER. PROVIDE FULLY MECHANICAL MANUAL OVERRIDE BUTTON THAT CAN FLUSH URINAL DURING A POWER OUTAGE. EXPOSED TO VIEW COMPONENTS SHALL BE CHROMIUM PLATED OR POLISHED STAINLESS STEEL. PROVIDE CONCEALED CHAIR CARRIERS WITH VERTICAL STEEL PIPE SUPPORTS.
P3	LAVATORY	2" 1½"	1/2"	1/2"	PROVIDE SOLID SURFACE COUNTERTOP WITH INTEGRAL UNDERMOUNT OVAL BOWL. COUNTERTOP AND BOWL TO BE THE IDENTICAL NON-POROUS MATERIAL. MOUNT LAVATORY WITH THE FRONT RIM 34 INCHES ABOVE THE FLOOR. PROVIDE TOP MOUNTED SOLENOID—ACTIVATED LAVATORY FAUCET INCLUDING ELECTRICALLY OPERATED LIGHT BEAM SENSOR TO ENERGIZE THE SOLENOID. FAUCET SHALL BE HARDWIRED AC POWERED WITH UL APPROVED AC TRANSFORMER IN WALL MOUNTED ELECTRICAL BOX WITH COVER. WATER FLOW RATE SHALL NOT EXCEED 0.5 GPM WHEN MEASURED AT A FLOWING PRESSURE OF 60 PSI. PROVIDE CONCEALED CHAIR CARRIERS WITH VERTICAL STEEL PIPE SUPPORTS AND CONCEALED ARMS FOR THE LAVATORY.
Р4	WATER FOUNTAIN	11/4" 11/2"	3⁄8"		PROVIDE OUTDOOR RATED STAINLESS STEEL FREEZE RESISTANT BI-LEVEL DRINKING WATER FOUNTAIN. PROVIDE FOUNTAIN WITH STAINLESS STEEL SPLASH RECEPTOR, BASIN, AND CABINET. DUAL BUBBLERS SHALL BE CONTROLLED BY PUSH BUTTON ON FRONT OF CABINET. PROVIDE FREEZE-RESISTANT BOX ON INTERIOR WALL.
P5	ADA SHOWER	2"	1/2"	1/2"	PROVIDE ADA COMPLIANT TILE SHOWER WITH REQUIRED ACCESSORIES (SEAT/GRAB BARS/ETC.) — SEE ARCHITECTURAL SHEETS FOR TILE SHOWER SPECFICATION. PROVIDE ADA COMPLIANT SHOWERHEAD WITH HANDSHOWER. SHOWERHEAD WATER FLOW RATE SHALL BE 2.0 GPM WHEN MEASURED AT A FLOWING WATER PRESSURE OF 80 PSI. PROVIDE FLOW RESTRICTOR IN HANDSHOWER TO FLOW 2.0 GPM ALSO. SHOWER DRAINS SHALL HAVE A GALVANIZED BODY, INTEGRAL SLOTTED SEEPAGE PAN, AND A PERFORATED OR SLOTTED STRAINER. THE STRAINER SHALL BE ADJUSTABLE TO FLOOR THICKNESS AND SHALL BE CONSTRUCTED OF CHROMIUM—PLATED BRONZE, NICKEL—BRONZE OR NICKEL—BRASS.
P6	SHOWER	2"	1/2"	1/2"	PROVIDE ADA COMPLIANT TILE SHOWER WITH REQUIRED ACCESSORIES (SEAT/GRAB BARS/ETC.) — SEE ARCHITECTURAL SHEETS FOR TILE SHOWER SPECFICATION. SHOWERHEAD WATER FLOW RATE SHALL BE 2.0 GPM WHEN MEASURED AT A FLOWING WATER PRESSURE OF 80 PSI. SHOWER DRAINS SHALL HAVE A GALVANIZED BODY, INTEGRAL SLOTTED SEEPAGE PAN, AND A PERFORATED OR SLOTTED STRAINER. THE STRAINER SHALL BE ADJUSTABLE TO FLOOR THICKNESS AND SHALL BE CONSTRUCTED OF CHROMIUM—PLATED BRONZE, NICKEL—BRONZE OR NICKEL—BRASS.
P7	LAVATORY/SERVICE SINK	1½" 1½"	1/2"	1/2"	PROVIDE FREESTANDING 304 STAINLESS STEEL SINGLE COMPARTMENT SINK. BOWL DIMENSIONS TO BE MINIMUM 24"X24" AND 12" DEEP. BACKSPLASH TO BE 9". PROVIDE 8" TALL GOOSENECK FAUCET. LEGS TO BE GALVANIZED OR STAINLESS STEEL.
P8	OUTDOOR SERVICE SINK	2" 1½"	1/2"	1/2"	PROVIDE 72" 16-GAUGE 304 STAINLESS STEEL DISHTABLE WITH SINGLE COMPARTMENT. SINK TO HAVE MINIMUM 8" BACKSPLASH, MINIMUM 6" DEEP BOWL, AND RAISED LIP. SUPPORT LEGS TO BE STAINLESS STEEL. PROVIDE INDIRECT DRAIN TO FLOOR DRAIN. PROVIDE LEAD FREE HOT AND COLD FROST-PROOF WALL HYDRANT MOUNTED 8" ABOVE RIM.
P9	WASHER BOX	2" 1½"	1/2"	1/2"	PROVIDE WASHER BOX WITH DRAIN. WASHER BOX SHALL HAVE HOT AND COLD WATER CONNECTIONS WITH TURN VALVES. WATER CONNECTIONS TO BE COPPER SWEAT.
TP1	TRAP PRIMER DISTRIBUTION UNIT		1/2"		PROVIDE AUTOMATIC PRESSURE ACTIVATED TRAP PRIMER WITH DISTRIBUTION UNIT FOR 1 TO 4 OUTLETS.
HB1	HOSE BIB		1/2"		PROVIDE OUTDOOR WALL MOUNTED MILD CLIMATE BRASS HOSE BIB. HOSE BIB SHALL NOT REQUIRE THE USE OF KEY OR TOOL TO OPERATE.
HYD1	YARD HYDRANT		3/4"		PROVIDE OUTDOOR FREEZELESS YARD HYDRANT. YARD HYDRANT TO BE PROVIDED WITH 3/4" HOSE CONNECTION. WATER SHALL DRAIN BELOW THE FROST LINE WHEN THE HYDRANT IS CLOSED. RISER PIPE TO BE STAINLESS STEEL. 2 FOOT BURY DEPTH.
WH1	WATER HEATER		3/4"	3/4"	PROVIDE 50 GALLON ELECTRIC WATER HEATER, 240V/1P OPERATION, WITH DUAL 4500 WATT ELEMENTS, EXPANSION TANK, ASME T&P RELIEF VALVE, AND DRAIN VALVE. WATER HEATER SHALL HAVE REPLACEABLE ANODES. WATER HEATER CONTROLS SHALL HAVE AN ADJUSTABLE RANGE FROM 90 TO 160 °F. PROVIDE WATER HEATER WITH AN ENERGY FACTOR = 0.93 (MINIMUM OVERALL EFFICIENCY).
FD	FLOOR DRAIN				FLOOR DRAINS SHALL HAVE A CAST IRON BODY, INTEGRAL SLOTTED SEEPAGE PAN, AND A PERFORATED OR SLOTTED STRAINER. THE STRAINER SHALL BE ADJUSTABLE TO FLOOR THICKNESS AND SHALL BE CONSTRUCTED OF CHROMIUM-PLATED BRONZE, NICKEL-BRONZE OR NICKEL-BRASS. PROVIDE DRAIN WITH TRAP PRIMER CONNECTION, TRAP PRIMER, AND CONNECTION PIPING TO NEAREST FIXTURE.
FCO	FLOOR CLEANOUT				PROVIDE BRASS/BRONZE, CAST IRON OR GALVANIZED FLOOR CLEANOUTS WITH THREADED CLEANOUT PLUGS. PROVIDE ROUND FLOOR ACCESS COVERS ATTACHED TO PLUGS WITH SECURING SCREW. ACCESS COVERS SHALL BE CONSTRUCTED OF CHROMIUM—PLATED BRONZE, NICKEL—BRONZE, NICKEL—BRASS, OR STAINLESS STEEL. CLEANOUT ACCESS COVERS SHALL BE INSTALLED FLUSH WITH THE FINISHED FLOOR.
GCO	GRADE CLEANOUT				PROVIDE PVC GRADE CLEANOUTS WITH THREADED CLEANOUT PLUGS. PROVIDE ROUND VALVE BOX WITH TRAFFIC—RATED CLEANOUT COVER. VALVE BOX & COVER SHALL BE CONSTRUCTED OF CAST IRON OR DUCTILE IRON.
BFP1	BACKFLOW PREVENTER		2"		PROVIDE 2" TESTABLE LEAD FREE REDUCED PRESSURE ZONE (RPZ) BACKFLOW PREVENTER. ASSE 1013 AND NSF/ANSI 61 APPROVED. PROVIDE WITH WYE STRAINER.
BFP2	BACKFLOW PREVENTER		3/4"		PROVIDE 3/4" TESTABLE LEAD FREE REDUCED PRESSURE ZONE (RPZ) BACKFLOW PREVENTER. ASSE 1013 AND NSF/ANSI 61 APPROVED. PROVIDE WITH WYE STRAINER.
ENCL1	BACKFLOW ENCLOSURE				PROVIDE MINIMUM R8 INSULATED AND HEATED FIBERGLASS ENCLOSURE WITH DRAINPORTS. ENCLOSURE SHALL BE MOUNTED ON CONCRETE PAD AND BE REMOVABLE OR PROVIDE ACCESS TO BACKFLOW DEVICE FOR TESTING. HEATER(S) SHALL BE 120V SINGLE PHASE 1500 WATTS MAXIMUM, LISTED FOR USE IN DAMP OR WET LOCATIONS, AND MAINTAIN 40F INTERNAL AMBIENT TEMPERATURE.
ET1	EXPANSION TANK				PROVIDE 4.5 GALLON DIAPHRAGM EXPANSION TANK SUITABLE FOR POTABLE WATER.



GENERAL CONSTRUCTION NOTES:

- 1. NOT ALL WORK IS EXPLICITLY SHOWN ON THE DRAWINGS. MAKE ALL NECESSARY MINOR CORRECTIONS AND ADJUSTMENTS TO DELIVER A FULLY FUNCTIONAL AND COMPLETE SYSTEM.
- 2. DEMOLISH ALL EXISTING MECHANICAL EQUIPMENT. DO NOT REUSE ANY EXISTING COMPONENTS.

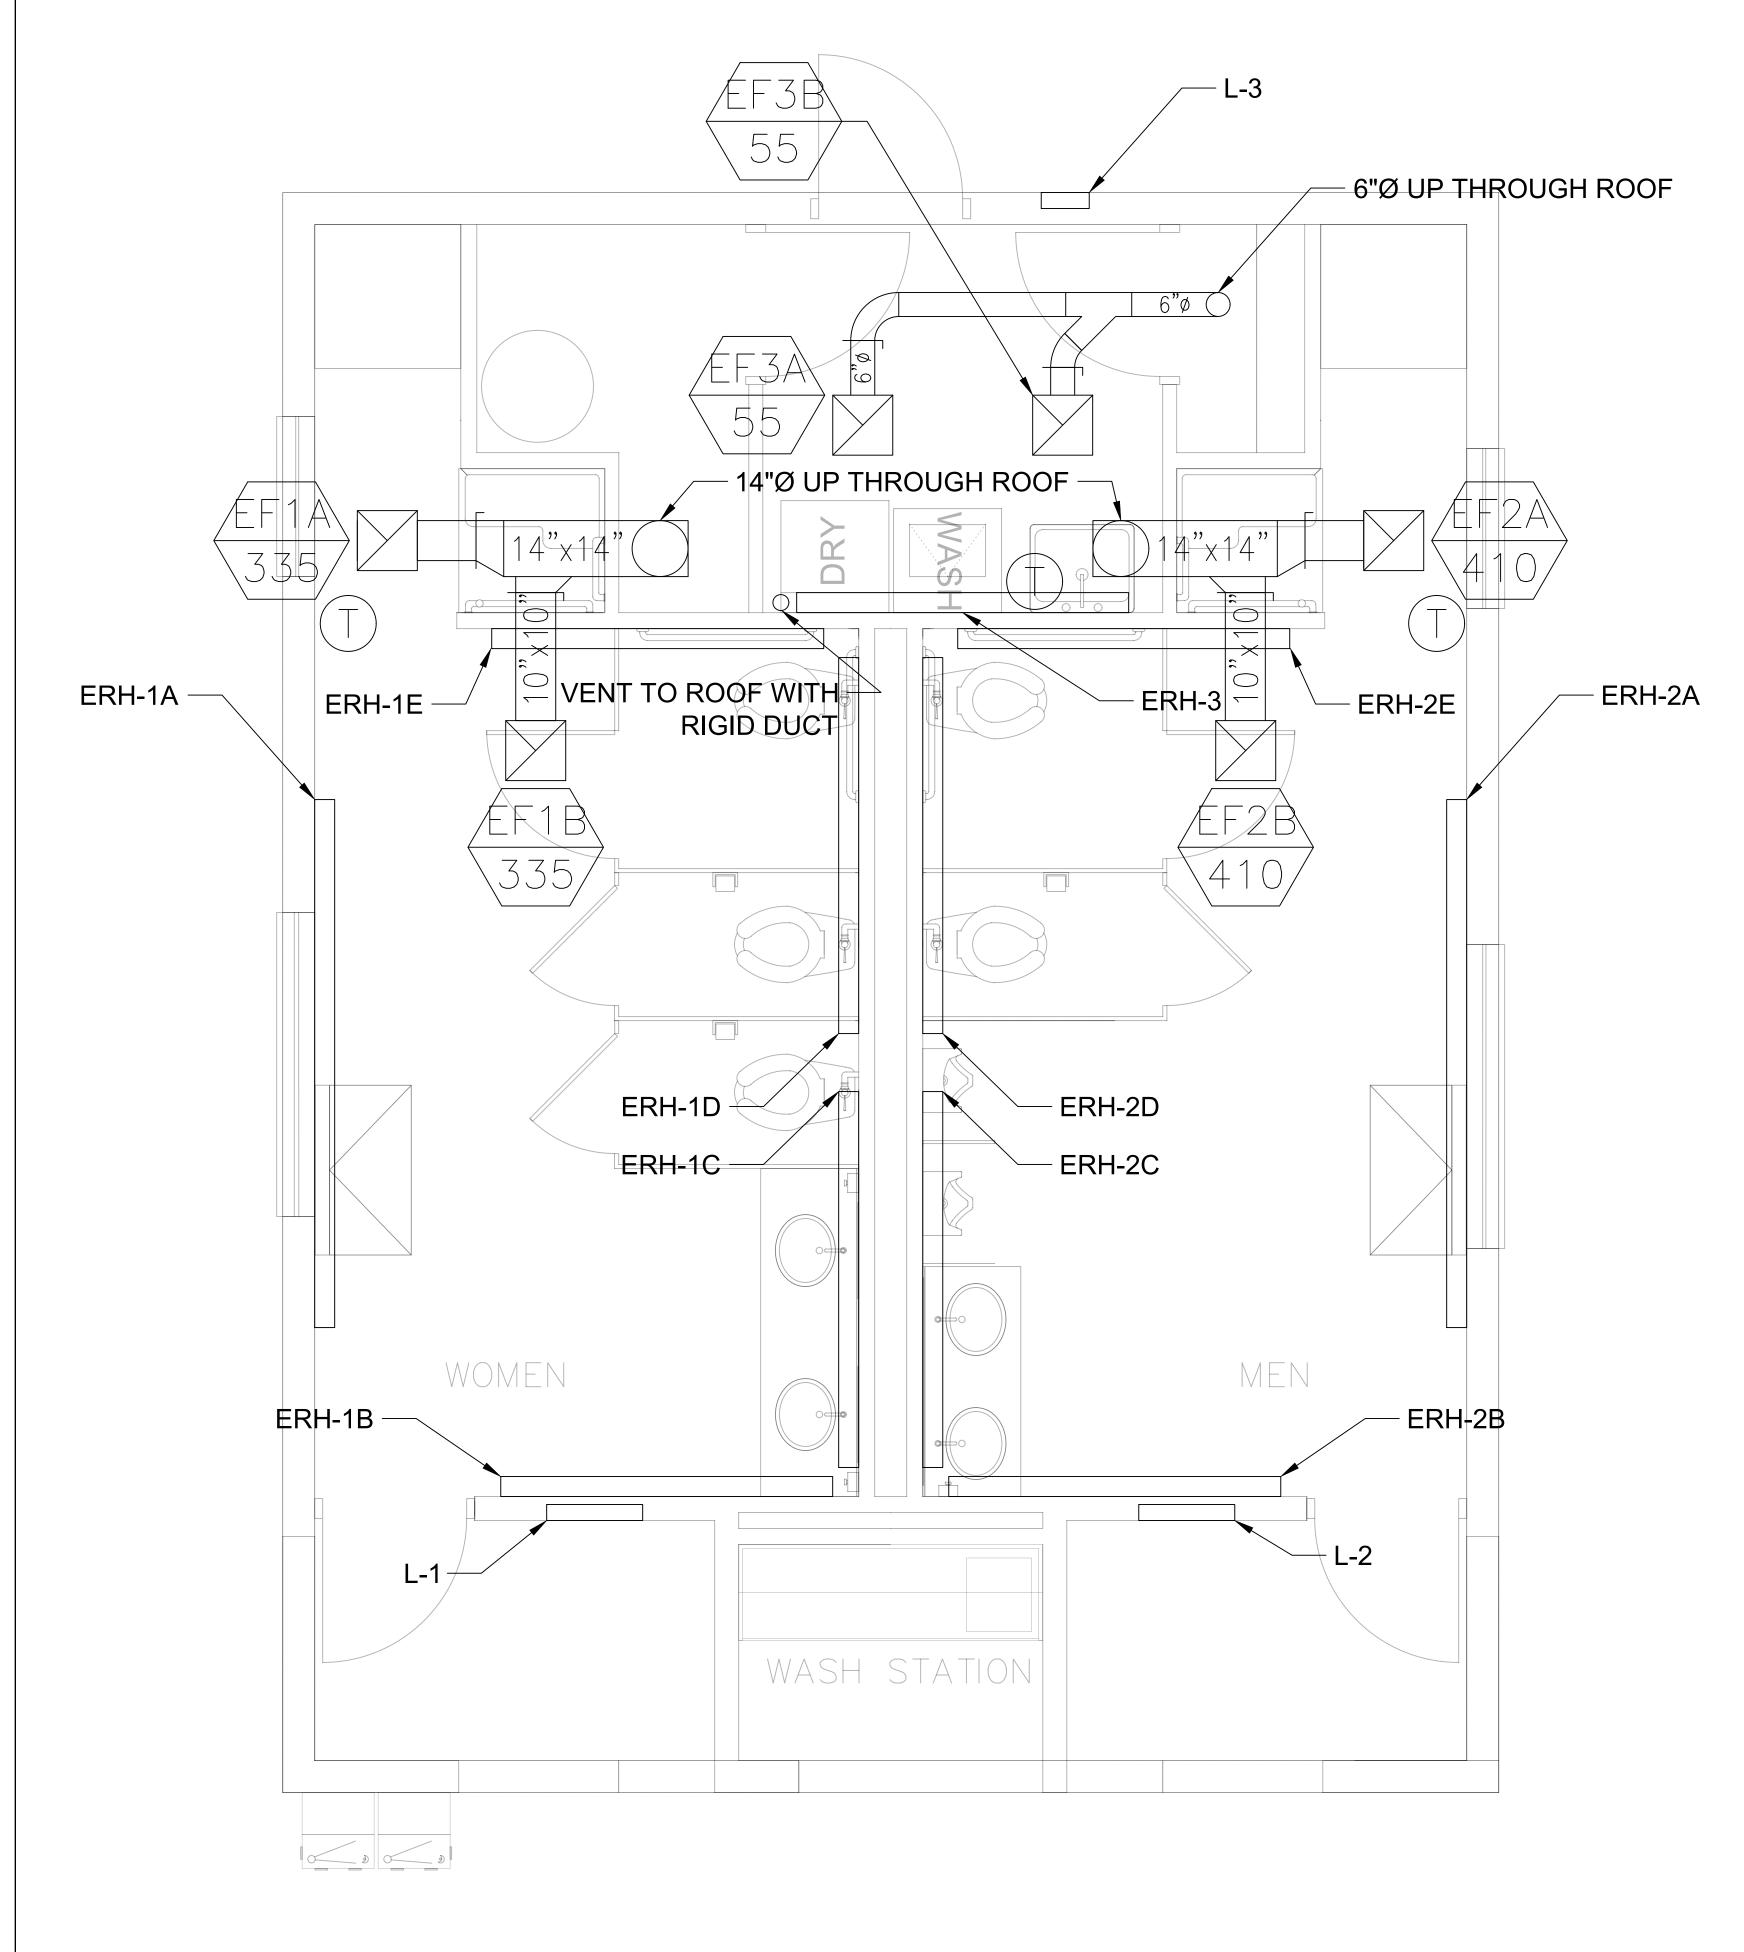



REVISIONS DATE APPROVED

EXHAUST FAN SCHEDULE										
MARK	LOCATION	CFM	ESP	MAX SONES	ELECTRICAL	HP	WATTS	NOTES		
EF-1A/1B	FEMALE HEAD	335	0.375"	9.0	120V/1P/60HZ	_	200	1-2		
EF-2A/2B	MALE HEAD	410	0.375"	9.0	120V/1P/60HZ	_	200	1-2		
EF-3A/3B	LAUNDRY	55	0.375"	9.0	120V/1P/60HZ	_	50	1-2		

- 1. FANS SHALL BE VARIABLE SPEED DIRECT DRIVE, CEILING MOUNTED WITH INTEGRAL BACKDRAFT DAMPER, DISCONNECT, SPEED CONTROL & EXHAUST GRILLE
- 2. ROUTE EXHAUST DUCT UP TO ROOF JACK

ELECTRIC HEATER SCHEDULE										
MARK	LOCATION	TYPE	WATTS	AMPS	ELECTRICAL	NOTES				
ERH-1A	FEMALE HEAD	COVE	1,800	7.5	240V/1P/60HZ	1-4				
ERH-1C/1D	FEMALE HEAD	COVE	1,200	5.0	240V/1P/60HZ	1-4				
ERH-1B/1E	FEMALE HEAD	COVE	1,050	4.4	240V/1P/60HZ	1-4				
ERH-2A	FEMALE HEAD	COVE	1,800	7.5	240V/1P/60HZ	1-4				
ERH-2C/2D	FEMALE HEAD	COVE	1,200	5.0	240V/1P/60HZ	1-4				
ERH-2B/2E	FEMALE HEAD	COVE	1,050	4.4	240V/1P/60HZ	1-4				
ERH-3	LAUNDRY	COVE	1,050	4.4	240V/1P/60HZ	1-4				

- 1. NICKEL-CHROME ALLOY WIRE HEATER
- 2. WALL-MOUNTED PER MANUFACTURER'S WRITTEN INSTRUCTIONS MANUFACTURER PROVIDED WALL BRACKETS
- 3. UL LISTED
- 4. UNIT SHALL BE MOUNTED 4" FROM CEILING

	LOUVER SCHEDULE										
MARK	LOCATION	AIRSTREAM	FACE SIZE (IN)	MIN FREE AREA (SQ FT)	MAX PRESS. DROP (IN)	NOTES					
L-1	FEMALE HEAD	INTAKE	24"X24"	1.89	0.1	1-4					
L-2	MALE HEAD	INTAKE	24"X24"	1.89	0.1	1-4					
L-3	LAUNDRY	INTAKE	12"X12"	0.34	0.1	1-4					

- 1. PROVIDE 18-16 ALUMINUM MESH INSECT SCREEN. LOUVER PERFORMANCE TO INCLUDE INSECT SCREEN.
- 2. LOUVER TO BE ALL ALUMINUM WITH DRAINABLE BLADES.
- 3. PROVIDE WITH ALUMINUM GRAVITY DAMPER. 4. COORDINATE COLOR WITH ARCHITECT.

SEQUENCE OF OPERATIONS

GENERAL:

- ALL SCHEDULES AND SETPOINT SHALL BE ADJUSTABLE.
- THERMOSTATS SHALL BE WALL MOUNTED.

ELECTRIC HEATER CONTROL:

- ERH-1A/1B/1C/1D/1E SHALL OPERATE VIA A SINGLE THERMOSTAT.
- ERH-2A/2B/2C/2D/1E SHALL OPERATE VIA A SINGLE THERMOSTAT.
- ERH-3 SHALL ÓPERATE VIA A SINGLE THERMOSTAT.
- ALL HEATERS SHALL MAINTAIN 68°F IN THEIR RESPECTIVE SPACES.

EXHAUST FAN CONTROL:

- EF-1A, EF-2A, AND EF-3A SHALL BE COMMANDED ON AND OFF WITH THE LIGHTING OCCUPANCY SENSOR.
- EF-1B SHALL BE CONTROLLED VIA A THERMOSTAT. THE EXHAUST FAN SHALL OPERATE WHEN THE TEMPERATURE IN THE SPACE IS GREATER THAN 80°F.
- BELOW 75°F THE EXHAUST FAN SHALL REMAIN OFF. • EF-2B SHALL BE CONTROLLED VIA A THERMOSTAT. THE EXHAUST FAN SHALL OPERATE WHEN THE TEMPERATURE IN THE SPACE IS GREATER THAN 80°F. BELOW 75°F THE EXHAUST FAN SHALL REMAIN OFF.
- EF-3B SHALL BE CONTROLLED VIA A THERMOSTAT. THE EXHAUST FAN SHALL OPERATE WHEN THE TEMPERATURE IN THE SPACE IS GREATER THAN 80°F. BELOW 75°F THE EXHAUST FAN SHALL REMAIN OFF.

	CAMP LESEONE, NORTH CAROLINA
DES. C J MAAS	
DR. C J MAAS	
CHK. J A ELLIOTT	l AS2818 HEAD REPAIRS
SUBMITTED BY: C J MAAS	
DESIGN DIR.J F ORR P.E.	MECHANICAL LAYOUT AND DETAILS
APPROVED: PWO OR OICC DATE	SIZE CODE IDENT. NO NAVFAC DRAWING NO.

FINAL

DETAILS


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MARINE CORPS BASE

ELECTRICAL LEGEND ELECTRICAL GENERAL NOTES: SYMBOL DESCRIPTION ALL ELECTRICAL WORK MUST BE IN FULL COMPLIANCE WITH NFPA 70 THE NORTH ADDITIONAL CONDUCTORS REQUIRED FOR CONTROL MUST BE INCLUDED EVEN IF 28. DO NOT COMBINE BRANCH CIRCUIT HOMERUNS UNLESS SPECIFICALLY INDICATED NOT EXPLICITLY SHOWN. ON THE DRAWINGS. CAROLINA STATE BUILDING CODE, ALL LOCAL CODES AND ORDINANCES AND IN ACCORDANCE WITH THE REQUIREMENTS OF THE LOCAL AUTHORITY HAVING LIGHT FIXTURE. SEE LIGHTING FIXTURE SCHEDULE. 13. SEAL ALL CONDUIT OPENINGS THROUGH EXTERIOR BUILDING WALLS AND ROOF 29. INSTALL WIRING DEVICES AT HEIGHTS AS SHOWN ON THE DRAWINGS. WATERTIGHT. 2. ALL EQUIPMENT PROVIDED BY THE CONTRACTOR MUST BE LISTED AND LABELED 30. PROVIDE GROUND FAULT CIRCUIT-INTERRUPTER PROTECTION FOR PERSONNEL IN RECESSED DOWN LIGHT FIXTURE. SEE LIGHTING FIXTURE BY A NATIONALLY-RECOGNIZED TESTING AGENCY, ACCEPTABLE TO THE 14. IN WET LOCATIONS AND EXTERIOR, ALL WIRING DEVICES MUST BE ACCORDANCE WITH THE NEC INCLUDING EXTERIOR RECEPTACLES AND SCHEDULE. AUTHORITY HAVING JURISDICTION, FOR THE CONDITIONS OF INSTALLATION. ALL WEATHER-RESISTANT LISTED WITH WEATHERPROOF WHILE IN USE COVER. RECEPTACLES IN AREAS SUBJECT TO POSSIBLE WET CONDITIONS. MATERIAL, EQUIPMENT AND DEVICES MUST BE NEW CURRENT PRODUCTS OF WALL MOUNTED EXTERIOR LIGHT FIXTURE. SEE LIGHTING 31. COORDINATE LOCATIONS OF MECHANICAL EQUIPMENT WITH THE RESPECTIVE MANUFACTURERS REGULARLY ENGAGED IN THE PRODUCTION OF SUCH 15. RACEWAYS PENETRATING FLOORS, CEILINGS OR WALLS MUST BE PROPERLY FIXTURE SCHEDULE. PRODUCTS. EQUIPMENT MUST BE SUITABLE FOR ITS APPLICATION (E.G. WHEN SEALED SMOKETIGHT. CONTRACTOR, VENDORS AND THE GOVERNMENT BEFORE ROUGH-IN. ADJUST INSTALLED OUTDOORS, IT MUST BE WEATHERPROOF, ETC.) LIGHTING FIXTURES, RECEPTACLES AND ELECTRICAL EQUIPMENT TO 16. ALL RACEWAYS MUST BE CONCEALED WHERE POSSIBLE. ACCOMMODATE THIS EQUIPMENT. ADVISE THE GOVERNMENT OF CONFLICTS OCCUPANCY WALL SWITCH, LOW VOLTAGE, AT 46" AFF UNLESS 3. THE CONTRACTOR MUST REVIEW ALL DRAWINGS AND SPECIFICATIONS FOR WORK BEFORE ROUGH-IN. OTHERWISE NOTED. LOW VOLTAGE WIRING IS TO BE PROVIDED REQUIREMENTS, THE AMOUNT OF SPACE AVAILABLE FOR ELECTRICAL EQUIPMENT, 17. INSTALL EXPOSED RACEWAYS PARALLEL TO OR AT RIGHT ANGLES TO NEARBY BUT IS NOT SHOWN ON DRAWINGS FOR CLARITY. PROVIDE SURFACES OR STRUCTURAL MEMBERS, AND FOLLOW THE SURFACE CONTOURS AS32. BEFORE COMMENCING WORK OR ORDERING MATERIALS, THE CONTRACTOR MUST AND LAYOUT HIS WORK IN A COMPATIBLE AND FUNCTIONAL MANNER. SWITCHES COMPATIBLE FOR LUMAIRES/LIGHTING SYSTEM. SEE MUCH AS POSSIBLE. NO DIAGONAL RUNS WILL BE ALLOWED. ALL CONDUITS MUST COORDINATE WITH OTHER TRADES AND VERIFY THE NAMEPLATE RATINGS OF ALL OCCUPANCY SENSOR DIAGRAMS. CONNECTED TO LOW VOLTAGE 4. UNLESS SPECIFICALLY NOTED OTHERWISE, SYSTEMS PROVIDED OR INSTALLED BY BE RUN STRAIGHT WITH QUALITY WORKMANSHIP-LIKE MANNER. RUN PARALLEL OR EQUIPMENT (MOTORS, HEATERS, COMPRESSORS, ETC.) AND ADJUST THE RATINGS CEILING SENSOR. THE CONTRACTOR MUST BE COMPLETE AND FULLY-FUNCTIONING AFTER BANKED RACEWAYS TOGETHER ON COMMON SUPPORTS WHERE PRACTICAL. OF THE ELECTRICAL EQUIPMENT (SWITCHES, FUSES, CIRCUIT BREAKERS, MAKE BENDS IN PARALLEL OR BANKED RUNS FROM SAME CENTERLINE TO MAKE FEEDERS, ETC.) AS APPROPRIATE TO SERVE THIS EQUIPMENT. INSTALLATION. INCIDENTAL COMPONENTS MAY NOT BE SHOWN, AND ALL WORK STANDARD TOGGLE SWITCH AT 46" AFF UNLESS OTHERWISE BENDS PARALLEL. WHICH MAY BE REASONABLY IMPLIED AS BEING INCIDENTAL TO THIS WORK, BUT NOTED. 120VAC, 20A. REQUIRED FOR THE PROPER OPERATION OF THE EQUIPMENT OR SYSTEM MUST BE 33. ENERGIZE EQUIPMENT ONLY AFTER OBTAINING PERMISSION FROM THE CONTRACTOR PROVIDING THE EQUIPMENT. PROVIDED BY THE CONTRACTOR AND INCLUDED IN THE BID. ADDITIONAL CIRCUITS 18. PATCHING OF WATERPROOFED SURFACES MUST RENDER THE AREA OF THE MUST BE INSTALLED WHEREVER NEEDED TO CONFORM TO THE SPECIFIC PATCHING COMPLETELY WATERPROOF. 34. UNLESS SPECIFICALLY NOTED OTHERWISE, THE CONTRACTOR MUST MAKE FINAL REQUIREMENTS OF EQUIPMENT. RECEPTACLE, DUPLEX, 120VAC, 20A, MOUNTED 16" AFF, UNLESS 19. ALL MOTORS AND OTHER VIBRATING EQUIPMENT MUST BE CONNECTED TO THE CONNECTIONS TO ALL UTILIZATION EQUIPMENT SHOWN ON THE DRAWINGS. OTHERWISE NOTED. (SEE ELECTRICAL MOUNTING HEIGHT CONDUIT SYSTEM BY MEANS OF A SHORT SECTION (18 INCH MINIMUM) OF FLEXIBLE VERIFY THE TYPE OF FINAL CONNECTION AND PROVIDE APPROPRIATE WIRING 5. TEMPORARY POWER CONNECTIONS AS REQUIRED MUST BE PROVIDED BY THE GFCI - GROUND FAULT CIRCUIT INTERRUPTER, 120VAC, 20A. METHOD. THE CONTRACTOR MUST COORDINATE WITH THE MECHANICAL TRADE. CONTRACTOR AND INCLUDED IN THE BID. ALL TEMPORARY EQUIPMENT WIRING CONDUIT UNLESS OTHERWISE INDICATED. AN EQUIPMENT GROUNDING MOUNTED 24" AFF WP - WEATHERPROOF GFCI MUST BE IN ACCORDANCE WITH THE NATIONAL ELECTRICAL CODE. THE CONDUCTOR MUST BE INSTALLED INSIDE THE FLEXIBLE CONDUIT AND TERMINATE PRIOR TO ORDERING OR INSTALLATION OF ANY EQUIPMENT, TO VERIFY AT THE LOAD END WITH AN APPROVED GROUNDING CLAMP OR LUG. MECHANICAL EQUIPMENT REQUIREMENTS ARE PROVIDED IN THE ELECTRICAL CONTRACTOR MUST PROVIDE DETAILS, METHODS, MATERIALS, ETC. FOR REVIEW PRIOR TO MAKING TEMPORARY CONNECTIONS. FURNISH AND INSTALL ALL DESIGN. THE CONTRACTOR WILL NOT BE COMPENSATED FOR COSTS ASSOCIATED DISCONNECT SWITCH, FUSED, HEAVY DUTY, SIZE AS INDICATED 7V 30A/3/3R, EQUIPMENT AND MATERIALS INCLUDING CONTROL EQUIPMENT, MOTOR STARTERS, 20. SURFACE MOUNTED PANELBOARDS, JUNCTION, OUTLET AND PULL BOXES, WITH CHANGING THE ELECTRICAL SYSTEMS TO MATCH UTILIZATION EQUIPMENT. ON DRAWINGS BRANCH AND FEEDER CIRCUIT BREAKERS, PANELBOARDS, TRANSFORMERS, ETC. RACEWAYS, ETC., INSTALLED ON EXTERIOR SURFACES OR INSIDE ON EXTERIOR EVEN IF THE ELECTRICAL WORK IS INSTALLED PER THE ELECTRICAL DRAWINGS. ##A = DISCONNECT SIZE / # = NUMBER OF POLES / # = NEMA WALLS MUST BE SUPPORTED BY SPACERS TO PROVIDE A MINIMUM 1/4" MINIMUM FOR TEMPORARY POWER. COORDINATE WITH THE UTILITY PROVIDER AS RATING, /##AF = FUSE SIZE 35. THE CONTRACTOR MUST COORDINATE ALL EQUIPMENT TERMINATIONS, PLUGS REQUIRED. CLEARANCE BETWEEN THE WALL AND EQUIPMENT. AND CORDSETS WITH VENDOR EQUIPMENT AND VERIFY ALL DEVICE LOCATIONS 6. THE WORK MUST INCLUDE COMPLETE TESTING OF ALL EQUIPMENT AND WIRING AT 21. TYPED PANELBOARD DIRECTORIES INSTALLED IN THE PANELBOARD DOOR POCKET FOR SPECIALITY EQUIPMENT WITH CASEWORK PRIOR TO ROUGH-IN. CONDUIT, HOME RUN TO PANEL BOARD THE COMPLETION OF WORK AND ANY MINOR CORRECTIONS, CHANGES OR MUST REFLECT FINAL CONDITIONS AND ACTUAL ROOM NAMES AND NUMBERS IN ADJUSTMENTS NECESSARY FOR THE PROPER FUNCTIONING OF THE SYSTEM AND ADDITION TO THE GENERAL DESCRIPTION SHOWN ON THE PANEL SCHEDULES ON 36. INSTALLATION INFORMATION PACKED WITH DEVICES AND EQUIPMENT MUST BE EQUIPMENT. THE DRAWINGS. RETAINED FOR INCLUSION IN THE OPERATIONS AND MAINTENANCE MANUALS. SWITCHED LEG NON-SWITCHED LEG 22. CONDUCTOR SIZING IS BASED ON 75 DEGREE C. COPPER NEC RATINGS, UNLESS 37. THE CONTRACTOR SHALL VISIT THE SITE AND BECOME FAMILIAR WITH THE . ALL ELECTRICAL EQUIPMENT MUST, AT ALL TIMES DURING CONSTRUCTION, BE ADEQUATELY PROTECTED AGAINST MECHANICAL INJURY, OR DAMAGE BY WATER NOTED OTHERWISE. THE CONTRACTOR MUST VERIFY, PRIOR TO INSTALLATION OF EXISTING ELECTRICAL SYSTEMS AND THE EXISTING BUILDING. THE SUBMISSION OF THE PROPOSAL BY THE CONTRACTOR SHALL BE CONSIDERED EVIDENCE THAT AND/OR THE ELEMENTS. ELECTRICAL EQUIPMENT MUST NOT BE STORED OUT OF CONDUCTORS OR CONDUIT FEEDING ANY EQUIPMENT, THE ELECTRICAL PANELBOARD, SURFACE OR RECESSED MOUNTED AS SHOWN. DOORS, BUT MUST BE STORED IN DRY PERMANENT SHELTERS. IF AN APPARATUS EQUIPMENT IS RATED FOR USE WITH 75 DEGREE C. WIRING. IF ANY EQUIPMENT IS HE OR HIS REPRESENTATIVE HAS VISITED THE SITE AND BUILDINGS AND NOTED SIZE, RATINGS, AND MOUNTING AS INDICATED ON PANEL HAS BEEN DAMAGED. OR HAS BEEN SUBJECT TO POSSIBLE INJURY BY WATER OR RATED FOR USE WITH LESS THAN 75 DEGREE C. CONDUCTORS, THE CONTRACTOR THE LOCATION AND CONDITIONS UNDER WHICH THE WORK WILL BE PERFORMED SCHEDULE. CONTRACTOR IS RESPONSIBLE FOR REQUIRED THE ELEMENTS, SUCH DAMAGE MUST BE REPLACED AT NO ADDITIONAL COST. MUST NOTIFY THE GOVERNMENT IMMEDIATELY FOR EVALUATION/CORRECTION. AND THAT HE TAKES FULL RESPONSIBILITY OF ALL FACTORS GOVERNING HIS CLEARANCE IN FRONT OF ELECTRICAL PANEL. SEE NEC TABLE WORK. NO EXTRAS WILL BE CONSIDERED BECAUSE OF ADDITIONAL WORK 110.26 WORKING SPACES FOR ADDITIONAL CLEARANCE CONDITIONS. 8. DO NOT SCALE ELECTRICAL DRAWINGS. CONTRACTOR MUST FIELD VERIFY ALL 23. DO NOT PULL CONDUCTORS UNTIL THE CONDUIT SYSTEM IS COMPLETE IN EVERY NECESSITATED BY EXISTING JOB CONDITIONS THAT ARE NOT INDICATED ON THE DETAIL. IN THE CASE OF CONCEALED WORK, "COMPLETE" MEANS UNTIL ALL DIMENSIONS. DRAWINGS. ROUGH PLASTERING OR MASONRY HAS BEEN COMPLETED. RADIANT HEATER; SEE MECHANICAL SHEETS FOR DETAILS 38. SAFETY 9. CIRCUIT LAYOUTS ARE NOT INTENDED TO SHOW THE NUMBER OF FITTINGS, OR OTHER INSTALLATION DETAILS. UNLESS NOTED OTHERWISE, THE EXACT ROUTING 24. WHERE SIZE IS NOT SHOWN ON THE DRAWINGS, BRANCH CIRCUITS MUST CONSIST A. COMPLY WITH OSHA AND NEC ARC FLASH PROTECTION REQUIREMENTS. OF FEEDER AND BRANCH CIRCUIT RACEWAYS AND CABLES IS THE RESPONSIBILITY OF #12 OR #10 AWG MINIMUM PHASE, NEUTRAL AND EQUIPMENT GROUND OF THE CONTRACTOR. RISER AND GENERAL CIRCUIT ARRANGEMENTS ARE CONDUCTORS IN 3/4" MINIMUM RACEWAY. B. FOR EQUIPMENT BEING REMOVED AND REPLACED, THE CONTRACTOR SHALL EXISTING OVERHEAD SECONDARY SHOWN SCHEMATICALLY/DIAGRAMMATICALLY ONLY. THE CONTRACTOR MUST DE-ENERGIZE THE EQUIPMENT AND MAKE IT SAFE PRIOR TO REMOVAL AND 25. USE #10 AWG CONDUCTORS FOR 20 AMPERE, 120 VOLT BRANCH CIRCUITS WITH A ROUTE CONDUITS AS REQUIRED BY THE CONDITIONS OF THE INSTALLATION. COMPLY WITH OSHA REQUIREMENTS FOR LOCKING-OUT AND TAGGING EQUIPMENT TO PREVENT INADVERTENT RE-ENERGIZING IOTAL INSTALLED LENGTH GREATER THAN 75 FEET AND/OR BRANCH CIRCUI 10. UNLESS DIMENSIONED, DEVICE LOCATIONS SHOWN ON THE DRAWINGS ARE HOMERUNS LONGER THAN 50 FEET, I.E.; #12 AWG INCREASED TO #10 AWG FOR APPROXIMATE. ADJUST EXACT LOCATIONS AS REQUIRED TO SERVE THE INTENDED MOTOR CONNECTION; EXHAUST FAN. SEE MECHANICAL SHEETS RECEPTACLE BRANCH CIRCUITS OVER 75 FEET TOTAL LENGTH (INCLUDING THE FOR DETAILS. PURPOSE AND TO AVOID CONFLICTS AND INTERFERENCES WITH OTHER TRADES. HOMERUN SEGMENT) AND HOMERUNS OVER 50 FEET. IF 277 VOLT CIRCUITS ARE SHOWN, USE #10 AWG CONDUCTORS FOR 20 AMPERE, 277 VOLT BRANCH CIRCUITS IF NOT SHOWN ON THE ARCHITECTURAL DRAWINGS OR DIMENSIONED ON THE WITH TOTAL INSTALLED LENGTH GREATER THAN 200 FEET AND/OR BRANCH ELECTRICAL DRAWINGS, VERIFY EXACT LOCATION WITH THE GOVERNMENT PRIOR TO ROUGH-IN. CIRCUIT HOMERUNS LONGER THAN 125 FEET, I.E.; #12 AWG INCREASED TO #10 AWG FOR RECEPTACLE BRANCH CIRCUITS OVER 75 FEET TOTAL LENGTH 11. CONDUIT TERMINATING IN PRESSED STEEL BOXES MUST HAVE DOUBLE LOCKNUTS (INCLUDING THE HOMERUN SEGMENT) AND HOMERUNS OVER 50 FEET. AND INSULATED BUSHINGS. CONDUITS TERMINATING IN GASKETED ENCLOSURES 26. KEEP CONDUCTOR SPLICES TO A MINIMUM. INSTALL SPLICES AND TAPES THAT MUST BE TERMINATED WITH GROUNDING TYPE CONDUIT HUBS. POSSESS EQUIVALENT OR BETTER MECHANICAL STRENGTH AND INSULATION 12. BRANCH CIRCUIT HOMERUNS SHOWN ON DRAWINGS INDICATE PHASE RATINGS THAN CONDUCTORS BEING SPLICED. USE SPLICE AND TAP CONNECTORS COMPATIBLE WITH CONDUCTOR MATERIAL. INSTALL CONDUCTORS AT EACH CONDUCTORS, NEUTRAL, EQUIPMENT GROUND CONDUCTORS AS REQUIRED. OUTLET WITH AT LEAST 6 INCHES OF SLACK. CONNECT OUTLETS AND COMPONENTS TO WIRING AND TO GROUND AS INDICATED AND INSTRUCTED BY

THE MANUFACTURER.

TO THE SERVING PANELBOARD.

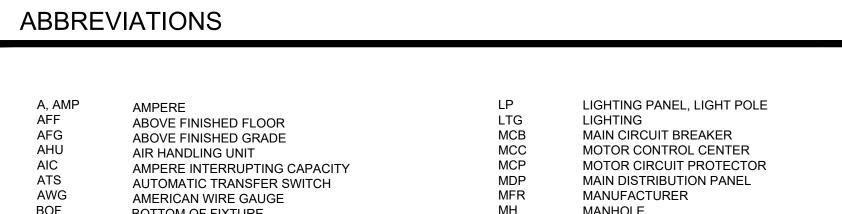

BOF MANHOLE BOTTOM OF FIXTURE BRKR MAIN LUGS ONLY BREAKER C, CND MTD CONDUIT MOUNTED CAB MTG MOUNTING CABINET CAT MTS MANUAL TRANSFER SWITCH CATALOG MEDIUM VOLTAGE CHLORINE N / NEUT CB NEUTRAL CIRCUIT BREAKER CCTV NOT APPLICABLE CLOSED CIRCUIT TELEVISION CKT NORMALLY CLOSED CIRCUIT CLG NATIONAL ELECTRIC CODE CEILING CP NOT IN CONTRACT CONTROL PANEL CR NIGHT LIGHT CONTROL RELAY, CORROSION RESISTANT NORMALLY OPEN CONTROL SWITCH CV NOT TO SCALE CONTROL VALVE **CURRENT TRANSFORMER** CU PUBLIC ADDRESS COPPER EF PULL BOX, PUSH-BUTTON EXHAUST FAN **EMER** POWER FACTOR **EMERGENCY** EMT ELECTRICAL METALLIC TUBING **ENCL** PROGRAMMABLE LOGIC CONTROLLER **ENCLOSURE** EQUIP **EQUIPMENT EWC** POWER PANEL, POWER POLE ELECTRIC WATER COOLER EWH PORTABLE POWER EQUIPMENT CABLE ELECTRIC WATER HEATER **EPRF** POTENTIAL TRANSFORMER EXPLOSION PROOF FΑ FIRE ALARM RECPT, RCP RECEPTACLE FAAP FIRE ALARM ANNUNCIATOR PANEL **FACP** REQUIRED FIRE ALARM CONTROL PANEL FBO RIGID GALVANIZED STEEL CONDUIT FURNISHED BY OTHERS FLA ROOM **FULL LOAD AMPS** FLUOR RTU REMOTE TELEMETRY UNIT FLUORESCENT FLR DC MOTOR DRIVE FLOOR **FWE** SHEET **FURNISHED WITH EQUIPMENT** GEN SURGE PROTECTION DEVICE GENERATOR G, GND SPECIFICATION GROUND SELECTOR SWITCH GROUND FAULT CURRENT INTERRUPTER HANDHOLE STAINLESS STEEL HID HIGH INTENSITY DISCHARGE SWITCH HOA SWBD SWITCHBOARD HAND-OFF-AUTO HP SWGR SWITCH GEAR HORSE POWER HPF TEL HIGH POWER FACTOR TELEPHONE HPS TWISTED PAIR SHIELDED HIGH PRESSURE SODIUM HTR TRANSIENT VOLTAGE SURGE SUPPRESSER TYP HV TYPICAL HIGH VOLTAGE UNDERGROUND HERTZ UNIT HEATER INTERMEDIATE METALLIC CONDUIT

INCANDESCENT

KILOVOLT AMPERE

KILOWATT-HOURS

THOUSAND CIRCULAR MILLS

JUNCTION BOX THOUSAND

KILOWATTS

KCMIL

KVA

KW

UNLESS OTHERWISE NOTED

VARIABLE FREQUENCY DRIVE

WEATHERPROOF TELEPHONE ENCLOSURE

UTILITY

WIRE. WATT

WATT-HOUR

WEATHERPROOF


EXISTING RELOCATED

TRANSFORMER

UTIL

XFMR

X/R

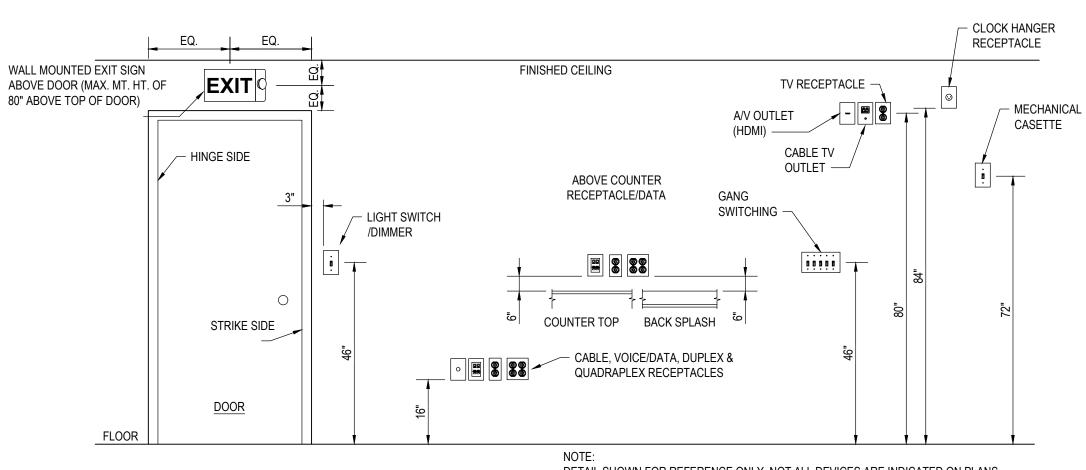

27. DO NOT SPLICE BRANCH CIRCUIT HOMERUNS WITHOUT THE PERMISSION OF THE GOVERNMENT. HOMERUNS MUST BE CONTINUOUS FROM THE LAST OUTLET BOX


DETAIL SHOWN FOR REFERENCE ONLY, NOT ALL DEVICES ARE INDICATED ON PLANS.

ELECTRICAL DEVICES MOUNTING HEIGHT

- A. THE CONTRACTOR SHALL NOT RELEASE TO ANYONE OUTSIDE THE CONTRACTOR'S

	FII	NAL	-		E1(00
				NAVAL FACILITIES ENG NE CORF P LEJEUNE, NORTH	PS BAS	SE
DES.	K. BROWN		RH	LDING AS	\$2818	
DR.	K. BROWN					
CHK.	K. BROWN		Н	EAD REP	AIRS	
SUBMITTED BY:	M. HUNTER		FLECTE	RICAL LEGEND	% NOTES	
DESIGN DIR.	J.F. ORR		ELECTR	RICAL LEGEND	& NOIES	
APPROVED: PWO OR OICC:	DATE:	SIZE	CODE IDENT. NO	NAVF	AC DRAWING NO).
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	ORGANIZATION ANY UNCLASSIFIED INFORMATION, REGARDLESS OF MEDIUM (E.G., FILM, TAPE, DOCUMENT), PERTAINING TO ANY PART OF THIS CONTRACT OR ANY PROGRAM RELATED TO THIS CONTRACT, UNLESS: (1) THE CONTRACTING OFFICER HAS GIVEN PRIOR WRITTEN APPROVAL; OR (2) THE INFORMATION IS OTHERWISE IN THE PUBLIC DOMAIN REFORE THE				DEPARTMENT OF THE NAV		RPS	BAS	SE
	(2) THE INFORMATION IS OTHERWISE IN THE PUBLIC DOMAIN BEFORE THE	DES.	K. BROWN		RIII	LDING A	152	818	
	DATE OF RELEASE.	DR.	K. BROWN						
В.	REQUESTS FOR APPROVAL SHALL IDENTIFY THE SPECIFIC INFORMATION TO BE	CHK.	K. BROWN		H	EAD RE	PAIR	75	
	RELEASED, THE MEDIUM TO BE USED, AND THE PURPOSE FOR THE RELEASE. THE CONTRACTOR SHALL SUBMIT ITS REQUEST TO THE CONTRACTING OFFICER AT LEAST	SUBMITTED BY:	M. HUNTER		FLECTE	UCAL LEGEN	ID &	NOTES	
	45 DAYS BEFORE THE PROPOSED DATE FOR RELEASE.	DESIGN DIR.	J.F. ORR		ELECTRICAL LEGEND & NOTES				
C.	THE CONTRACTOR AGREES TO INCLUDE A SIMILAR REQUIREMENT IN EACH	APPROVED: PWO OR OICC:	DATE:	SIZE	CODE IDENT. NO	N/	AVFAC D	DRAWING NO).
٥.	SUBCONTRACT UNDER THIS CONTRACT. SUBCONTRACTORS SHALL SUBMIT REQUESTS FOR AUTHORIZATION TO RELEASE THROUGH THE PRIME CONTRACTOR TO THE	PWO or OICC		E1	80091	6	003	39623)
	CONTRACTING OFFICER.	SATISFACTORY TO:	DATE:			CONST. CON	TR. NE],	22-0005
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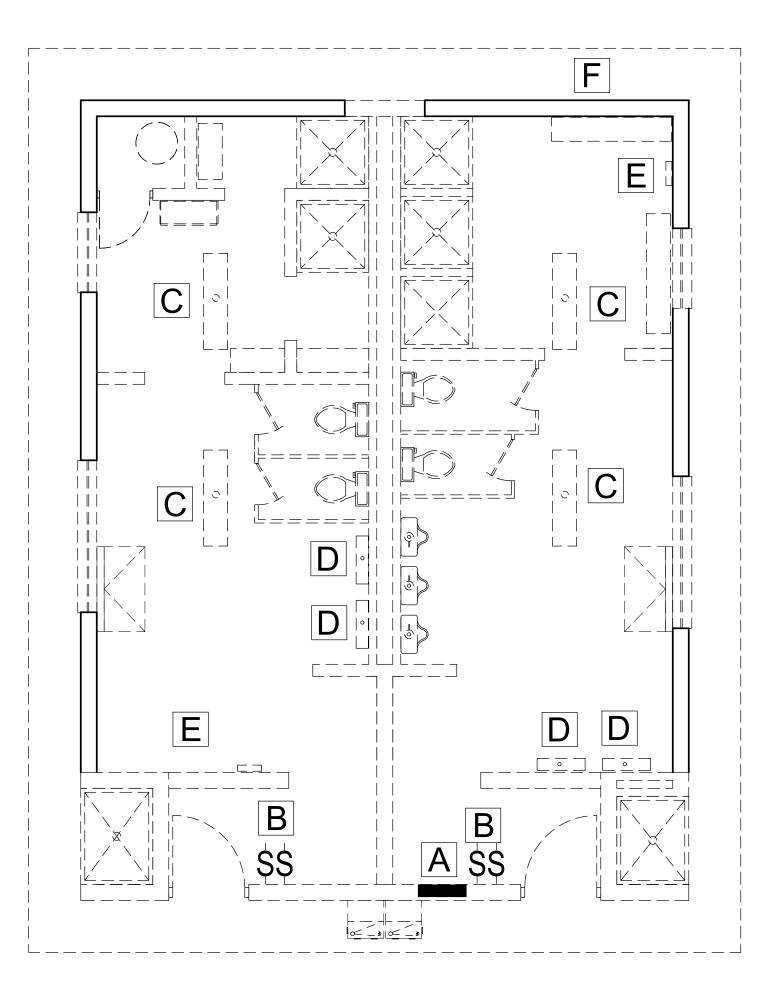


ELECTRICAL SITE PLAN

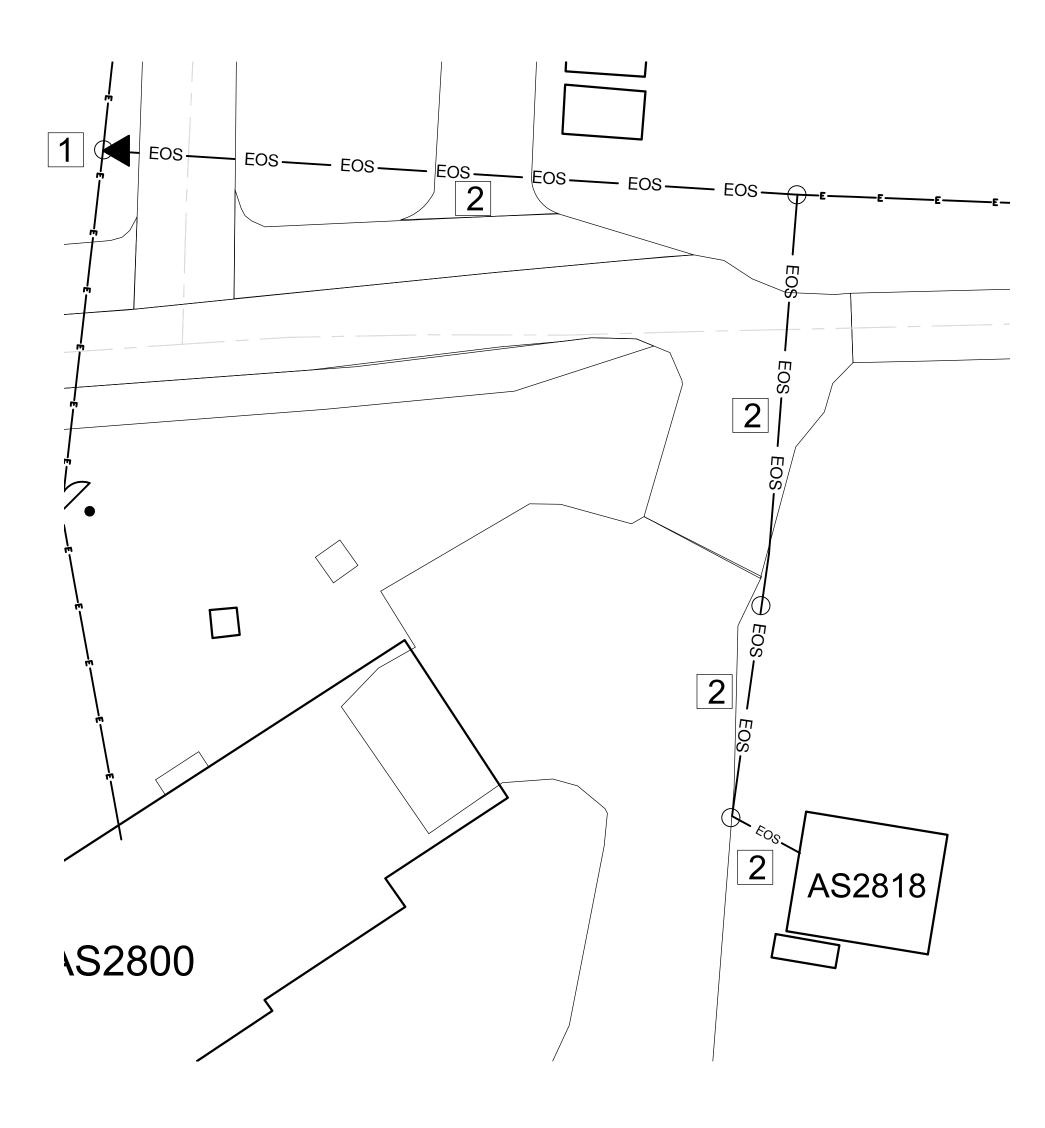SCALE: NTS

SITE PLAN KEYED NOTES

- 1 EXISTING 75 KVA POLE MOUNTED TRANSFORMER TO REMAIN.
- 2 REMOVE EXISTING OVERHEAD SECONDARY CONDUCTORS SERVING AS2818. PROVIDE NEW 2/0 OVERHEAD TRIPLEX BACK (APPROX. 500FT TOTAL) TO NEW WEATHERHEAD AND NEW 200A PANELBOARD MDP.



DEMOLITION PLAN

SCALE: NTS

DEMOLITION GENERAL NOTES:

- DEMOLISH ELECTRICAL IN WORK AREA.
- 2. REMOVE LUMINAIRE(S), CONDUCTOR(S), SWITCH(ES), AND CONDUIT(S) SERVING THE IDENTIFIED WORK AREA,
- 3. REMOVE RECEPTACLE(S), CONDUCTOR(S), AND CONDUIT(S) SERVING THE IDENTIFIED WORK AREA BACK TO
- SOURCE.
 4. REMOVE EXHAUST FANS, HEATERS, WATER HEATERS, CONDUCTOR(S), AND CONDUIT(S) SERVING THE WORK
- AREA BACK TO SOURCE.


 5. REMOVE EXISTING PANELBOARD, CONDUCTOR(S), AND CONDUIT(S) SERVING THE WORK AREA.
- 6. DEMOLITION PLAN IS A REPRESENTATION OF EXISTING CONDITIONS. ACTUAL CONDITIONS WILL VARY. DEMO SCOPE SHALL BE APPLIED TO ACTUAL CONDITIONS.

DEMOLITION KEYED NOTES

- A EXISTING 100A MLO FLUSH PANELBOARD. 1¢ 240V/120. DEMOLISH.
- B SWITCH, TIMER, FLUSH MOUNTED. DEMOLISH.
- C LUMINAIRE. 2-F32T12, SURFACE MOUNT. DEMOLISH.
- D LUMINAIRE. VANITY FIXTURE. SURFACE MOUNT. DEMOLISH.
- E HEATER. SURFACE MOUNT. DEMOLISH.
- F WEATHERHEAD. DEMOLISH.

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- C. THE CONTRACTOR AGREES TO INCLUDE A SIMILAR REQUIREMENT IN EACH SUBCONTRACT UNDER THIS CONTRACT. SUBCONTRACTORS SHALL SUBMIT REQUESTS FOR AUTHORIZATION TO RELEASE THROUGH THE PRIME CONTRACTOR TO THE CONTRACTING OFFICER.

	E101							
			ARINE CORPS BASE CAMP LEJEUNE, NORTH CAROLINA					
DES.	K. BROWN	BUILDING AS2818						
DR.	K. BROWN							
CHK.	K. BROWN	HEAD REPAIRS						
SUBMITTED BY:	M. HUNTER	SITE AND DEMOLITION PLAN						
DESIGN DIR.	J.F. ORR		SIIE	AND DEMOLITI	ON FLAN			
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LIGHTING PLAN - NEW WORK

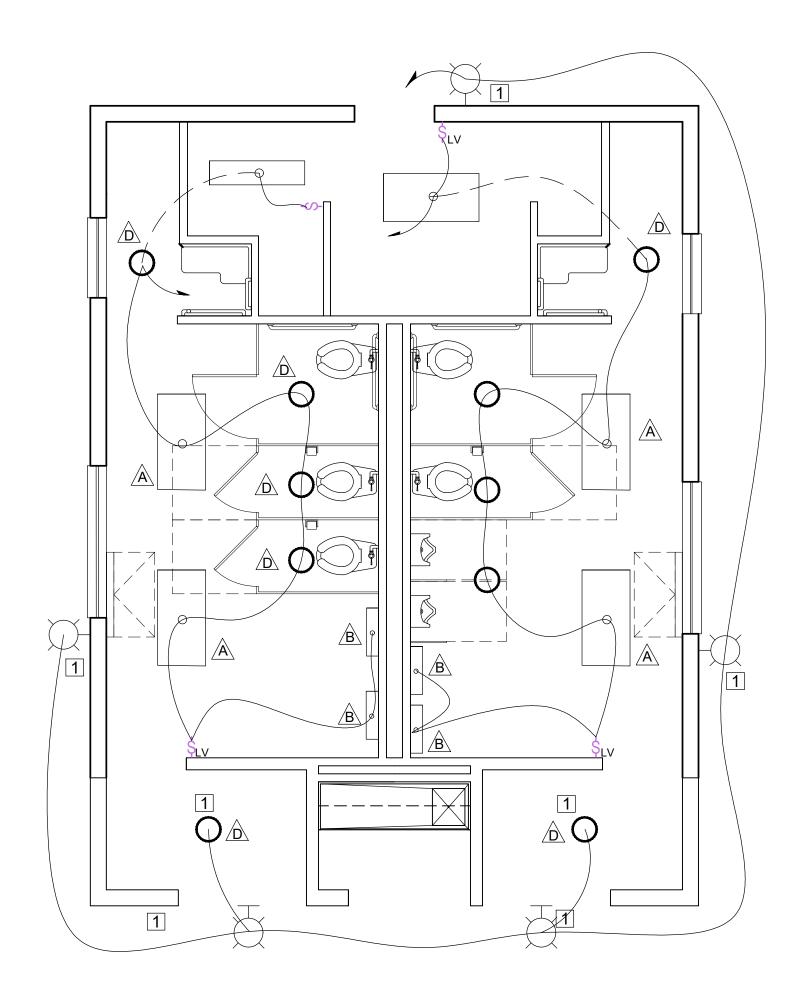
SCALE: NTS

LIGHTING PLAN GENERAL NOTES

- 1. PROVIDE NEW LIGHTING PLAN AS INDICATED. SEE LIGHTING FIXTURE SCHEDULE & LUMINAIRE PLATES.
- 2. SEE PANELBOARD SCHEDULE FOR CIRCUIT DETAILS.
- 3. PROVIDE NEW LUMINAIRE(S) & CIRCUIT(S) AS INDICATED. MIN. 2 #12, 1 #12 EGC IN 1/2" C. FLUSH IN NEW WALLS. 4. PROVIDE OCCUPANCY SENSORS TO CONTROL LIGHTING. SEE OCCUPANCY SENSOR DIAGRAM. OCCUPANCY
- SENSORS ARE NOT SHOWN ON DRAWINGS FOR CLARITY.

KEYED NOTES

1 LUMAINAIRE MUST BE PHOTOCONTROLLED. LOCATE PHOTOCELL TO ENSURE PROPER OPERATION.

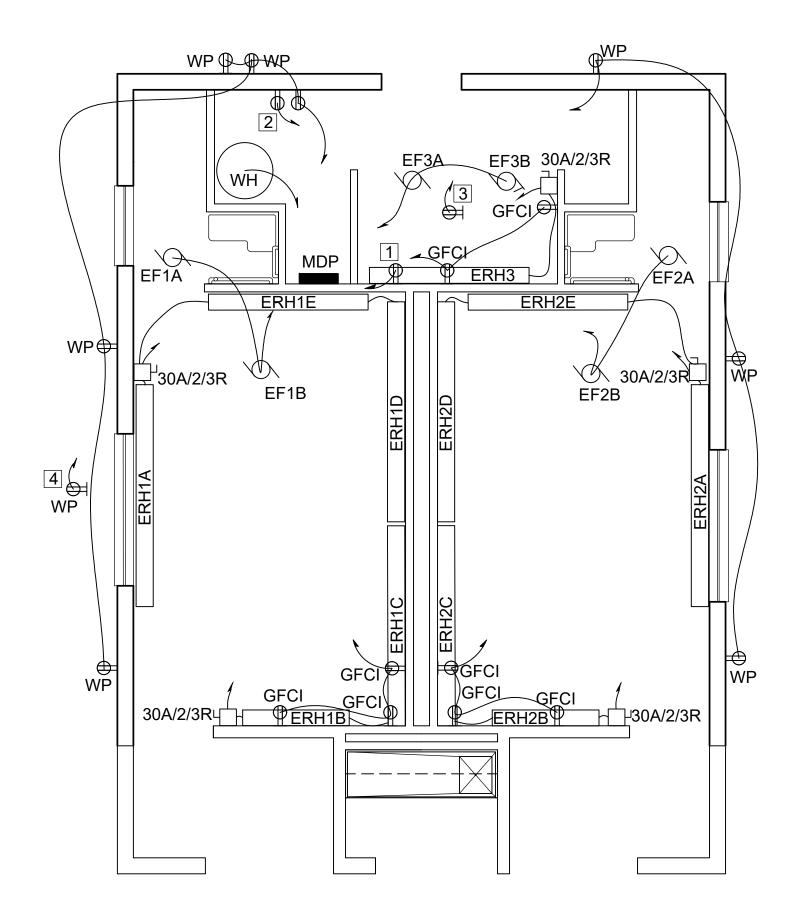

POWER PLAN - NEW WORK

SCALE: NTS

POWER PLAN GENERAL NOTES

- PROVIDE NEW POWER PLAN AS INDICATED ABOVE.
- 2. PROVIDE NEW BRANCH CIRCUIT CONDUCTORS IN CONDUIT TO NEW MDP PANELBOARD. SEE PANELBOARD SCHEDULE FOR CIRCUIT NUMBERS AND DETAILS.
- 3. PROVIDE NEW RECEPTACLES & CIRCUIT(S) AS INDICATED. MIN. 2 #12, 1 #12 EGC IN ½" C. FLUSH IN NEW
- WALLS. SURFACE MOUNT ON EXISTING INTERIOR BLOCK WALLS.

 4. PROVIDE NEW PANELBOARD MDP; SEE PANELBOARD SCHEDULE.
- 5. PROVIDE NEMA 14-30R FOR DRYER RECEPTACLE & CIRCUIT. 3-#10, 1#10 EGC IN $\frac{3}{4}$ " C.
- 6. PROVIDE EXHAUST FAN CIRCUIT(S) AS INDICATED. PROVIDE DISCONNECT SWITCH IN ATTIC SPACE.
- MIN. 2 #12, 1 #12 EGC IN $\frac{1}{2}$ C.
 7. PROVIDE NEW CIRCUIT FOR WATER HEATER AS INDICATED. COORDINATE WITH MECHANICAL SHEETS.
 MIN. 2-#10, 1#10 EGC IN $\frac{3}{4}$ " C.
- 8. PROVIDE NEW (2) $\frac{3}{4}$ "X10' COPPER GROUND RODS. PROVIDE GROUNDING SYSTEM TO MDP IN ACCORDANCE WITH NEC. SEE GROUNDING DETAILS.
- 9. PROVIDE CIRCUITS, CONDUIT, AND BREAKERS TO SUPPORT HARDWIRED AUTOMATIC FLUSHERS AND
- FAUCETS IN COORDINATION WITH MECHANICAL SHEET REQUIREMENTS.

 10. PROVIDE DISCONNECTS FOR HEATING DEVICES AS REQUIRED.
- 11. PROVIDE NEW CIRCUITS FOR RADIANT HEATERS AS INDICATED. MIN. 2-#10, 1#10 EGC IN $\frac{3}{4}$ " C. COORDINATE REQUIREMENTS WITH MECHANICAL SHEETS. SEE PANELBOARD SCHEDULE FOR BREAKER AND CIRCUIT
- DETAILS.

 12. PROVIDE NEW CIRCUIT TO BACKFLOW HEATTRACE AND SUPPORTING CIRCUITS. SEE CIVIL AND
- MECHANICAL SHEETS FOR DETAILS. MIN. 2-#12, 1-#12 EGC IN $\frac{1}{2}$ "C. (APPROX. 50 FT FROM PANELBOARD) 13.EXHAUST FANS IDENTIFIED WITH AN "A" LABEL MUST BE OPERATED BY THE OCCUPANCY SENSOR / LIGHTING

KEYED NOTES


1 PROVIDE DRYER RECEPTACLE. NEMA 14-30R. 3 - #10, 1 - #10 EGC IN $\frac{3}{4}$ " CONDUIT.

CONTROLS. EXHAUST FANS "A" MUST TURN ON WHEN LIGHTING IS ACTIVATED.

- 2 PROVIDE DEDICATED DUPLEX RECEPTACLE FOR FUTURE COMMUNICATION BACKBOARD . (2-#12,1-#12 EGC. IN $\frac{1}{2}$ "C.)
 3 PROVIDE DEDICATED DUPLEX RECEPTACLE FOR SECURITY CAMERA. FLUSH MOUNT IN CEILING. (2-#12, 1-#12 EGC.
- 4 PROVIDE DEDICATED DUPLEX WEATHERPROOF RECEPTACLE FOR SECURITY CAMERA. MOUNT UNDERNEATH SOFFIT. (2-#12,1-#12 EGC. IN $\frac{1}{2}$ "C.)

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					PS BASE			
DES.	K. BROWN		RH	ILDING AS	32818			
DR.	K. BROWN							
CHK.	K. BROWN		Н	EAD REPA	AIRS			
SUBMITTED BY:	M. HUNTER		LICUT	ING AND POW	/ED DIAN			
DESIGN DIR.	J.F. ORR		ЦСП	ING AND POW	ER PLAN			
APPROVED: PWO OR OICC:	DATE:	SIZE	CODE IDENT. NO	NAVF	AC DRAWING NO.			
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NOTE: THIS SKETCH IS A NON-PROPRIETARY GRAPHIC REPRESENTATION OF A LUMINAIRE THAT MAY MEET THE SPECIFICATION REQUIREMENTS. IT IS NOT INTENDED TO INDICATE A CERTAIN MANUFACTURER OR

LUMINAIRE REQUIREMENTS:

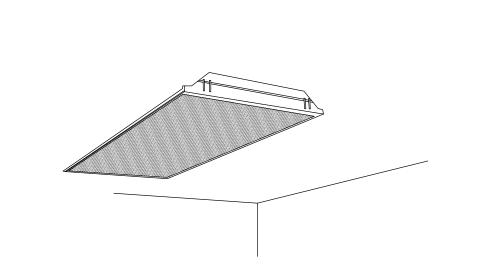- 1. HOUSING DIE-FORMED, COLD ROLLED STEEL. SIZE AS INDICATED IN LUMINAIRE
- 2. OPTICS ACRYLIC OR POLYCARBONATE LENS AS INDICATED IN LUMINAIRE SCHEDULE.
- 3. LIGHT SOURCE SOLID STATE LEDS, 3500K CCT UON, MINIMUM 80 CRI UON, AND MINIMUM EFFICACY OF 100 LUMENS/WATT UON. INITIAL LUMEN OUTPUT AS INDICATED IN LUMINAIRE SCHEDULE.
- 4. DRIVER REPLACEABLE, INTEGRAL, HIGH-EFFICIENCY DRIVER WITH MINIMUM 0.9 PF, OPERATING VOLTAGE OF 120-277V, THERMAL MANAGEMENT, AND < 20% THD. ON/OFF CONTROL AND FULLY DIMMABLE DOWN TO 10% MINIMUM OR AS
- 5. CERTIFICATION UL LISTED FOR DRY OR DAMP LOCATION, ROHS COMPLIANT, DLC QUALIFIED. COMPLIES WITH IES LM79, LM80 AND TM21 TESTING STANDARDS.
- 6. MOUNTING RECESSED IN HARD OR ACOUSTICAL TILE CEILING.

INDICATED IN LUMINAIRE SCHEDULE.

7. OPTIONS - EDGE-LIT LENS, PRISMATIC LENS. EMERGENCY BATTERY BACK-UP, INTEGRAL OCCUPANCY/VACANCY SENSOR, VARIOUS SIZE AND OUTPUT OPTIONS, SURFACE-MOUNTING KIT.

FLAT LENS LED LUMINAIRE

LUMINAIRE REQUIREMENTS:

INDICATED IN LUMINAIRE SCHEDULE.

MOUNTING IN HARD CEILINGS.

ANGLES. IC RATED HOUSING.

HARDWARE.

LUMINAIRE REQUIREMENTS:

INDICATED IN LUMINAIRE SCHEDULE.

MINIMUM OR AS INDICATED IN LUMINAIRE SCHEDULE.

WITH IES LM79, LM80 AND TM21 TESTING STANDARDS.

7. OPTIONS - VARIOUS LENSES, BODY SHAPES, AND STYLES.

6. MOUNTING - SURFACE MOUNTED WITH STAINLESS STEEL MOUNTING



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HOUSING - COLD-ROLLED STEEL OR DIE CAST ALUMINUM, WITH HEAT SINK.

2. LIGHT SOURCE - SOLID STATE LEDS, 3500K CCT UON, MINIMUM 80 CRI UON, AND

MINIMUM EFFICACY OF 70 LUMENS/WATT UON. INITIAL LUMEN OUTPUT AS

3. DRIVER - REPLACEABLE, INTEGRAL, HIGH-EFFICIENCY DIMMABLE DRIVER WITH

AND < 20% THD. ON/OFF CONTROL AND FULLY DIMMABLE DOWN TO 10%

4. CERTIFICATION - UL LISTED FOR DRY OR DAMP LOCATION, ROHS COMPLIANT.

MOUNTING - RECESSED IN HARD OR ACOUSTICAL TILE CEILING. PROVIDE T-BAR

HANGERS FOR INSTALLATION IN ACOUSTICAL TILE CEILINGS OR TABS WHEN

POLYCARBONATE LENSES, REFLECTORS, LOUVERS AND TRIMS. VARIOUS BEAM

SERVICE EQUIPMENT GROUND BAR

10'-0"

(MIN.)

COMPLIES WITH IES LM79, LM80 AND TM21 TESTING STANDARDS.

6. OPTIONS - EMERGENCY BATTERY BACK-UP, VARIOUS ACRYLIC OR

MINIMUM 0.9 PF, OPERATING VOLTAGE OF 120-277V, THERMAL MANAGEMENT,

APERTURE SIZE AND SHAPE AS INDICATED IN LUMINAIRE SCHEDULE.

THE SPECIFICATION REQUIREMENTS. IT IS NOT INTENDED TO INDICATE A CERTAIN MANUFACTURER OR

NOTE: THIS SKETCH IS A NON-PROPRIETARY GRAPHIC REPRESENTATION OF A LUMINAIRE THAT MAY MEET

1. HOUSING - DIE-CAST ALUMINUM HOUSING WITH POWDER COAT FINISH.

THE SPECIFICATION REQUIREMENTS. IT IS NOT INTENDED TO INDICATE A CERTAIN MANUFACTURER OR

2. OPTICS - DIFFUSE VANDAL-RESISTANT ACRYLIC LENS. BUG UPLIGHT RATING OF

3. LIGHT SOURCE - SOLID STATE LEDS, 3000K CCT UON, MINIMUM 80 CRI UON, AND

4. DRIVER - REPLACEABLE, INTEGRAL, HIGH-EFFICIENCY DIMMABLE DRIVER WITH


AND < 20% THD. ON-OFF CONTROL AND FULLY DIMMABLE DOWN TO 10%

5. CERTIFICATION - UL LISTED FOR WET LOCATION, ROHS COMPLIANT. COMPLIES

MINIMUM 0.9 PF, OPERATING VOLTAGE OF 120 OR 277V, THERMAL MANAGEMENT,

MINIMUM EFFICACY OF 50 LUMENS/WATT UON. INITIAL LUMEN OUTPUT AS

U0, WITH GLARE RATING AS DETERMINED BY LIGHTING ZONE INSTALLED.

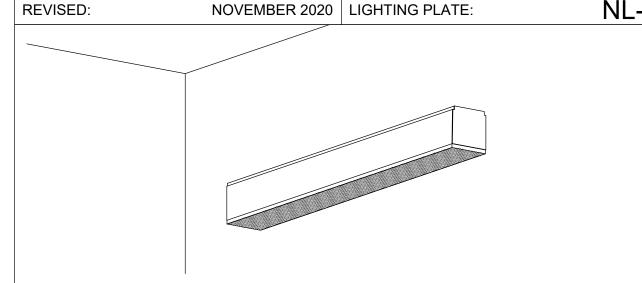

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LUMINAIRE REQUIREMENTS:

- 1. HOUSING COLD ROLLED STEEL, EXTRUDED ALUMINUM, OR DIE CAST ALUMINUM BODY WITH DIE CAST END CAPS AND STAINLESS STEEL HARDWARE. SIZE AS INDICATED IN LUMINAIRE SCHEDULE.
- 2. OPTICS REFRACTIVE LENS OPTIMIZED FOR ASYMMETRIC DISTRIBUTION.
- 3. LIGHT SOURCE SOLID STATE LEDS, 3500K CCT UON, MINIMUM 80 CRI UON, AND MINIMUM EFFICACY OF 85 LUMENS/WATT UON. INITIAL LUMEN OUTPUT AS INDICATED IN LUMINAIRE SCHEDULE.
- DRIVER REPLACEABLE, INTEGRAL, HIGH-EFFICIENCY DIMMABLE DRIVER WITH MINIMUM 0.9 PF, OPERATING VOLTAGE OF 120-277V, THERMAL MANAGEMENT, AND < 20% THD. ON/OFF CONTROL AND FULLY DIMMABLE DOWN TO 10% MINIMUM OR AS INDICATED IN LUMINAIRE SCHEDULE.
- 5. CERTIFICATION UL LISTED FOR DAMP LOCATION, ROHS COMPLIANT. COMPLIES WITH IES LM79, LM80 AND TM21 TESTING STANDARDS.
- 6. MOUNTING WALL SURFACE MOUNTED
- 7. OPTIONS EMERGENCY BATTERY BACK-UP, AND VARIOUS PROFILE DIMENSIONS AND RUN LENGTHS. ALSO AVAILABLE WITH INDIRECT LIGHTING ELEMENT.

DIRECT WALL-MOUNTED LINEAR NL-7 NOVEMBER 2020 | LIGHTING PLATE: REVISED:

FIXED RECESSED DOWNLIGHT


MINIMUM OR AS INDICATED IN LUMINAIRE SCHEDULE.


CONNECTION -

3/4" X 10'


GROUND ROD -

SCALE: NTS NL-12 NOVEMBER 2020 | LIGHTING PLATE: JUMPER SIZED PER NEC

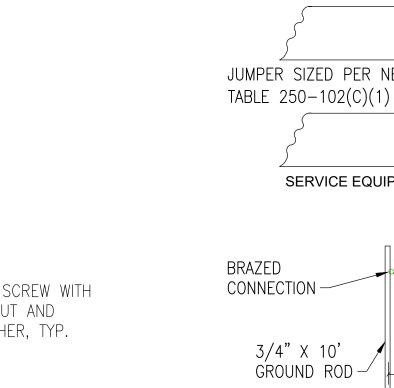

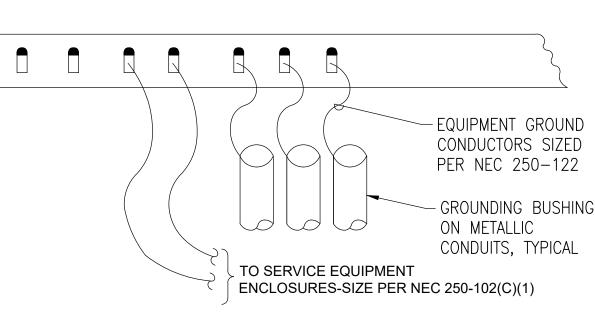

GENERAL SERVICE GROUND DETAIL SCALE: NTS

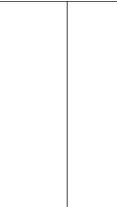

XL-9 REVISED:


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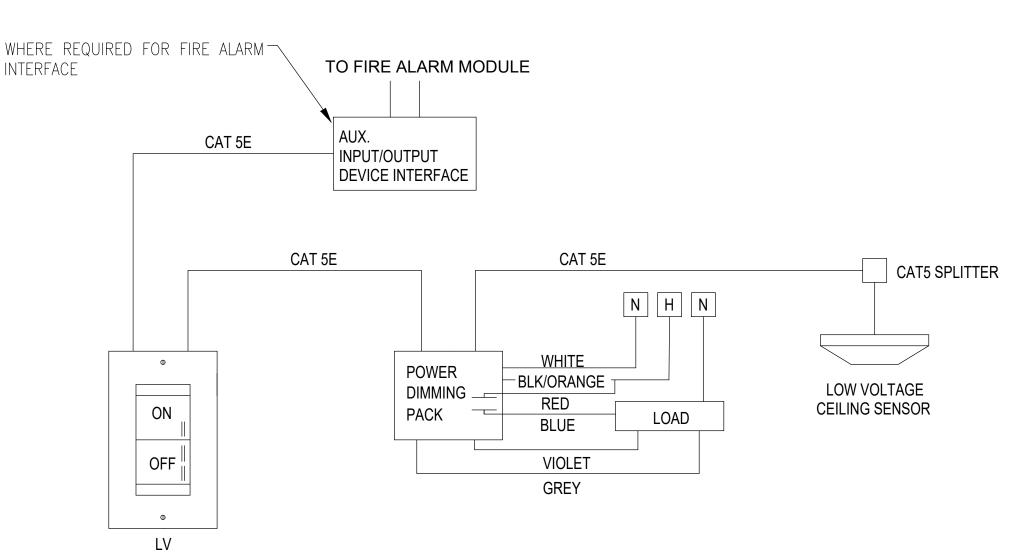
- 1. HOUSING EXTRUDED ALUMINUM OR WELDED STEEL HOUSING WITH SNAP-ON END CAPS. SIZE AS INDICATED IN LUMINAIRE SCHEDULE.
- OPTICS DIFFUSE ACRYLIC LENS.
- 3. LIGHT SOURCE SOLID STATE LEDS, 3500K CCT UON, MINIMUM 80 CRI UON, AND MINIMUM EFFICACY OF 90 LUMENS/WATT UON. INITIAL LUMEN OUTPUT AS INDICATED IN LUMINAIRE SCHEDULE.
- 4. DRIVER REPLACEABLE, INTEGRAL, HIGH-EFFICIENCY DIMMABLE DRIVER WITH MINIMUM 0.9 PF, OPERATING VOLTAGE OF 120-277V, THERMAL MANAGEMENT, AND < 20% THD. ON/OFF CONTROL AND FULLY DIMMABLE DOWN TO 10% MINIMUM OR AS INDICATED IN LUMINAIRE SCHEDULE.
- CERTIFICATION UL LISTED FOR DAMP OR WET LOCATION, ROHS COMPLIANT. DLC QUALIFIED. COMPLIES WITH IES LM79, LM80 AND TM21 TESTING STANDARDS.
- 6. MOUNTING PENDANT, STEM, OR SURFACE MOUNTED WITH STAINLESS STEEL MOUNTING HARDWARE.
- 7. OPTIONS INTEGRAL OCCUPANCY SENSOR, EMERGENCY BATTERY BACK-UP, VARIOUS PROFILE DIMENSIONS AND RUN LENGTHS, AND VARIOUS CLEAR OR FROSTED POLYCARBONATE LENSES.

LED INDUSTRIAL LIGHT

NL-23 NOVEMBER 2020 | LIGHTING PLATE:



LIG	HTING FIXTURE SCHEDULE					
MARK	DESCRIPTION	SIZE/TYPE	VOLTS	LAMPS	WATTS	COLOR
À	NL-2, FLAT LENS LED LUMINAIRE	2x4 FLUSH MOUNT	120V	LED 3500K 4000 LUMENS	33	WHITE
B	NL-7, WALL MOUNTED LINEAR	2' VANITY LIGHT	120V	LED 3500K 500 LUMEN	7	WHITE
Ĉ	NL-9, DECORATIVE LED WALL SCONCE W/ PHOTOCELL U.L. LISTED FOR WET LOCATIONS	VARIES	120V	LED 3500K 640 LUMENS	7	WHITE
À	NL-12, RECESSED DOWNLIGHT U.L. LISTED FOR WET LOCATIONS.	6" LED DOWNLIGHT	120V	LED 3500K 500 LUMENS	7	WHITE
Ê	NL-23, LED INDUSTRIAL LIGHT WET LOCATION RATED, SURFACE MOUNTED	4' STRIP	120V	LED 3500K 3000 LUMEN	30	WHITE

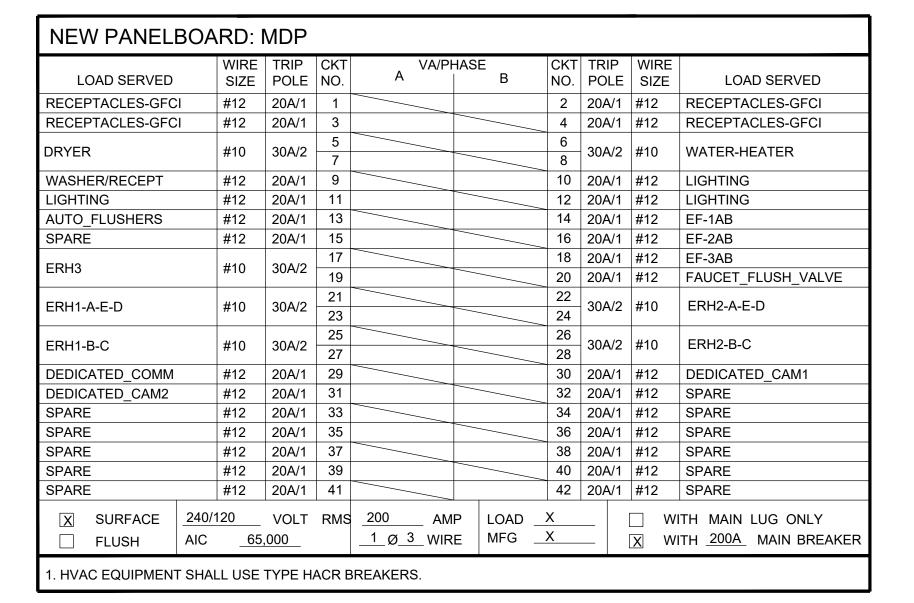

CEILING OCCUPANCY/VACANCY SENSOR DIMMING DIAGRAM

OPERATION SEQUENCE

ILLUMINATE TO 100% PER OCCUPANCY SENSOR SIGNAL. OTHER SPACES MUST BE PROGRAMMED TO 50% AUTO ON PER OCCUPANCY SENSOR SIGNAL. VACANCY SENSOR IS MANUAL ON.

COORIDORS, LOBBIES, VESTIBULES, TOILET ROOMS, MUST

- 2. LIGHT FIXTURE MUST CONTINUOUSLY DIM/BRIGHTEN BASED UPON INPUT FROM THE DIMMER.
- 3. AFTER 15 MINUTES OF NO OCCUPANCY, LIGHT FIXTURE MUST TURN

POWER RISER DETAIL

PANEL

MDP


240/120V,

1Ø, 3W 200A

ROOF

DISCLOSURE OF INFORMATION CONTRACTOR SHALL COMPLY AS FOLLOWS:

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PROVIDE NEW OVERHEAD SERVICE CONDUCTORS

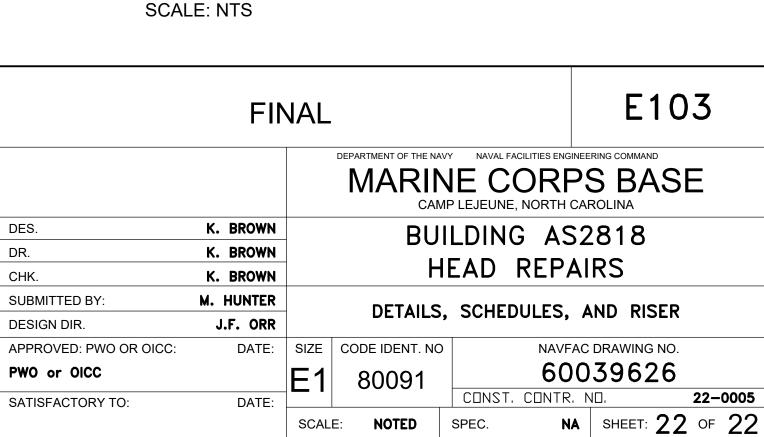PROVIDE **NEW SERVICE**

CONDUCTORS

PROVIDE

GROUNDING


PER NEC 250

& CONDUIT

PROVIDE NEW WEATHERHEAD

PROVIDE NEW

PANELBOARD

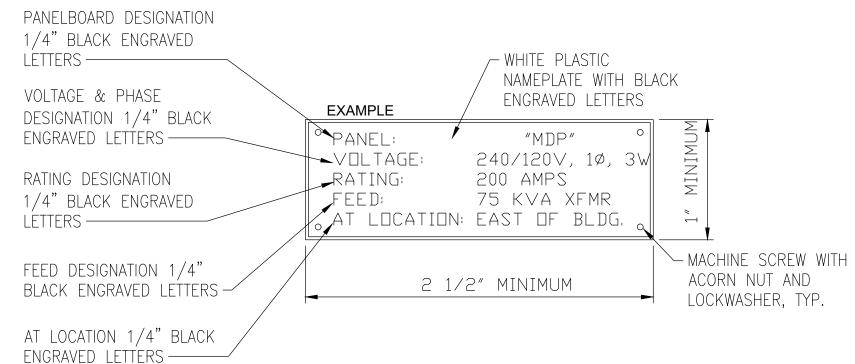

PANELBOARD NAMEPLATE DETAIL SCALE: NTS